
















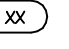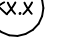



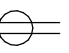

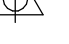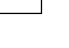


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1	Foodservice Sheet Index N.T.S.	<div><div>1.</div><div>GENERAL CONTRACTOR TO CUT AND PROVIDE HOLES THROUGH CEILING, ROOFS, WALLS, &amp; FLOORS FOR DUCTS, ETC, IN ACCORDANCE WITH LOCAL FIRE &amp; BUILDING CODES AND IN ACCORDANCE WITH DUCT SIZES SPECIFIED. GENERAL CONTRACTOR TO PROVIDE OF ALL HOLES (INCLUDING THE "MAPPING-IN" OF FAN CURBS AND ROOF JACKS.) GENERAL CONTRACTOR TO PROVIDE ALL DUCT FIRE SEPARATION ENCLOSURES, WRAPPING, ETC. AS MAY BE REQUIRED BY LOCAL FIRE &amp; BUILDING CODES. GENERAL CONTRACTOR TO VERIFY WITH BUILDING OWNER IF ROOF WARRANTY AGENT OF RECORD IS REQUIRED FOR CUTOUTS.</div></div> <div><div>2.</div><div>WHERE NOISE AND/OR VIBRATION PRODUCING EQUIPMENT (DISH MACHINE, DISPOSER, ETC. IS LOCATED ADJACENT TO DINNING AREAS AND/OR ANY PUBLIC AREAS, PROVISIONS SHOULD BE MADE BY THE GENERAL CONTRACTOR TO "DOUBLE STUD" AND SOUND PROOF COMMON WALLS.</div></div> <div><div>3.</div><div>OF CANTILEVER BRACKETS FOR TABLE &amp; STOOL SEATS OR OTHER EQUIPMENT ARE SPECIFIED, THE BRACKETS SHALL BE PROVIDED BY FURNITURE VENDOR BUT INSTALLED BY GENERAL CONTRACTOR IN ACCORDANCE WITH SPECIFICATION AND DIMENSIONS PROVIDED BY KATOM RESTAURANT SUPPLY INC. AND/OR THE OWNER.</div></div> <div><div>4.</div><div>KATOM RESTAURANT SUPPLY INC. PLANS ARE PROVIDED FOR THE SOLE PURPOSE OF INDICATING OUTLET LOCATIONS &amp; EQUIPMENT REQUIREMENTS ONLY AND DO NOT RELIEVE THE GENERAL CONTRACTOR OR SUBCONTRACTOR OF THE RESPONSIBILITY OR COMPLYING WITH ALL APPLICABLE CODES. PLEASE SEE ARCHITECT'S DRAWINGS FOR ALL OTHER REQUIREMENTS AND CODES.</div></div> <div><div>5.</div><div>IT IS THE RESPONSIBILITY OF THE OWNER, ARCHITECT AND/OR GENERAL CONTRACTOR TO INFORM KATOM RESTAURANT SUPPLY INC. IN WRITING OF ANY AND ALL CHANGES AND ADDENDUM'S TO THE PLANS WHICH ARE MADE PRIOR TO AND DURING CONSTRUCTION. KATOM RESTAURANT SUPPLY INC. ASSUMES NO RESPONSIBILITY FOR EQUIPMENT DEVIATIONS OF SIZE AND/OR UTILITIES FROM LACK OF INFORMATION. THE OWNER WILL BE RESPONSIBLE FOR ALL COSTS INCURRED BY FAILURE TO FIVE KATOM RESTAURANT SUPPLY INC. NOTICES OF SAID CHANGES.</div></div> <div><div>6.</div><div>LAST DATED REVISIONS VOID ALL PREVIOUS PLANS.</div></div> <div><div>7.</div><div>GENERAL CONTRACTOR TO PROVIDE FLOOR RECESSES (FLAT &amp; LEVEL), VAPOR BARRIERS, AND BUILT-IN INSULATED FLOORS (AS SHOWN ON PLANS). IF APPLICABLE.</div></div> <div><div>8.</div><div>WEARING FLOOR FINISH AND COVE BASE IN WALK-IN BOXES TO BE PROVIDED BY GENERAL CONTRACTOR UNLESS OTHERWISE SPECIFIED BY KATOM RESTAURANT SUPPLY INC. AND/OR OWNER.</div></div> <div><div>9.</div><div>SLEEVES TO BE PROVIDED BY GENERAL CONTRACTOR IN WALLS, FLOORS, &amp; CEILING FOR LINES (DRAINS, REFRIGERATION, ETC.) TO PASS THROUGH AND RESEAL AFTER LINES ARE RUN.</div></div> <div><div>10.</div><div>GENERAL CONTRACTOR TO PROVIDE ACCESS TO HOODS AT AREA ABOVE ABOVE HOODS FOR MOUNTING OF HOOD SUPPORTS. IF ACCESS IS NOT PROVIDED GENERAL CONTRACTOR TO PROVIDE HOOD SUPPORTS.</div></div> <div><div>11.</div><div>GENERAL CONTRACTOR TO PROVIDE SPRINKLER HEADS IN WALK-IN BOXES ADEQUATELY PROTECTED AGAINST FREEZING.</div></div> <div><div>12.</div><div>REMOVAL OF WINDOW GLASS, WINDOW FRAMES, DOORS, DOOR FRAMES, &amp; CENTER POSTS FOR ENTRY OF EQUIPMENT SHALL BE THE RESPONSIBILITY OF THE GENERAL CONTRACTOR AND AT NO EXPENSE TO THE K.E.C.</div></div> <div><div>13.</div><div>GENERAL CONTRACTOR TO PROVIDE ALL WALL BACKING PER LOCATION AND SPECIFIED BY KATOM RESTAURANT SUPPLY INC..</div></div> <div><div>14.</div><div>ALL DIMENSIONS SHOWN ARE MEASURED FROM FINISHED WALLS, FLOORS, CEILINGS, AND/OR COLUMNS TO CENTER LINES OF STUBS OR OUTLETS. ALLOWANCES SHALL BE MADE FOR MISCELLANEOUS OBSTRUCTIONS, STRUCTURES, VENTING, ELECTRICAL, PLUMBING, &amp; THICKNESS OF FINISHES WHEN FRAMING AND/OR ROUGHING-IN AS REQUIRED.</div></div> <div><div>15.</div><div>WHEN EQUIPMENT IS NOTED AS EXISTING OR BY VENDOR/OWNER, UTILITY REQUIREMENTS SHOULD MATCH AS INDICATED ON THE MANUFACTURERS DATA PLATE. IF EXISTING EQUIPMENT IF NOT RELOCATED, RECONNECT AS REQUIRED IN ACCORDANCE WITH APPLICABLE CODES.</div></div> <div><div>16.</div><div>WHERE INDICATED TO CONNECT IN OR THROUGH VALVE COMPARTMENT, CONTRACTOR SHALL STUB-UP INTO VALVE COMPARTMENT AT HEIGHT INDICATED ON ROUGH-IN PLAN, CAP THEIR WORK AND MAKE FINAL CONNECTIONS AFTER EQUIPMENT IS IN PLACE.</div></div> <div><div>17.</div><div>GENERAL CONTRACTOR TO PROVIDE WASTE CONTAINER(S) AT JOB SITE FOR K.E.C. UNLESS OTHERWISE NOTED BY KATOM RESTAURANT SUPPLY INC.</div></div> <div><div>18.</div><div>GENERAL CONTRACTOR TO PROVIDE ALL HAND HELD FIRE EXTINGUISHERS. INCLUDING KITCHEN CLASS K MODEL(S).</div></div>																																																																																																																																																																																																																																																																																																																																																																					
3	General Contractor Notes N.T.S.	<div><div>1.</div><div>FOOD SERVICE EQUIPMENT DESIGN, CONSTRUCTION, AND INSTALLATION SHALL BE IN COMPLIANCE WITH APPLICABLE BUILDING AND HEALTH CODES FOR THIS LOCATION.</div></div> <div><div>2.</div><div>ALL WALLS, CEILINGS, AND FLOORS WITHIN FOOD PREPARATION AND WAREWASH AREAS SHALL BE CONSTRUCTED WITH LIGHT-COLORED, SMOOTH, NON-ABSORBENT, AND EASILY CLEANABLE MATERIALS.</div></div> <div><div>3.</div><div>ARTIFICIAL LIGHTING FIXTURES OVER FOOD PREPARATION AREAS SHALL HAVE PROTECTIVE SHIELDING. 50 FOOT CANDLES SHALL BE PROVIDED TO ALL WORK SURFACES AND A MINIMUM OF 30 FOOT CANDLES SHALL BE PROVIDED TO ALL WORK SURFACES IN FOOD PREPARATION, WAREWASHING, AND HANDWASH AREAS.</div></div> <div><div>4.</div><div>AREAS OVER WALK-IN COOLERS/FREEZERS AND HOODS SHALL BE FULLY ENCLOSED TO THE CEILING.</div></div> <div><div>5.</div><div>POT WASH SINK SHALL BE THREE COMPARTMENT, EACH COMPARTMENT TO MEASURE A MINIMUM OF 15" X 15" AND TO MAINTAIN A MINIMUM WATER DEPTH OF 12". SINK TO BE CONSTRUCTED IN COMPLIANCE WITH N.S.F. STANDARD 2 AND BEAR N.S.F. SEAL. EACH SINK BOWL SHALL HAVE FULLY COVERED ROUNDED CORNERS.</div></div> <div><div>6.</div><div>ALL POISONOUS OR TOXIC MATERIALS SHALL BE STORED IN CABINETS OR IN SIMILAR PHYSICALLY SEPARATED COMPARTMENTS SPECIFICALLY USED FOR THIS PURPOSE.</div></div> <div><div>7.</div><div>WALK-IN COOLERS AND FREEZERS TO BE SUPPLIED WITH ADDITIONAL INTERIOR LIGHTING. ADDITIONAL FIXTURE(S) SUPPLIED SHALL BE SUFFICIENT TO MAINTAIN 50 FOOT CANDLES WITHIN THE COOLER AND/OR FREEZER COMPARTMENTS.</div></div>																																																																																																																																																																																																																																																																																																																																																																					
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AIR CONDITIONING</td><td>TOW</td><td>TOP OF WALK-IN</td></tr><tr><td></td><td></td><td>TV</td><td>TELEVISION</td></tr><tr><td>HW</td><td>HOT WATER</td><td>TYP</td><td>TYPICAL</td></tr><tr><td></td><td></td><td></td><td></td></tr><tr><td>ID</td><td>INSIDE DIAMETER</td><td>UDS</td><td>UTILITY DISTRIBUTION SYSTEM</td></tr><tr><td>IN.</td><td>INCH</td><td>UNFIN</td><td>UNFINISHED</td></tr><tr><td>INCL</td><td>INCLUDE</td><td>UNK</td><td>UNKNOWN</td></tr><tr><td>INST</td><td>INSTALL(ATION)</td><td></td><td></td></tr><tr><td>INSUL</td><td>INSULATE(ION)</td><td>VAC</td><td>VACUUM</td></tr><tr><td>INT</td><td>INTERIOR</td><td>VERT</td><td>VERTICAL</td></tr><tr><td>IW</td><td>INDIRECT WASTE</td><td>V</td><td>VOLTAGE</td></tr><tr><td></td><td></td><td>VIF</td><td>VERIFY IN FIELD</td></tr><tr><td>JAN</td><td>JANITOR</td><td></td><td></td></tr><tr><td>JB</td><td>JUNCTION BOX</td><td>W/</td><td>WITH</td></tr><tr><td>JC</td><td>JANITOR'S CLOSET</td><td>W/O</td><td>WITHOUT</td></tr><tr><td></td><td></td><td>WH</td><td>WATER HEATER</td></tr><tr><td>KEC</td><td>KITCHEN EQUIPMENT CONTRACTOR</td><td>WL</td><td>WALL</td></tr><tr><td>KTN</td><td>KITCHEN</td><td>WP</td><td>WEATHER PROOF</td></tr><tr><td>KW</td><td>KILOWATT HOUR</td><td>WT</td><td>WEIGHT</td></tr></table>		ADJ	ADJUSTABLE	LAM	LAMINATE	AFF	ABOVE FINISHED FLOOR	LBS	POUNDS	ALT	ALTERNATE	LKR	LOCKER	ALUM	ALUMINUM	LT	LIGHT	AMP	AMPERE	LVR	LOUVER	ANSI	AMERICAN NATIONAL STANDARDS INSTITUTE	MAX	MAXIMUM			MBTUH	1 000 BTU/HOUR	BLDG	BUILDING	MECH	MECHANICAL	BTC	BRANCH TO CONNECTION	MIN	MINIMUM	BTU	BRITISH THERMAL UNIT	MISC	MISCELLANEOUS			MTD	MOUNTED	C#P	CORD AND PLUG	MTL	METAL	CBT	CABINET	MUL	MULLION	CFM	CUBIC FEET PER MINUTE			CL	CENTER LINE	NA	NOT APPLICABLE	CLG	CEILING	NIC	NOT IN CONTRACT	CMU	CONCRETE MASONRY UNIT	NO.	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GPM	GALLONS PER MINUTE	SUP	SUPPLY																																																																																																																																																																																																																																																																																																																																																																				
HGT	HEIGHT	TEL	TELEPHONE																																																																																																																																																																																																																																																																																																																																																																				
HP	HORSEPOWER	TOH	TOP OF HOOD																																																																																																																																																																																																																																																																																																																																																																				
HVAC	HEATING, VENTILATING & AIR CONDITIONING	TOW	TOP OF WALK-IN																																																																																																																																																																																																																																																																																																																																																																				
		TV	TELEVISION																																																																																																																																																																																																																																																																																																																																																																				
HW	HOT WATER	TYP	TYPICAL																																																																																																																																																																																																																																																																																																																																																																				
ID	INSIDE DIAMETER	UDS	UTILITY DISTRIBUTION SYSTEM																																																																																																																																																																																																																																																																																																																																																																				
IN.	INCH	UNFIN	UNFINISHED																																																																																																																																																																																																																																																																																																																																																																				
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INSUL	INSULATE(ION)	VAC	VACUUM																																																																																																																																																																																																																																																																																																																																																																				
INT	INTERIOR	VERT	VERTICAL																																																																																																																																																																																																																																																																																																																																																																				
IW	INDIRECT WASTE	V	VOLTAGE																																																																																																																																																																																																																																																																																																																																																																				
		VIF	VERIFY IN FIELD																																																																																																																																																																																																																																																																																																																																																																				
JAN	JANITOR																																																																																																																																																																																																																																																																																																																																																																						
JB	JUNCTION BOX	W/	WITH																																																																																																																																																																																																																																																																																																																																																																				
JC	JANITOR'S CLOSET	W/O	WITHOUT																																																																																																																																																																																																																																																																																																																																																																				
		WH	WATER HEATER																																																																																																																																																																																																																																																																																																																																																																				
KEC	KITCHEN EQUIPMENT CONTRACTOR	WL	WALL																																																																																																																																																																																																																																																																																																																																																																				
KTN	KITCHEN	WP	WEATHER PROOF																																																																																																																																																																																																																																																																																																																																																																				
KW	KILOWATT HOUR	WT	WEIGHT																																																																																																																																																																																																																																																																																																																																																																				
6	Graphic Symbols N.T.S.	<div><div></div><div>CENTER LINE</div></div> <div><div></div><div>REVISION TAG</div></div> <div><div></div><div>EQUIPMENT TAG</div></div> <div><div></div><div>ELEVATION MARKER</div></div> <div><div></div><div>COLUMN GRID</div></div> <div><div></div><div>FIELD WIRING TO CONNECTION POINT ON EQUIPMENT</div></div> <div><div></div><div>DROP RECEPTACLE ON COARD FROM ABOVE</div></div> <div><div></div><div>DUPLEX RECEPTACLE -GFCI</div></div> <div><div></div><div>DUPLEX RECEPTACLE - GROUND TYPE</div></div> <div><div></div><div>SINGLE RECEPTACLE - GROUND TYPE</div></div> <div><div></div><div>SIMPLEX RECEPTACLE - GROUND TYPE</div></div> <div><div></div><div>ELECTRICAL STUB-UP / CONDUIT</div></div> <div><div></div><div>DISCONNECT SWITCH</div></div> <div><div></div><div>SPECIAL PURPOSE OUTLET, AS INDICATED, GROUND TYPE</div></div> <div><div></div><div>JUNCTION BOX</div></div> <div><div></div><div>HW - HOT WATER</div></div> <div><div></div><div>CW - COLD WATER</div></div> <div><div></div><div>GAS - (NATURAL)</div></div> <div><div></div><div>DWL - DIRECT WASTE LINE</div></div> <div><div></div><div>FFD - FLOOR DRAIN W/ FUNNEL</div></div> <div><div></div><div>FS/HG - FLOOR SINK W/ HALF GRATE</div></div> <div><div></div><div>FS/FG - FLOOR SINK W/ FULL GRATE</div></div> <div><div></div><div>FS/NG - FLOOR SINK W/ NO GRATE</div></div>																																																																																																																																																																																																																																																																																																																																																																					



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A New Facility For:

The Lady

Little Rock, AR

APPROVED FOR CONSTRUCTION

Project Number:

24066.00

Date:

01/21/25

Project Mgr :

B. Merritt

Drawn By:

A. LaPerch

Checked By:

M. Holbert

Drawing Issued For:

☐ Schematic Design

☐ Design Development

☒ Construction

Revisions:

No.	Date	Description
1	01/31/25	Beer Taps

Sheet Title:

Kitchen Equipment

General Notes, Legends, Sheet Index

Sheet No:

K0.0

ItemNo	QTY	Category	Equipment Remarks	Voltage	Cycle	Phase	Amps	NEMA	Electrical AFF	Electcnl Remarks	CW (in)	CW AFF	HW (in)	HW AFF	Gas(in)	MBTU	Gas AFF	Plumbing Remarks	Waste Tag	IW (in)	DW (in)	Waste AFF	Waste Remarks
1	2	PIZZA PREPARATION REFRIGERATOR		115	60	1	4.5	5-15P	+24"														
	2	OVERSHELF																					
1.1	1	OVERSHELF																					
2	2	RANGE, 36", 6 OPEN BURNERS		115	60	1	4.0	5-15P	+18"	CONNECT VIA LOAD CENTER ON ITEM #13					3/4"	210.0	+28"	B.T.C. ON RANGE VIA GAS MANIFOLD AS REQUIRED					
3	1	GRIDDLE, GAS, COUNTERTOP		120	60	1	2.0	5-15P	+18"	CONNECT VIA LOAD CENTER ON ITEM #13					3/4"	120.0	+28"	B.T.C. ON GRIDDLE VIA GAS MANIFOLD AS REQUIRED					
4	1	WORKTOP COOK STAND REFRIGERATOR		115	60	1	1.7	5-15P	+18"	CONNECT VIA LOAD CENTER ON ITEM #13													
5	1	GAS FRYER, BATTERY		120	60	1	6.0	5-15P	+18"	CONNECT VIA LOAD CENTER ON ITEM #13					1-1/4"	240.0	+28"	B.T.C. ON FRYER VIA GAS MANIFOLD AS REQUIRED					
6	2	HEAT LAMP		120	60	1	5.6	J-BOX	+18"	CONNECT VIA LOAD CENTER ON ITEM #13													
7	1	CONVECTION OVEN, ELECTRIC		208	60	3	66.0	J-BOX	+18"	CONNECT VIA LOAD CENTER ON ITEM #13	1/2"	+21"						BRANCH TO 1/4" CONN. ON CONVECTION OVEN AS REQUIRED	F5/HG	1-1/2"		FLOOR	CONNECT DRAIN LINE & EXTEND TO FLOOR SINK
8	1	WORK TABLE, BAKERS TOP																					
8.1	2	SHELVING, WALL MOUNTED	MOUNT PER ELEVATIONS																				
9	1	WORK TABLE, STAINLESS STEEL TOP																					
9.1	2	SHELVING, WALL MOUNTED	MOUNT PER ELEVATIONS																				
10	2	UNDERCOUNTER REFRIGERATOR		115	60	1	2	5-15P	+24"														
11	3	HAND SINK									1/2"	+21"	1/2"	+21"				B.T.C. ON HAND SINK AS REQUIRED	DWL		1-1/2"	+16"	
12	1	RAPID COOK OVEN		208/240	60	1	20.0	L6-20P	+42"														
13	1	CHEF SUITE	CUSTOM	115-208	6	1	50.0	J-BOX	***	B.T.C. ON LOAD CENTER													
14	1	WORK TABLE, 96", STAINLESS STEEL TOP																					
14.1	2	SHELVING, WALL MOUNTED	MOUNT PER ELEVATIONS																				
15	1	DISHWASHER, DOOR TYPE	BY OTHERS	***	***	***	***	***	***	BY OTHERS; VERIFY UTILITES W/ VENDOR	***	***	***	***				BY OTHERS; VERIFY UTILITES W/ VENDOR					
15.1	1	CONDENSATE DISH HOOD	BY OTHERS	***	***	***	***	***	***	BY OTHERS; VERIFY UTILITES W/ VENDOR													
16	1	SOILED DISHTABLE									1/2"	+21"	1/2"	+21"				B.T.C. ON PRE-RINSE FACUET AS REQUIRED	F5/HG	1-1/2"		FLOOR	CONNECT DRAIN LINE & EXTEND TO FLOOR SINK
16.1	1	DISHTABLE SORTING SHELF	MOUNT +60" AFF																				
17	1	CLEAN DISHTABLE																					
17.1	1	DISHTABLE SORTING SHELF	MOUNT +60" AFF																				
	1	THREE (3) COMPARTMENT SINK									1/2"	+16"	1/2"	+16"				B.T.C. ON PRE-RINSE FACUET AS REQUIRED	F5/HG	1-1/2"		FLOOR	CONNECT DRAIN LINE & EXTEND TO FLOOR SINK
18	1	PRE-RINSE FAUCET ASSEMBLY																					
	1	ADD-A-FAUCET																					
18.1	1	POT RACK	MOUNT +72" AFF																				
19	1	ISLAND HOOD	BY OTHERS	***	***	***	***	***	***	BY OTHERS; VERIFY UTILITES W/ VENDOR													
20	1	REACH-IN REFRIGERATOR		115	60	1	5.4	5-15P	+24"														
21	1	REFRIGERATED WORK TOP		115	60	1	2.2	5-15P	+24"														
21.1	2	SHELVING, WALL MOUNTED	MOUNT PER ELEVATIONS																				
22	1	MOP SINK	W/ FAUCET								1/2"	+36"	1/2"	+36"					DWL		2"	FLOOR	
23	1	WORK TABLE, STAINLESS STEEL TOP																					
24	1	BEVERAGE COUNTER		120	60	1	15.0	J-BOX	+42"	BRANCH TO 5-15 CONVENIENCE OUTLET IN BACK SPLASH	1/2"	+21"	1/2"	+21"				B.T.C. ON BEVERAGE COUNTER AS REQUIRED	F5/HG	1-1/2		FLOOR	CONNECT DRAIN LINE & EXTEND TO FLOOR SINK
24.1	2	SHELVING, WALL MOUNTED	MOUNT PER ELEVATIONS																				
	1	ICE MAKER, CUBE-STYLE		115	60	1	11.5	J-BOX	+60"		1/2"	+21"						B.T.C. ON ICE MAKER AS REQUIRED	F5/HG	3/4"		FLOOR	CONNECT DRAIN LINE & EXTEND TO FLOOR SINK
25	1	ICE BIN FOR ICE MACHINES																					
	1	NUGGET ICE MAKER		115	60	1	15.2	J-BOX	+60"		1/2"	+21"						B.T.C. ON ICE MAKER AS REQUIRED	F5/HG	3/4"		FLOOR	CONNECT DRAIN LINE & EXTEND TO FLOOR SINK
	1	ICE BIN FOR ICE MACHINES																					
27	2	COFFEE TEA BREWER		120	60	1	14.0	5-15P	+42"		1/2"	+21"						BRANCH TO 1/4" CONN. ON COFFEE TEA BREWER AS REQUIRED					
28	1	COUNTERTOP WATER DISPENSER																					
28.1	1	UNDERCOUNTER CARBONATION CHILLER WATER SYSTEM		115	60	1	3.2	5-15P	+24"	B.T.C. ON #28 WATER DISPENSER AS REQUIRED	1/2"	+21"						BRANCH TO 3/8" CONN. ON CARBONATOR AS REQUIRED					
29	1	SODA ICE & BEVERAGE DISPENSER, IN-COUNTER	BY OTHERS	***	***	***	***	***	***	BY OTHERS; VERIFY UTILITES W/ VENDOR	***	***						BY OTHERS; VERIFY UTILITES W/ VENDOR					
30	1	BAG IN BOX SYRUP TANK RACK	BY OTHERS	***	***	***	***	***	***	BY OTHERS; VERIFY UTILITES W/ VENDOR	***	***						BY OTHERS; VERIFY UTILITES W/ VENDOR					
B1	2	GLASS RACK																	F5/HG	1"		FLOOR	CONNECT DRAIN LINE & EXTEND TO FLOOR SINK
B2	1	COCKTAIL STATION									1/2"	+12"	1/2"	+12"				B.T.C. ON FAUCETS, DIPPER WELL & GLASS RINSER AS REQUIRED	F5/HG	1"		FLOOR	CONNECT DRAIN LINE & EXTEND TO FLOOR SINK
B3	1	UNDERBAR TRASH STATION																	F5/HG	1"		FLOOR	CONNECT DRAIN LINE & EXTEND TO FLOOR SINK
B4	1	DRAINBOARD																	F5/HG	1"		FLOOR	CONNECT DRAIN LINE & EXTEND TO FLOOR SINK
B5	1	GLASSWASHER, UNDERCOUNTER / UNDERBAR		115	60	1	12.0	J-BOX	+18"					3/4"	+12"			B.T.C. ON GLASSWASHER AS REQUIRED	F5/HG	1/2"		FLOOR	CONNECT DRAIN LINE & EXTEND TO FLOOR SINK
B6	1	COCKTAIL STATION									1/2"	+12"	1/2"	+12"				B.T.C. ON FAUCET, DIPPER WELL & GLASS RINSER AS REQUIRED	F5/HG	1-1/2"		FLOOR	CONNECT DRAIN LINE & EXTEND TO FLOOR SINK
B7	1	BACK BAR CABINET, REFRIGERATED		115	60	1	2.2	5-15P	+24"														
B8	1	BACK BAR CABINET, REFRIGERATED		115	60	1	2.2	5-15P	+24"														
B9	1	ESPRESSO CAPPUCCINO MACHINE		208-240	60	1	12.0	6-20P	+48"		1/2"	+21"						BRANCH TO 3/8" CONN. ON ESPRESSO MACHINE AS REQUIRED					
B10	1	COFFEE GRINDER		110	60	1	5.0	***	+48"														
B11	1	FREEZER/MUG FROSTER		115	60	1	2.5	5-15P	+24"														
B12	2	DRIP TROUGH	CUSTOM								1/2"	+12"						B.T.C. ON GLASS RINSER AS REQUIRED					
B13	1	DRAFT BEER DISPENSING TOWER	CUSTOM																F5/HG	1-1/2"		FLOOR	CONNECT DRAIN LINE & EXTEND TO FLOOR SINK
B14	1	DRIP TROUGH	CUSTOM								1/2"	+21"						B.T.C. ON GLASS RINSERS AS REQUIRED	F5/HG	1-1/2"		FLOOR	CONNECT DRAIN LINE & EXTEND TO FLOOR SINK
C1	2	GLASS RACK																	F5/HG	1"		FLOOR	CONNECT DRAIN LINE & EXTEND TO FLOOR SINK
C2	1	COCKTAIL STATION									1/2"	+12"	1/2"	+12"				B.T.C. ON FAUCETS, DIPPER WELL & GLASS RINSER AS REQUIRED	F5/HG	1"		FLOOR	CONNECT DRAIN LINE & EXTEND TO FLOOR SINK
C3	1	UNDERBAR TRASH STATION																					
C4	1	DRAINBOARD																	F5/HG	1"		FLOOR	CONNECT DRAIN LINE & EXTEND TO FLOOR SINK
C5	1	GLASSWASHER, UNDERCOUNTER / UNDERBAR		115	60	1	12.0	J-BOX	+18"				3/4"	+12"				B.T.C. ON GLASSWASHER AS REQUIRED	F5/HG	1/2"		FLOOR	CONNECT DRAIN LINE & EXTEND TO FLOOR SINK
C6	1	COCKTAIL STATION									1/2"	+12"	1/2"	+12"				B.T.C. ON FAUCET, DIPPER WELL & GLASS RINSER AS REQUIRED	F5/HG	1-1/2"		FLOOR	CONNECT DRAIN LINE & EXTEND TO FLOOR SINK
C7	1	BACK BAR CABINET, REFRIGERATED		115	60	1	2.2	5-15P	+24"														
C8	1	BACK BAR CABINET, REFRIGERATED		115	60	1	2.2	5-15P	+24"														
C9	1	ESPRESSO CAPPUCCINO MACHINE		208-240	60	1	12.0	6-20P	+48"		1/2"	+12"						BRANCH TO 3/8" CONN. ON ESPRESSO MACHINE AS REQUIRED					
C10	1	COFFEE GRINDER		110	60	1	5.0	***	+48"														
C11	1	FREEZER/MUG FROSTER		115	60	1	2.5	5-15P	+24"														
C12	2	DRIP TROUGH	CUSTOM								1/2"	+12"						B.T.C. ON GLASS RINSER AS REQUIRED					
C13	1	DRAFT BEER DISPENSING TOWER	CUSTOM																F5/HG	1-1/2"		FLOOR	CONNECT DRAIN LINE & EXTEND TO FLOOR SINK
C14	1	DRIP TROUGH	CUSTOM								1/2"	+21"						B.T.C. ON GLASS RINSERS AS REQUIRED	F5/HG	1-1/2"		FLOOR	CONNECT DRAIN LINE & EXTEND TO FLOOR SINK

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A New Facility For:

The Lady

Little Rock, AR

APPROVED  
FOR  
CONSTRUCTION

Project Number:24066.00

Date:01/21/25

Project Mgr :B. Merritt

Drawn By:A. LaPerch

Checked By:M. Holbert

Drawing Issued For:

☐ Schematic Design

☐ Design Development

☒ Construction

Revisions:

No.	Date	Description
1	01/31/25	Beer Taps

Sheet Title:

Kitchen Equipment

Equipment Schedule


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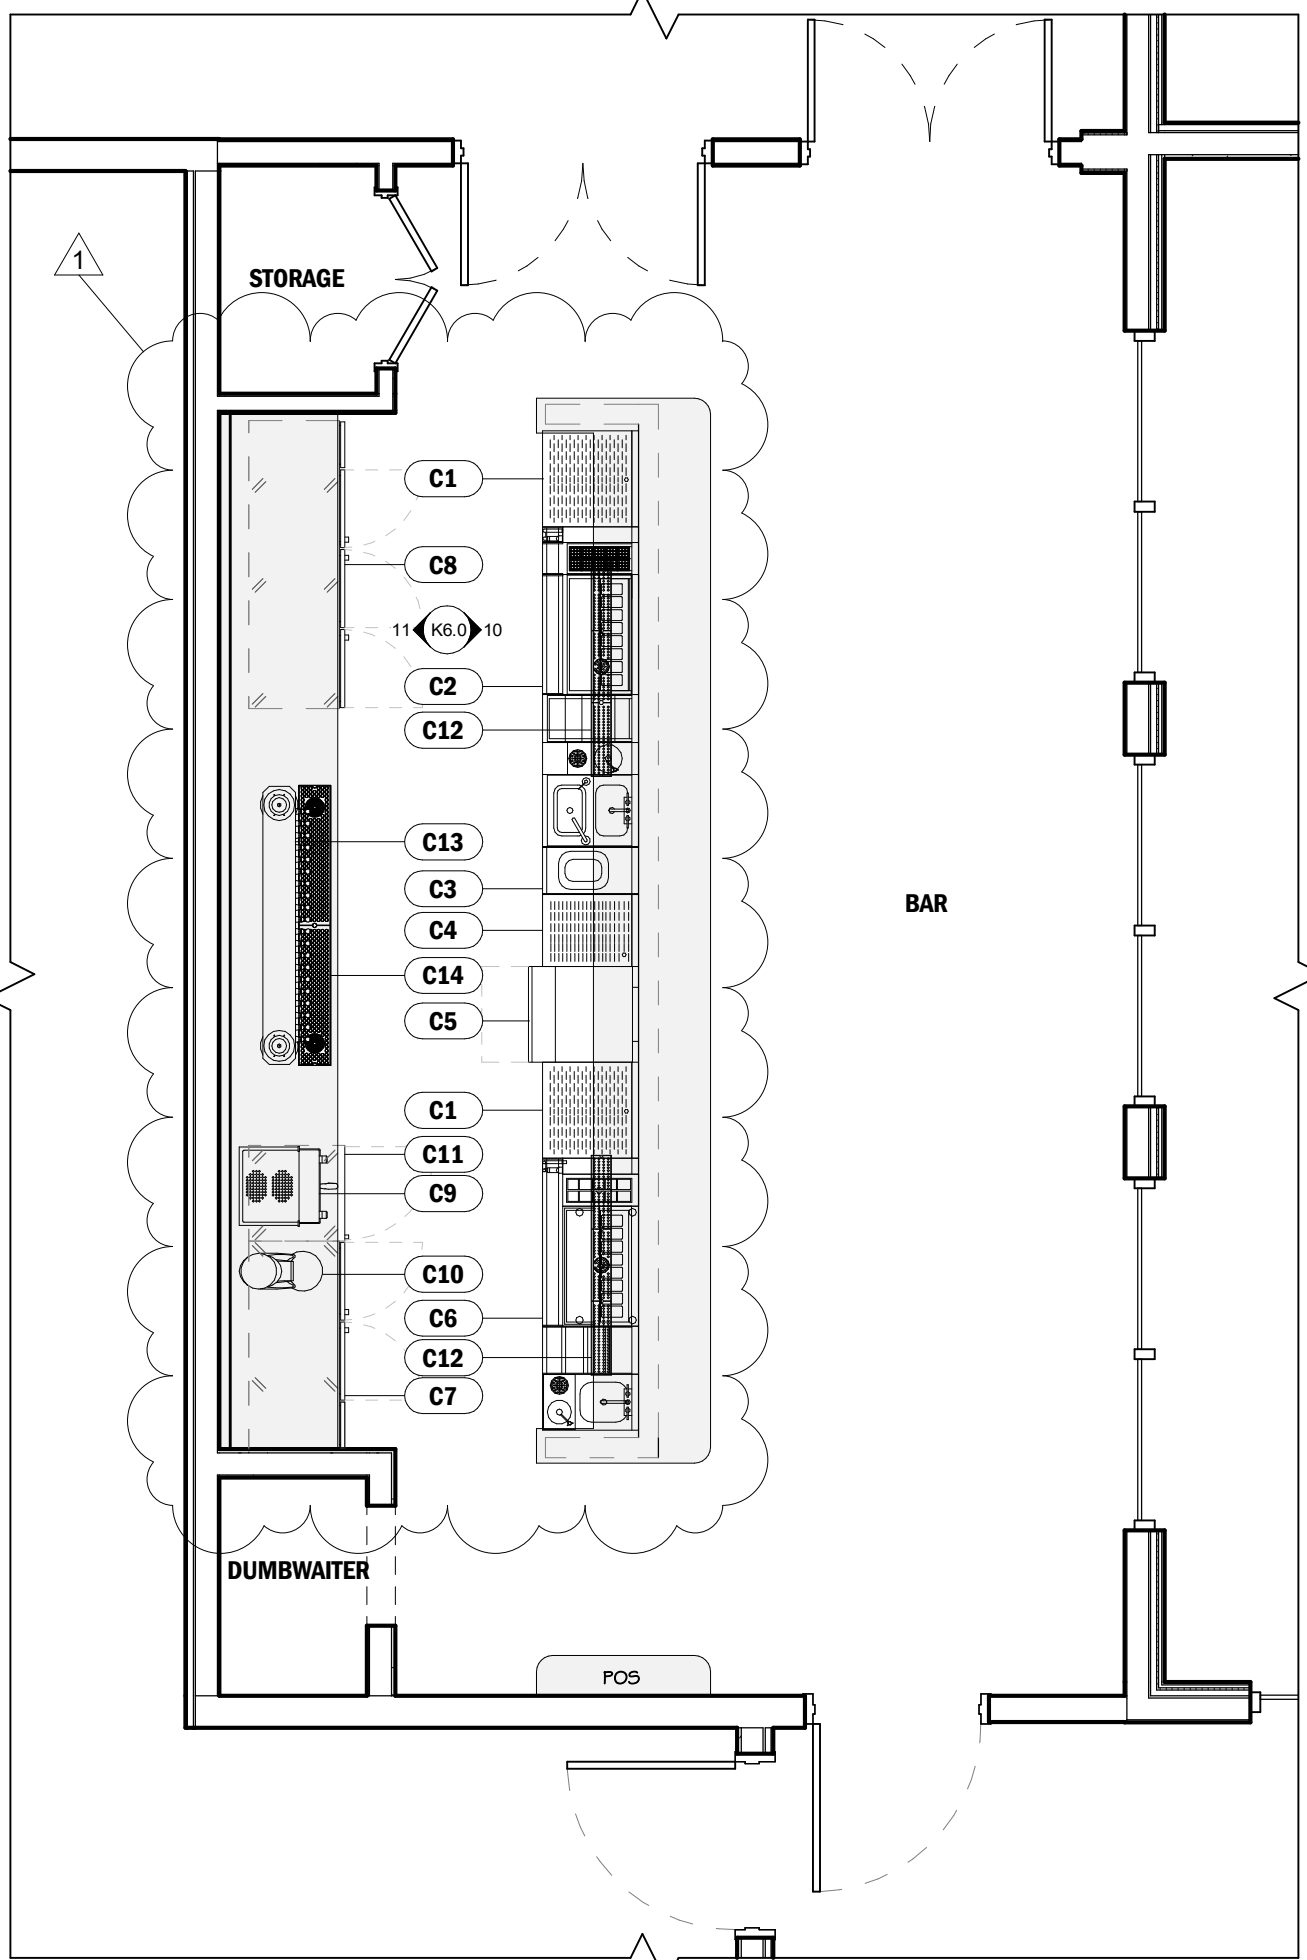
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1 Equipment Plan - Level 1  
1/4" = 1'-0"



2 Equipment Plan - Level 2  
1/4" = 1'-0"



A New Facility For:
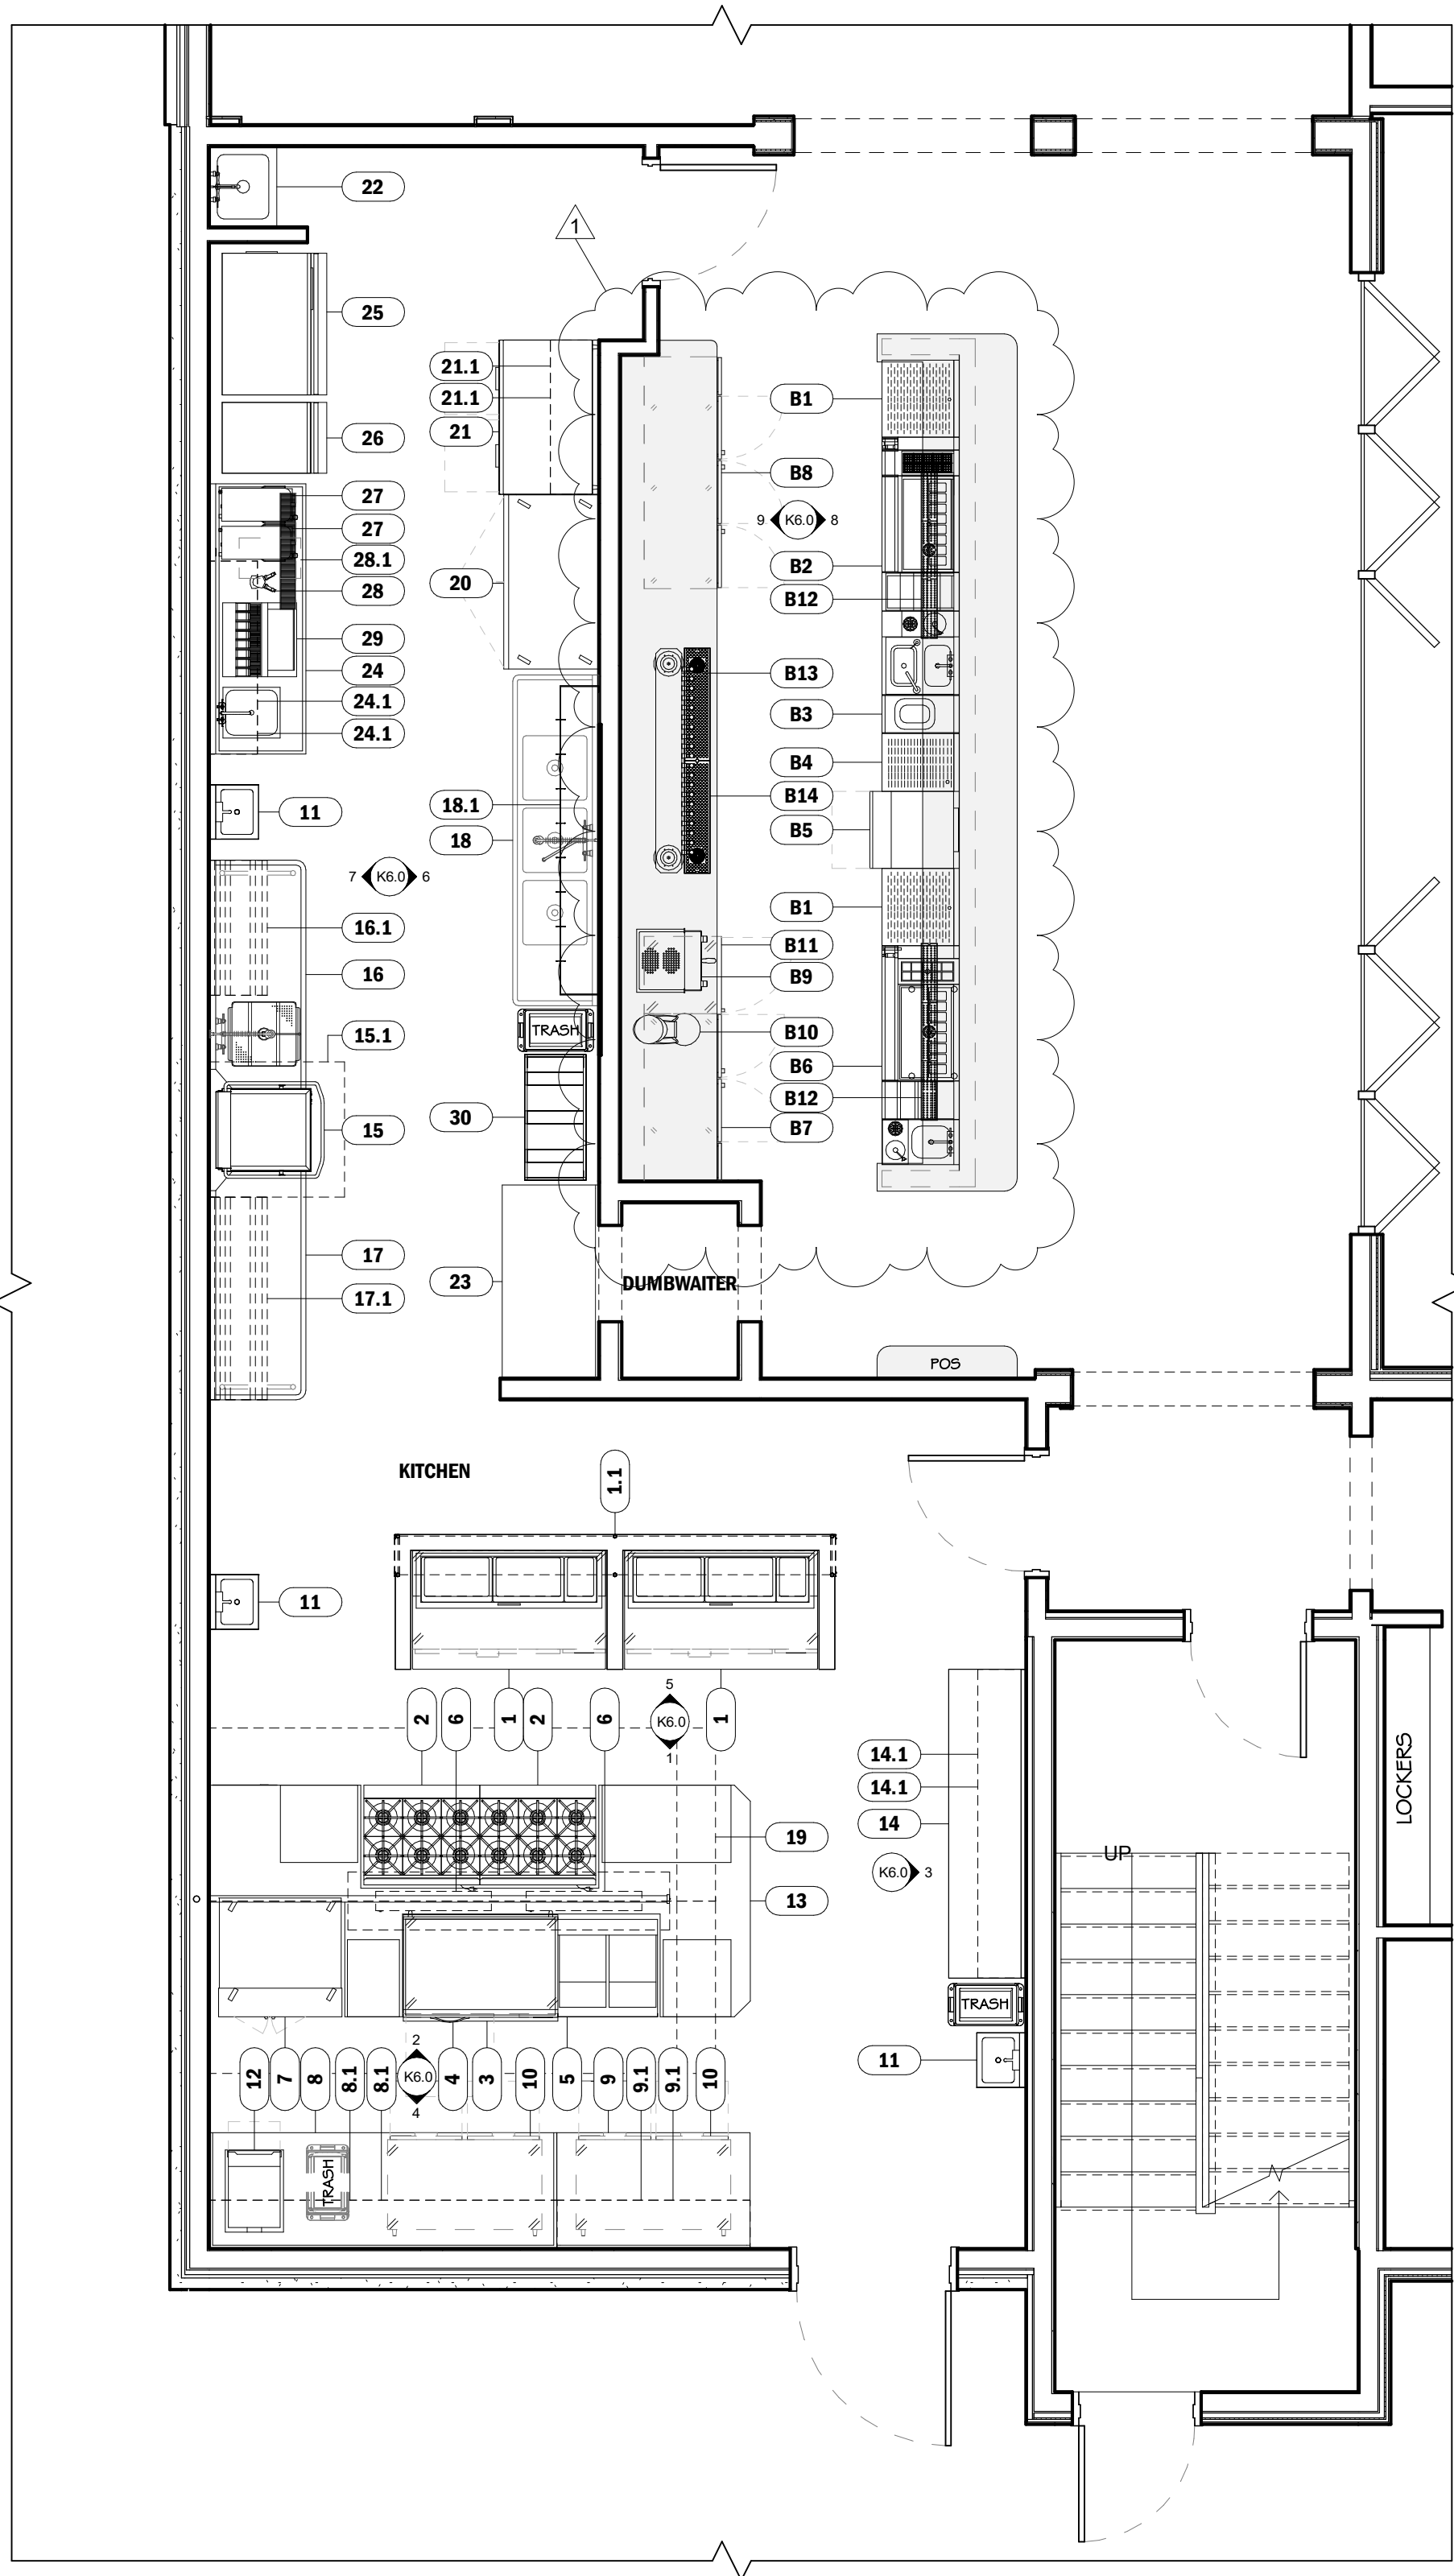
# The Lady

Little Rock, AR





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Date:		01/21/25
Project Mgr :		B. Merritt
Drawn By:		A. LaPerch
Checked By:		M. Holbert
Drawing Issued For:		
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<input type="radio"/> Design Development		
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Revisions:		
No.	Date	Description
1	01/31/25	Beer Taps

Sheet Title:  
Kitchen Equipment  
Equipment Plan  
Sheet No:

K1.0





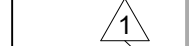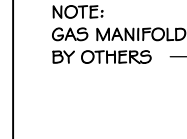

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3	N.T.S.
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- 1.

4 | N.T.S.

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## A New Facility For:

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# Little Rock, AR

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Project Number: 24066.00

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Revisions: \_\_\_\_\_

Sheet Title:

Plumbing Plan

Sheet No:


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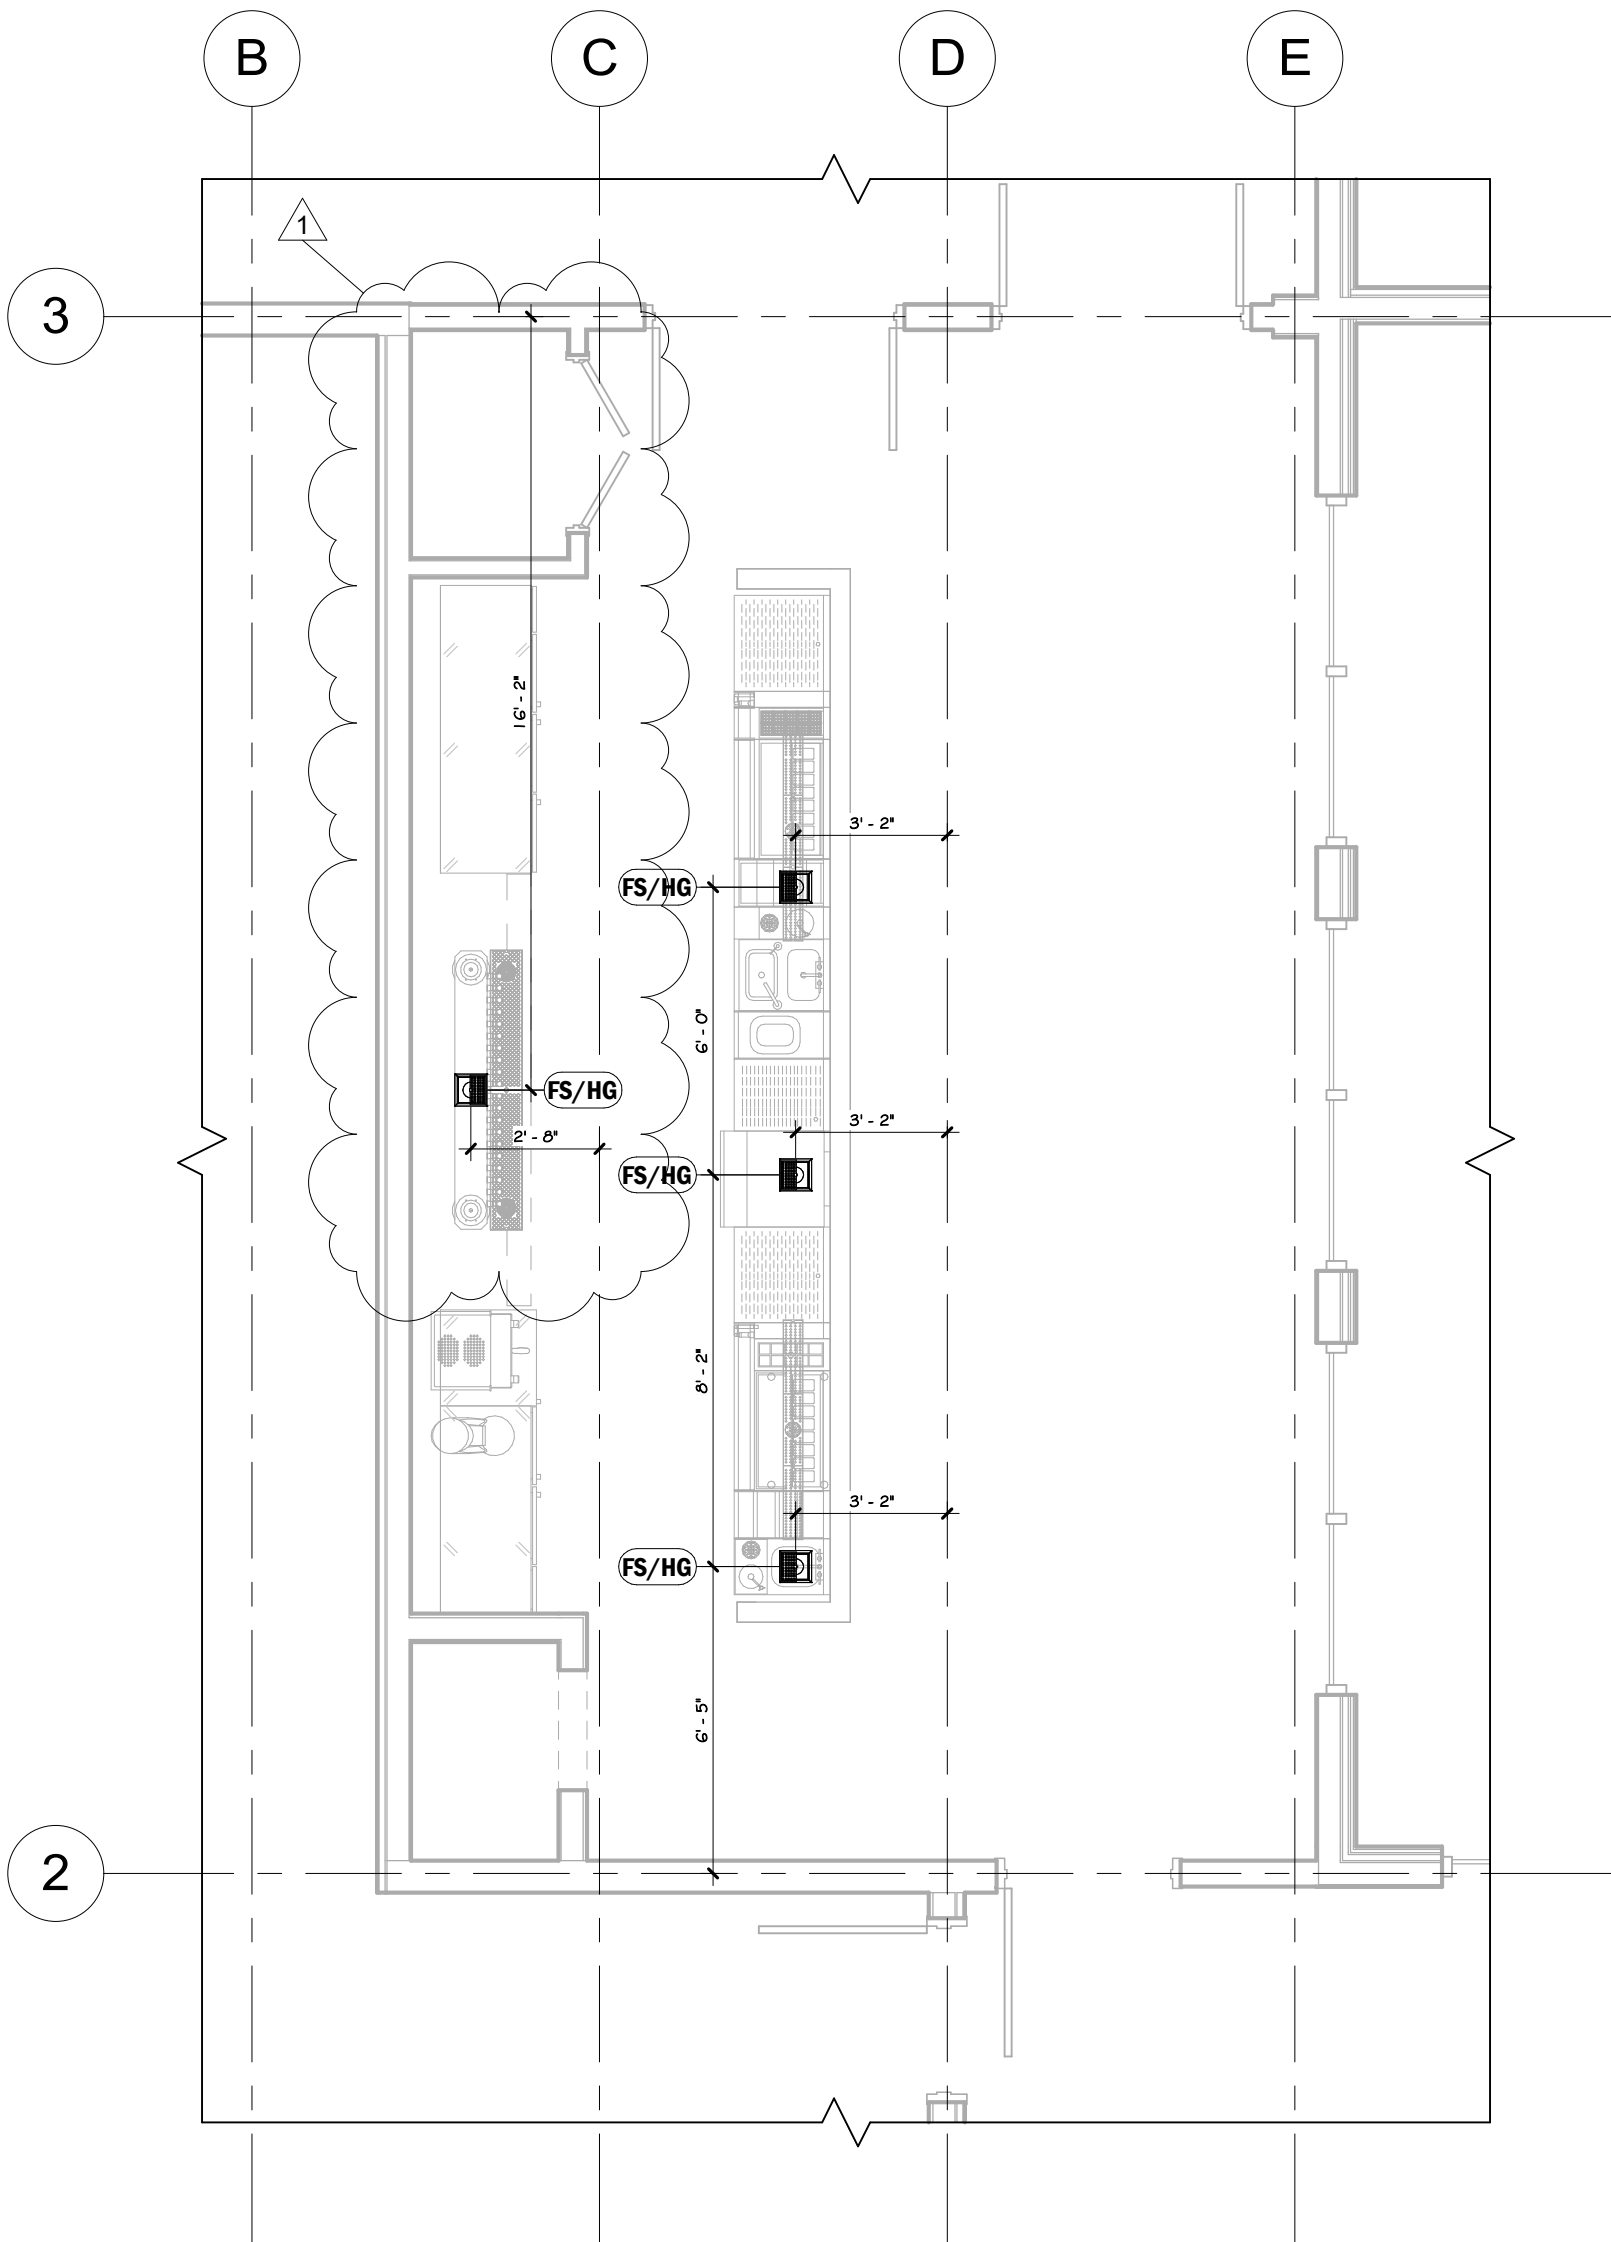
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1 Waste Plan - Level 1  
1/4" = 1'-0"



2 Waste Plan - Level 2  
1/4" = 1'-0"

- DWL - DIRECT WASTE LINE
- FIELD CONNECTIONS
- FFD - FLOOR DRAIN W/ FUNNEL
- FS/HG - FLOOR SINK W/ HALF GRATE
- FS/FG - FLOOR SINK W/ FULL GRATE
- FSNG - FLOOR SINK W/ NO GRATE

3 Waste Legend  
N.T.S.

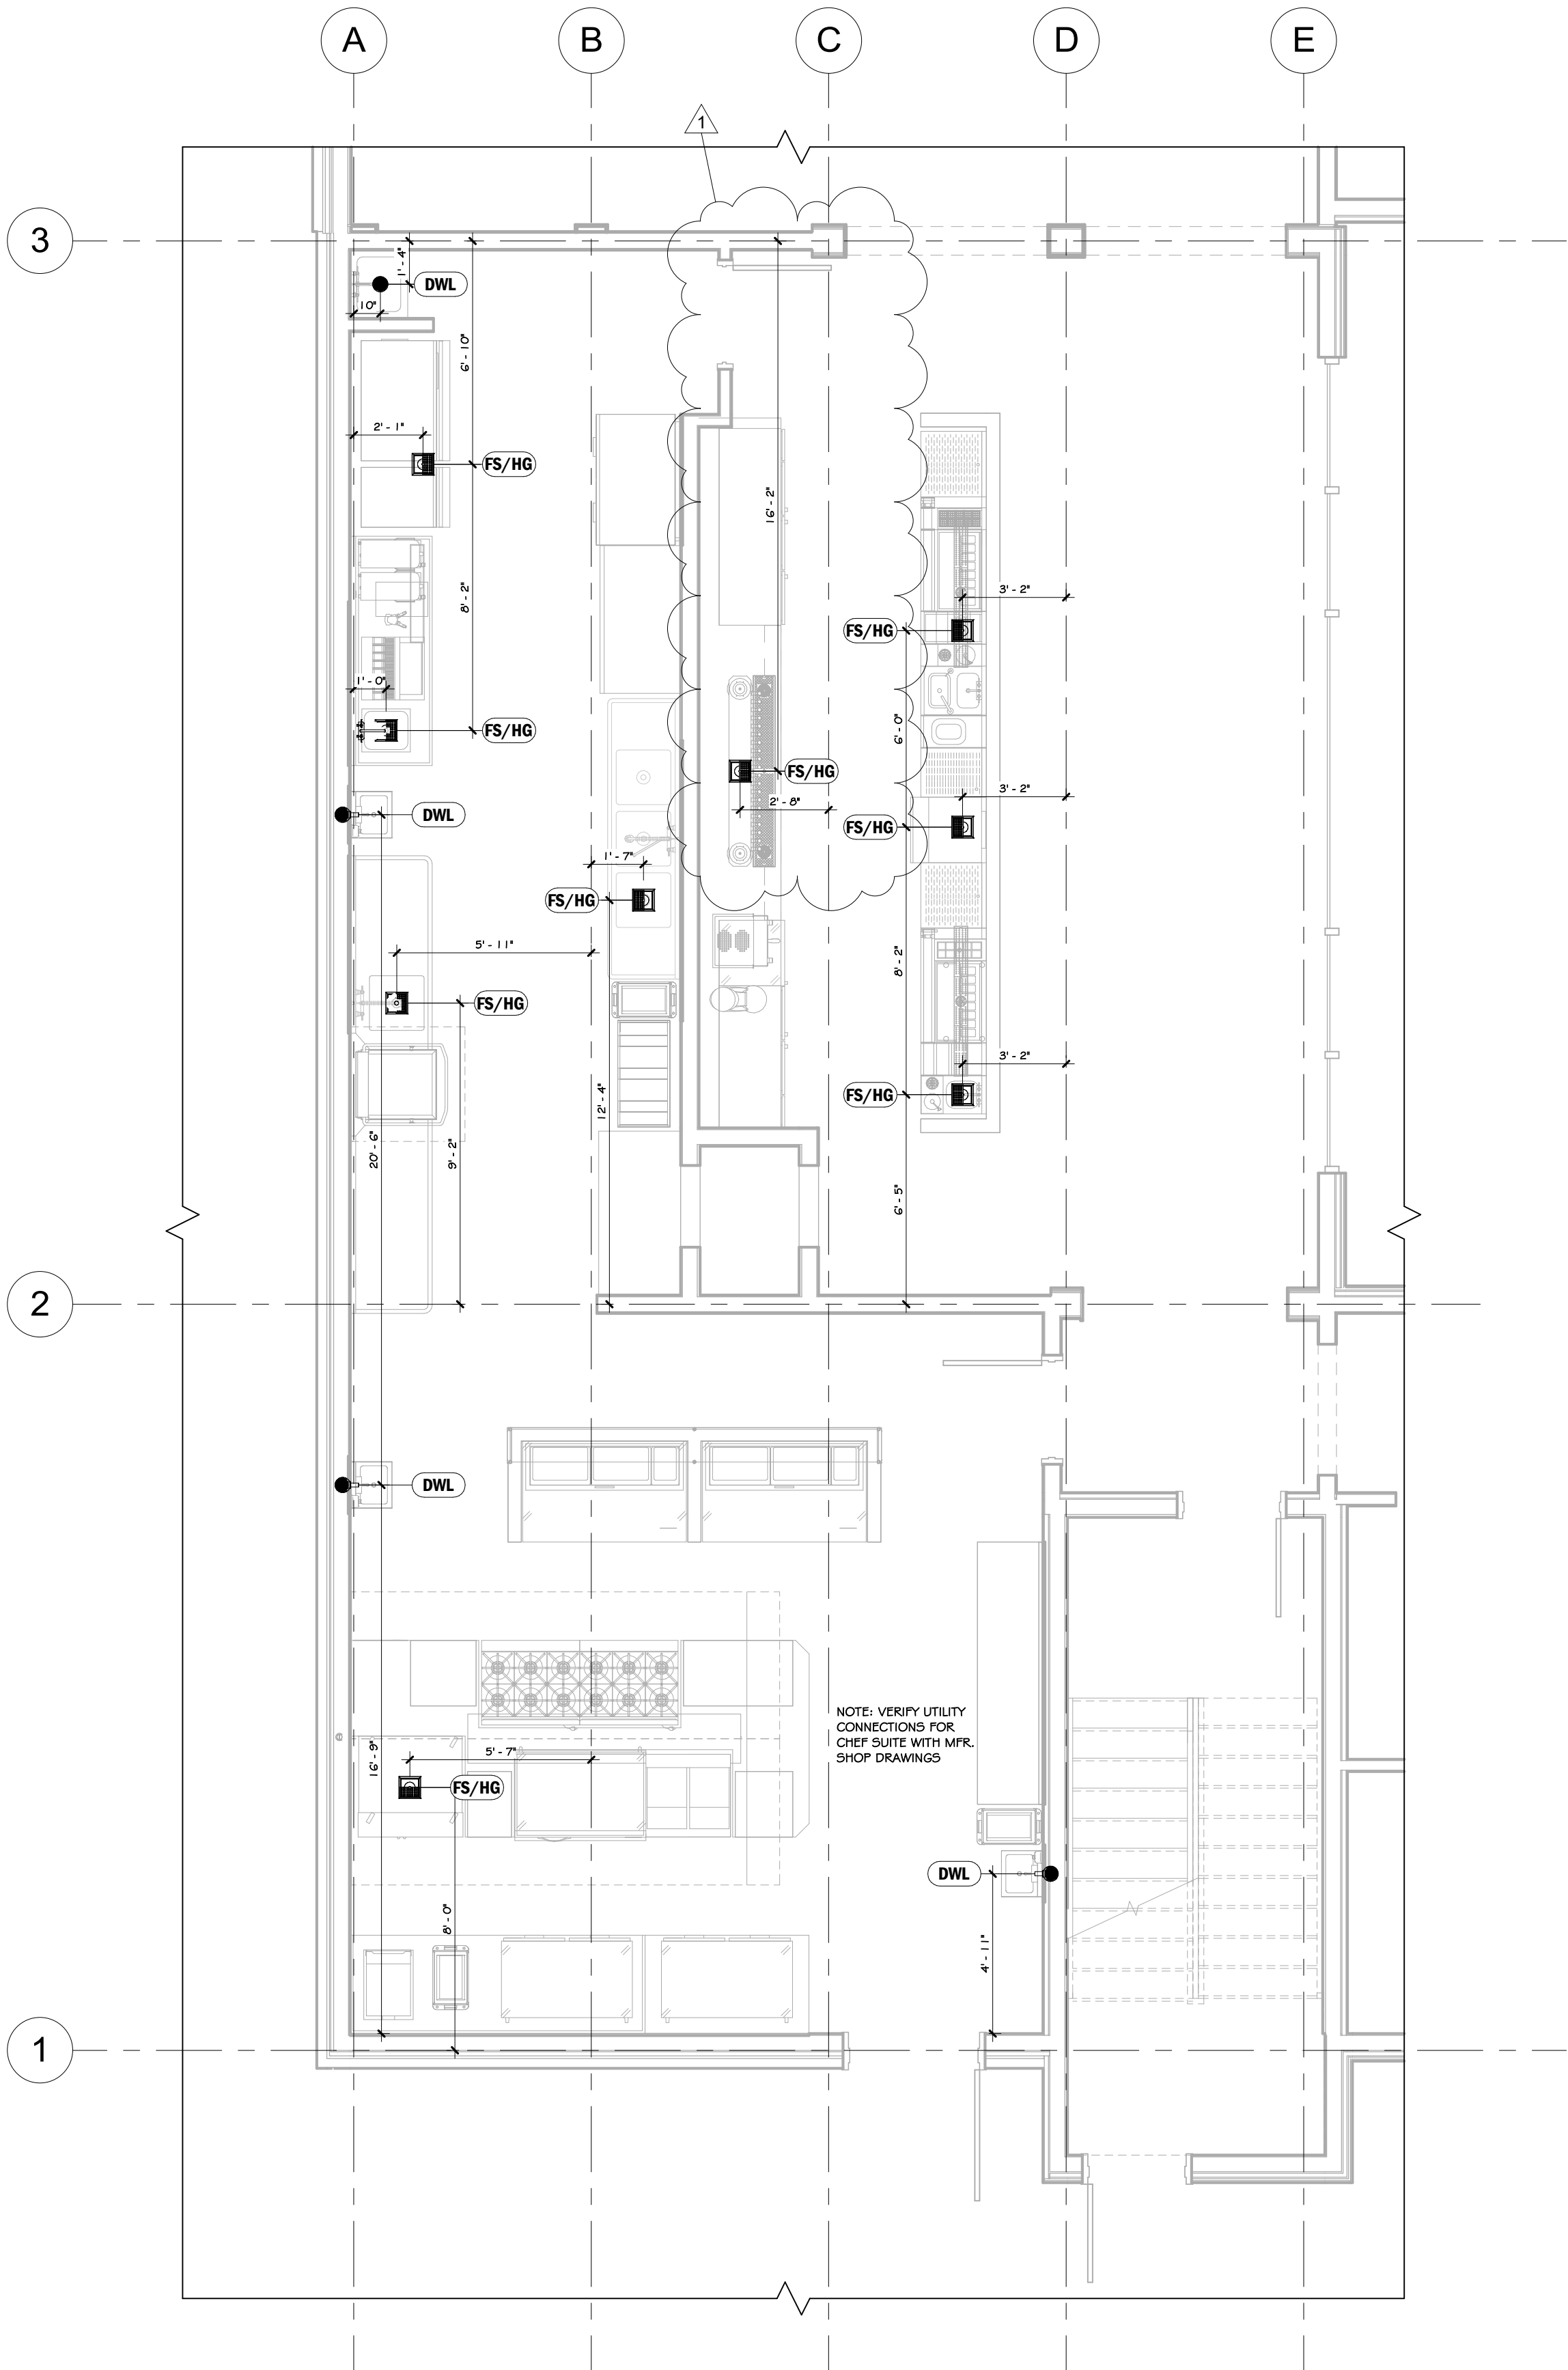- ALL DRAINS DEDICATED FOR EQUIPMENT, INCLUDING FLOOR TROUGHS, MUST BE FLUSH WITH PLANE OF SURROUNDING FLOOR.
- GENERAL PURPOSE FLOOR DRAINS, INCLUDING FLOOR TROUGHS, IN AREAS OF HIGH TRAFFIC MUST BE FLUSH WITH PLANE OF SURROUNDING FLOOR.
- ALL FLOOR DRAINS AND FLOOR SINKS TO BE LOCATED BY A LICENSED PLUMBING ENGINEER. FLOOR DRAIN LOCATIONS ON THIS PLAN ARE APPROXIMATE.
- DRAIN LINES ARE BY THE PC. PC TO MANIFOLD MULTIPLE WASTE CONNECTIONS AND EXTEND SAFE WASTE OR DIRECT CONNECTIONS AS REQUIRED. IT IS HIGHLY RECOMMENDED THAT THE FIRST 20 FEET OF ALL DRAINS ARE MADE OF CAST IRON. HIGH TEMP DRAIN WATER CAN DAMAGE PVC PIPES AND DISSOLVE JOINT ADHESIVE. CONDENSATE DRAIN LINE FROM EVAP. COILS TO WALK-IN BOX IS BY THE PC, AND SHOULD BE INSTALLED WITH A SLOPE OF 1/4" PER LINEAR FOOT OF PIPING.

4 Waste Notes  
N.T.S.

5 Not Used  
N.T.S.

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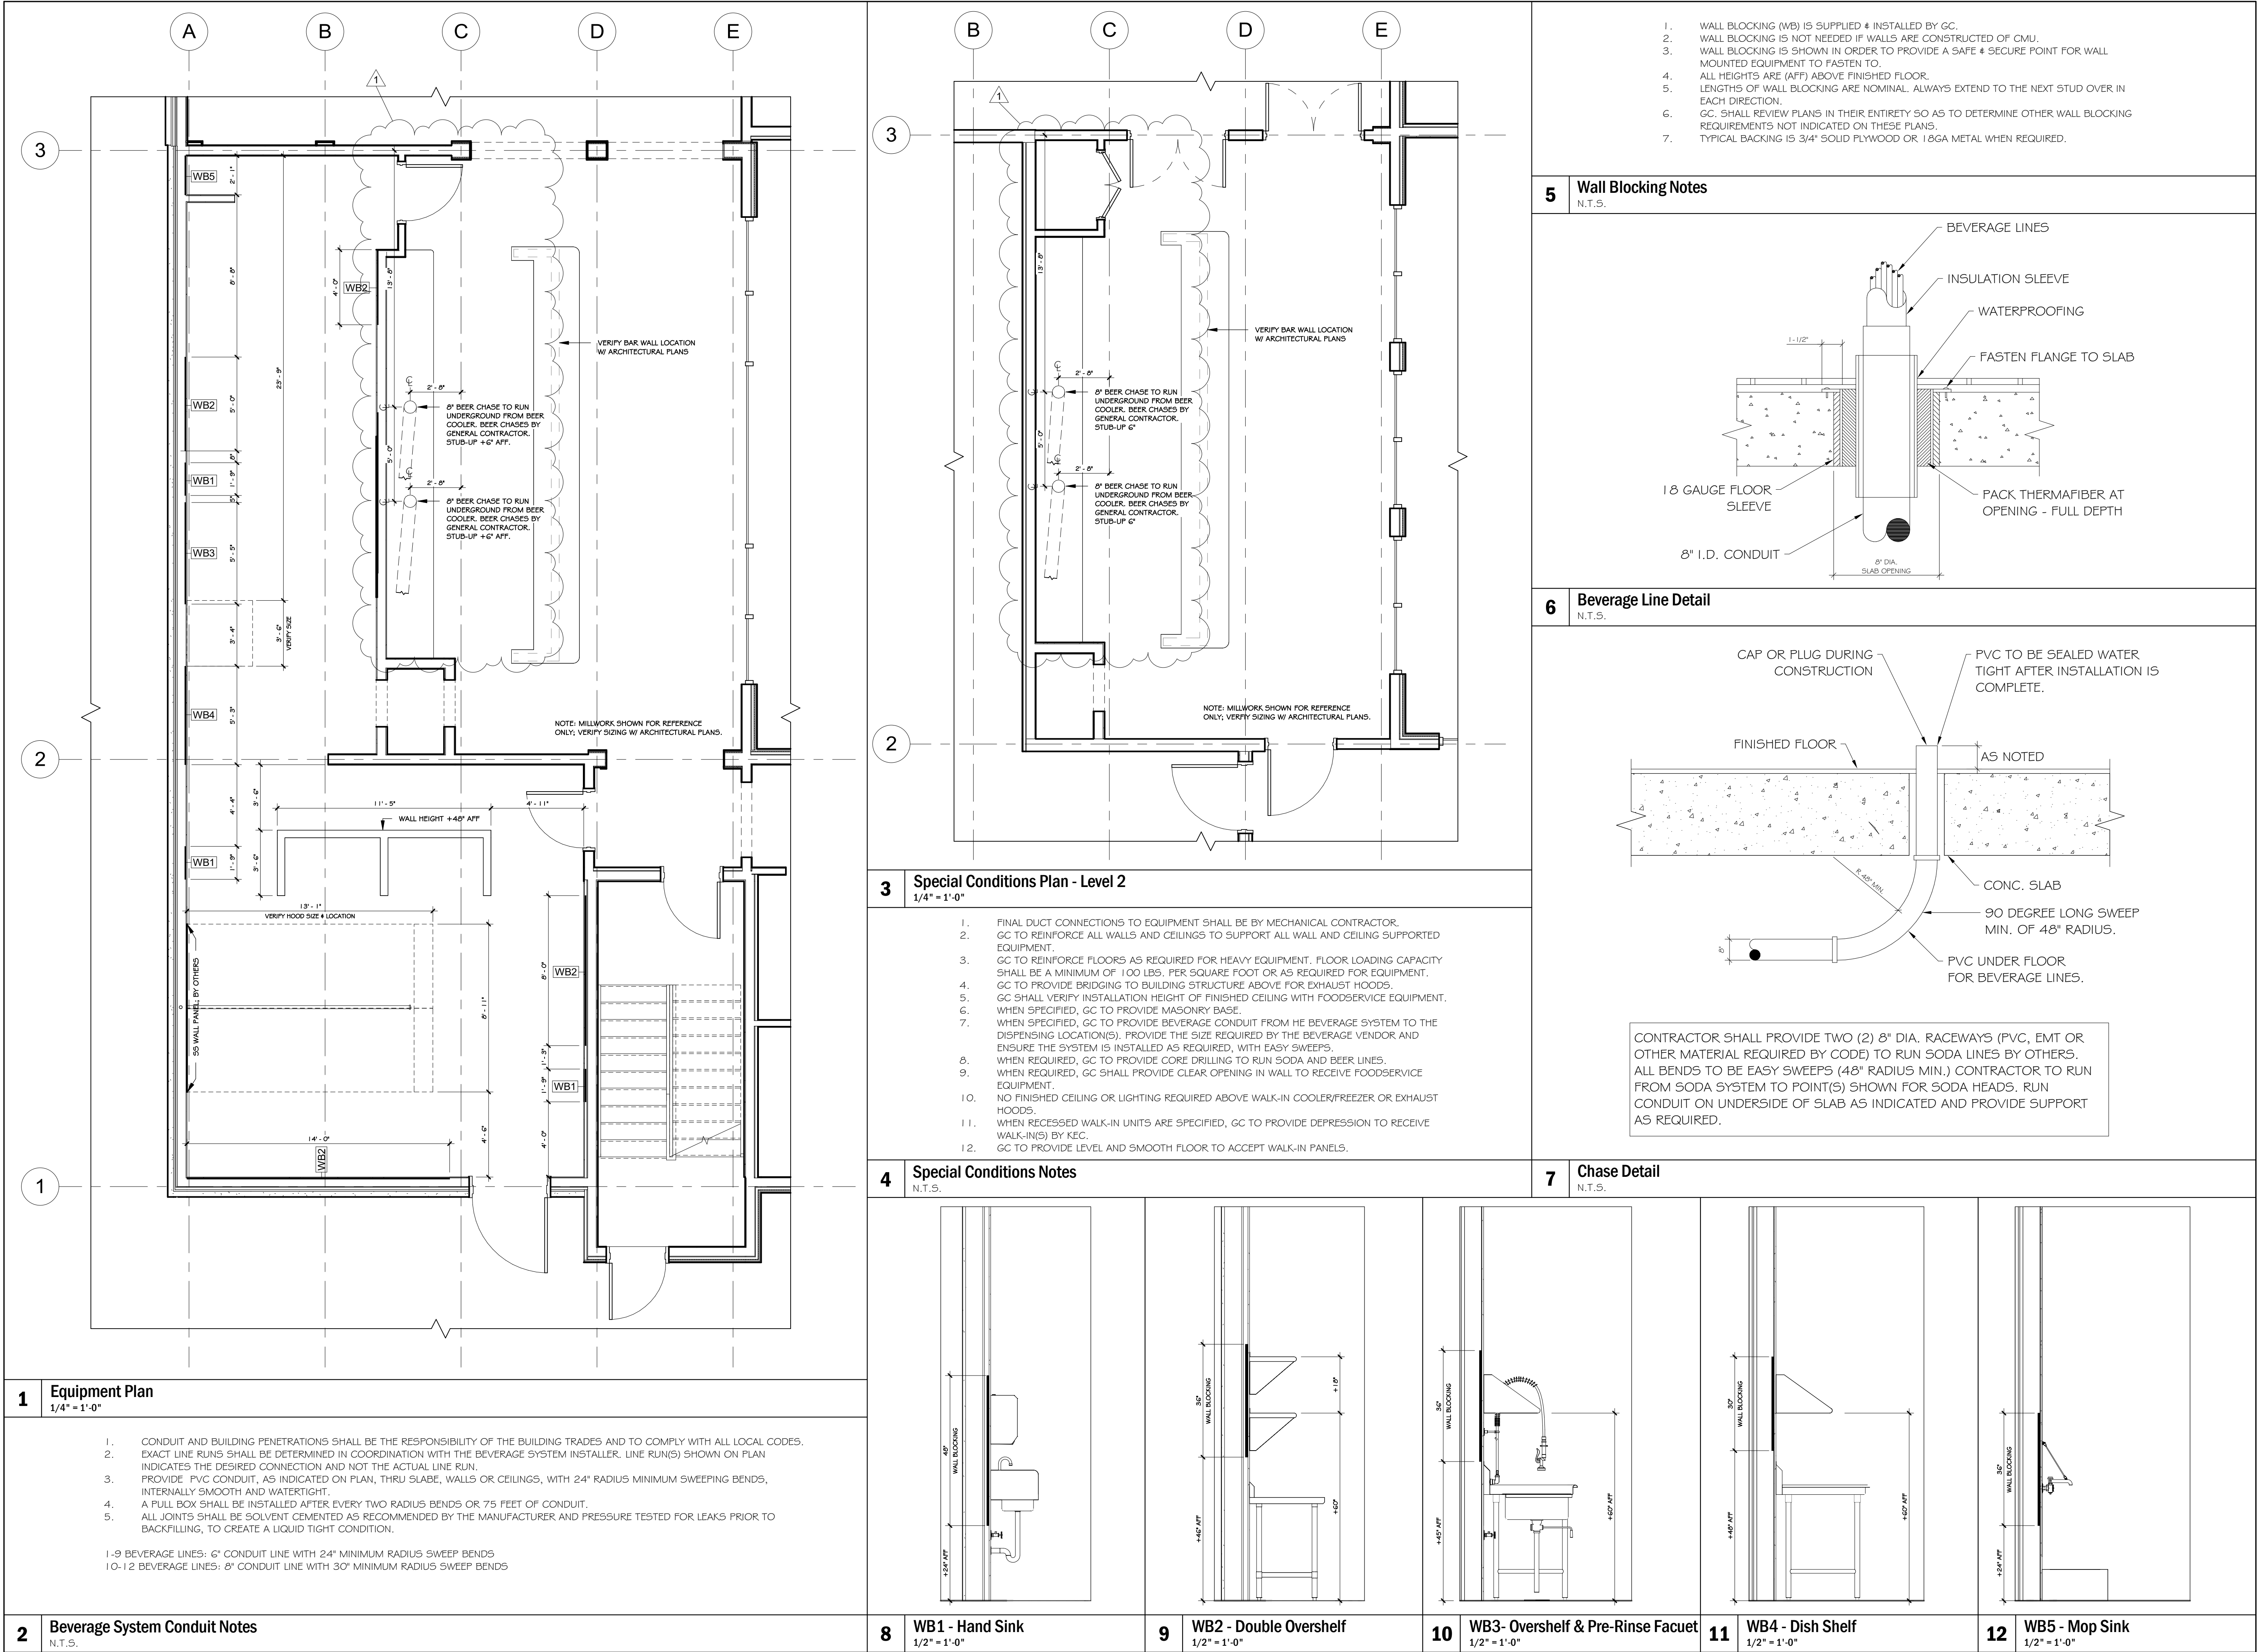
Project Number: 24066.00  
Date: 01/21/25  
Project Mgr : B. Merritt  
Drawn By: A. LaPerch  
Checked By: M. Holbert

Drawing Issued For:  
☐ Schematic Design  
☐ Design Development  
☒ Construction

Revisions:  
No. Date Description  
1 01/31/25 Beer Taps

Sheet Title:  
Kitchen Equipment  
Waste Plan  
Sheet No:

K4.0



A New Facility For:

The Lady  
Little Rock, AR

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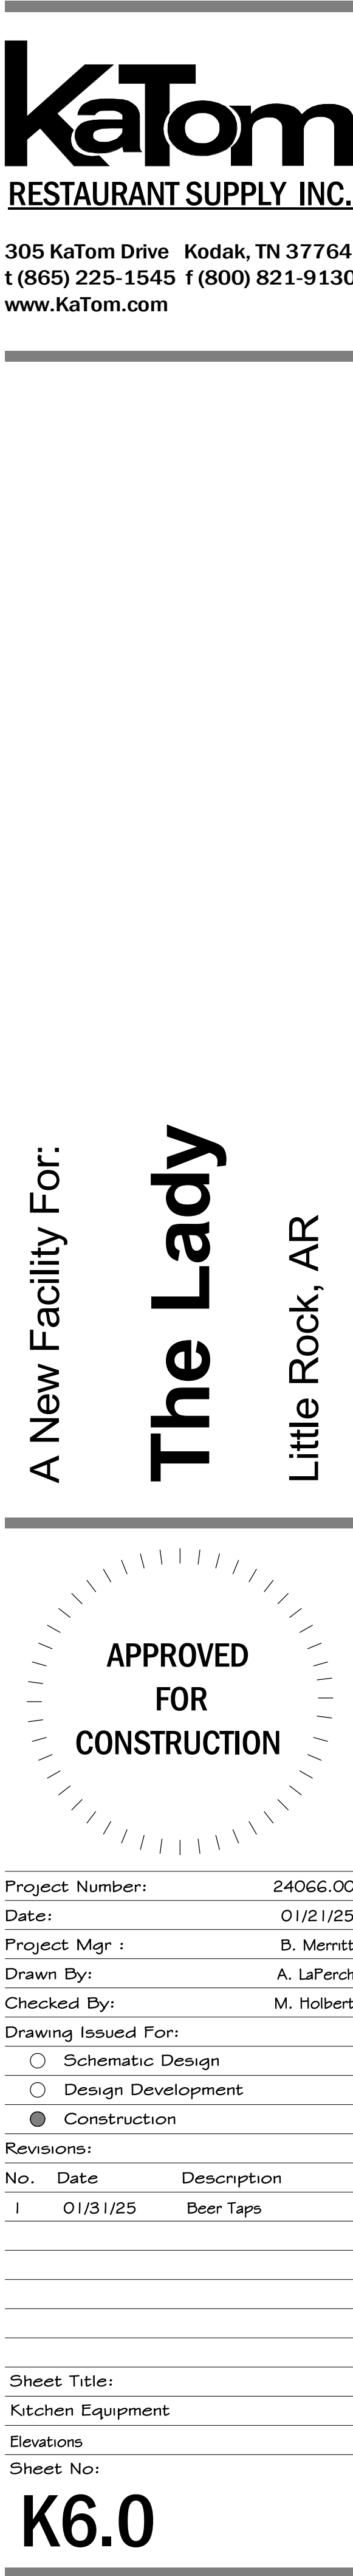
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Date:	01/21/25
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Drawn By:	A. LaPerch
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Revisions:		
No.	Date	Description
1	01/31/25	Beer Taps


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Kitchen Equipment	
Special Conditions Plan	
Sheet No:	

K5.0








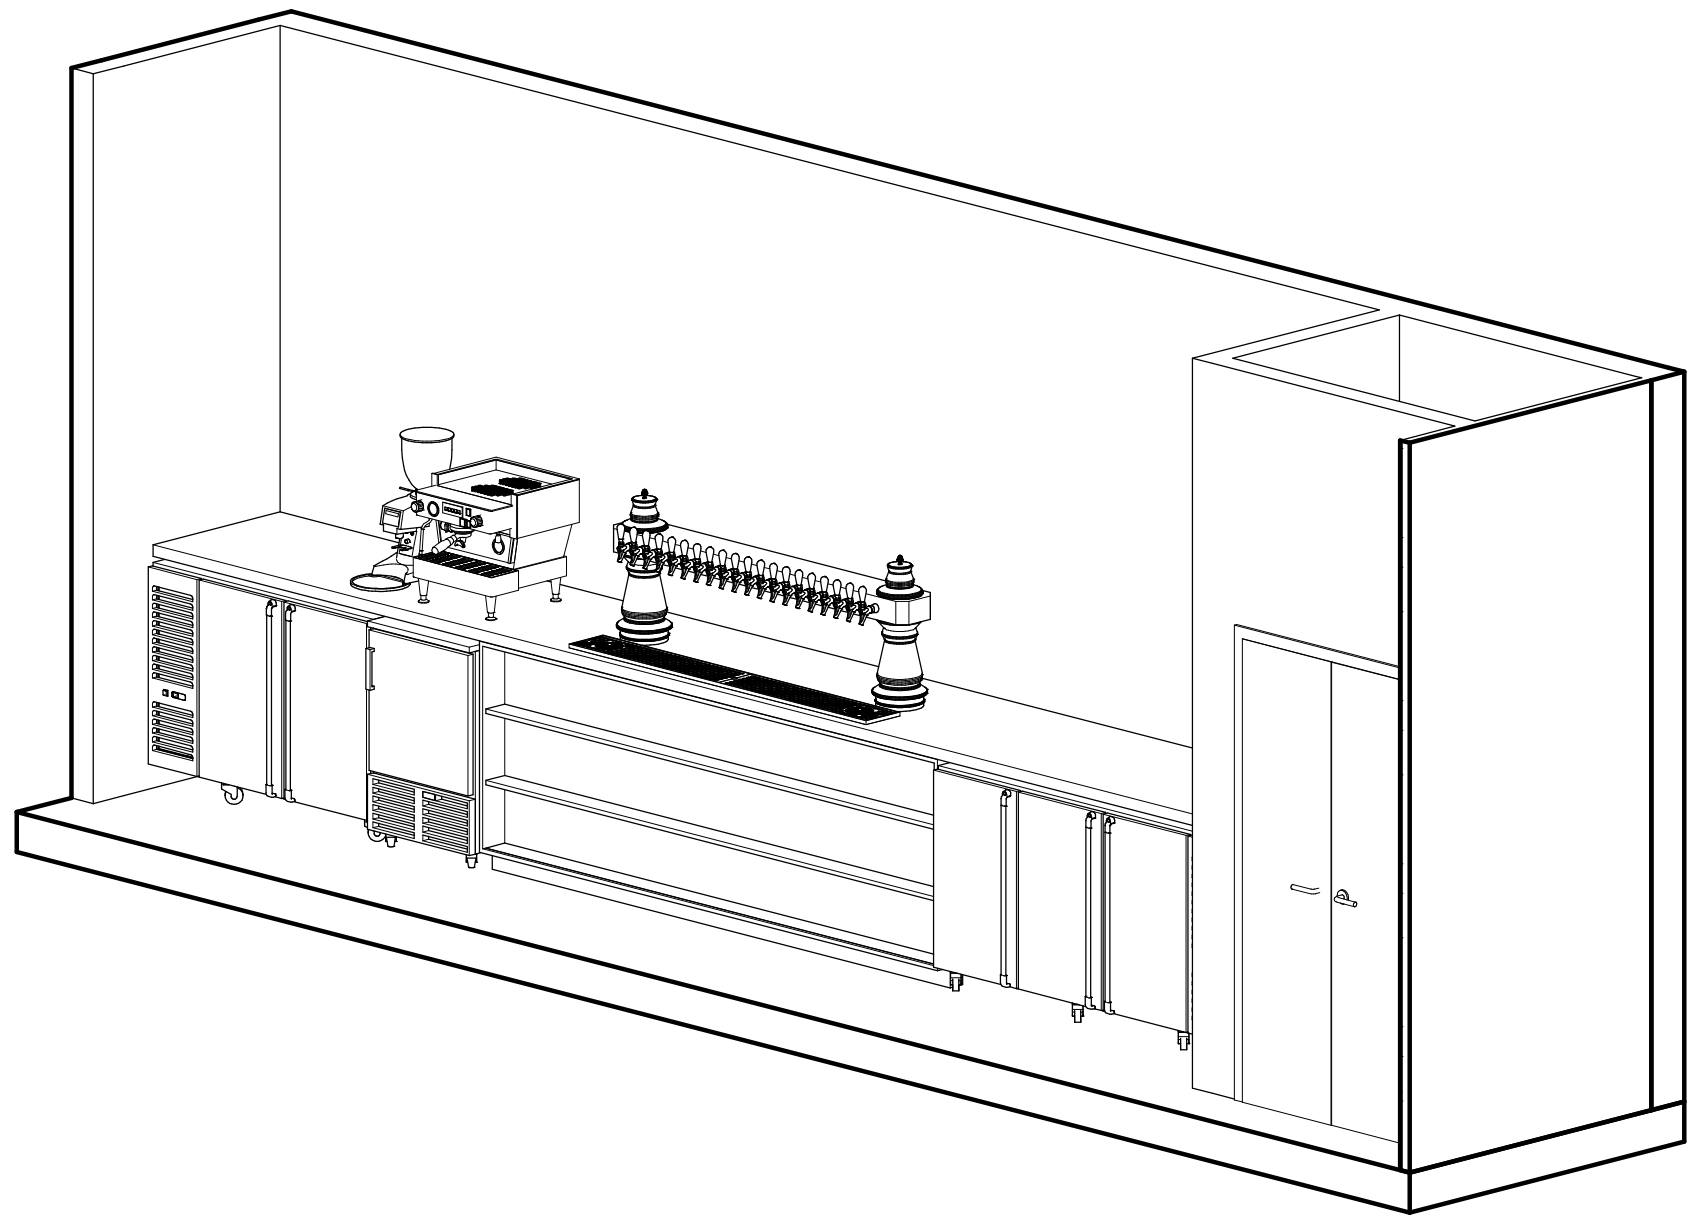

1 Interior Elevation - Level 2 Back Bar

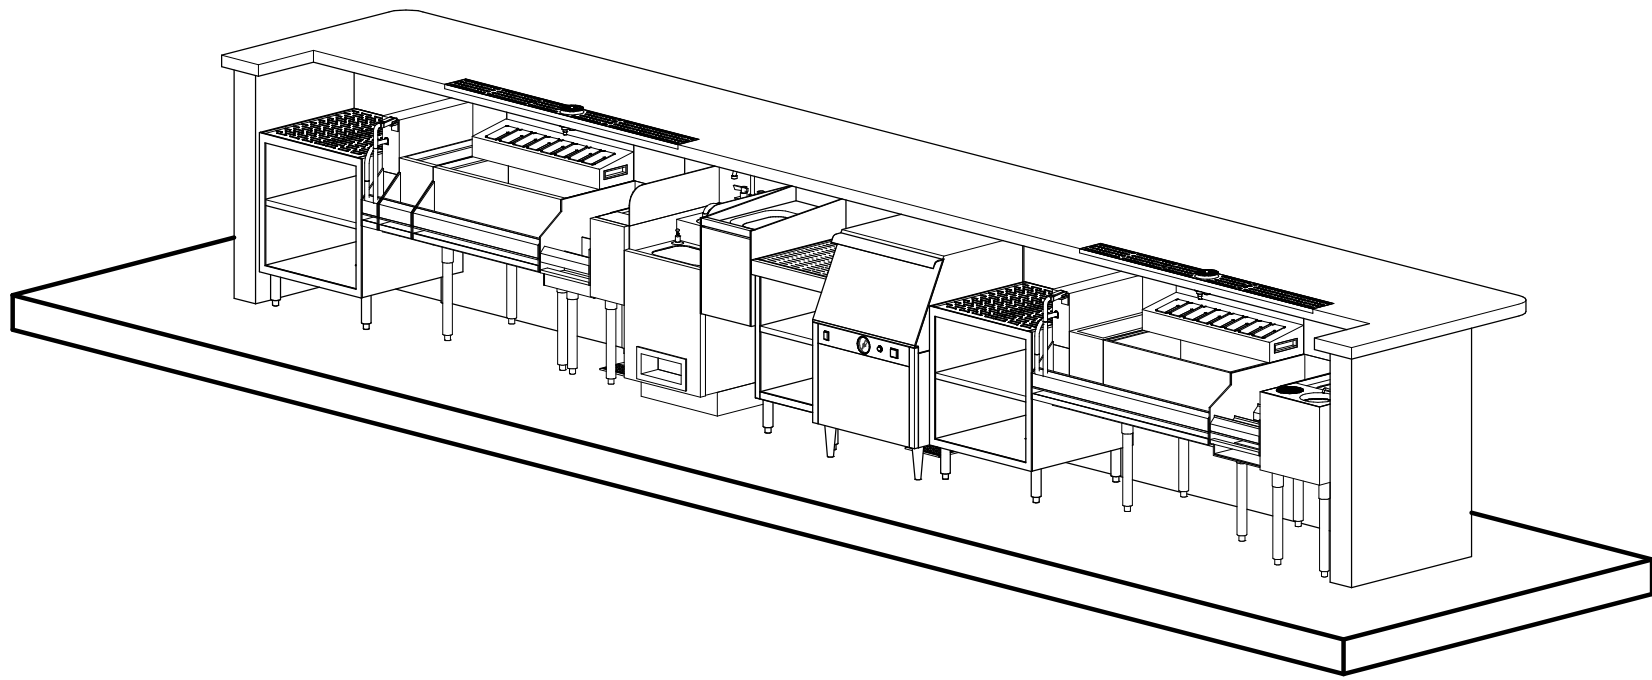

2 Interior Elevation - Level 2 Bar

3 Not Used  
N.T.S.

A New Facility For:

**The Lady**

Little Rock, AR




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Sheet Title:  
Kitchen Equipment  
Isometric Views  
Sheet No:

K7.1

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Date: 1/13/2025 2:01:29 PM  
User: A. LaPerch  
File: C:\Local Files\2024\24066.00\_The Lady\_Little Rock\_AR\_ALAPERCH\K125N.rvt



SCHEDULE OF BUYOUTS (ITEMS PROVIDED BY OTHERS)						
TAG	QTY.	MANUFACTURER	MODEL #	TYPE	POWER	SHIP TO TITAN?
2	2	JADE PRODUCTS	JBR-6-36	RANGE/OVEN	115V/1PH/4.0A - NEMA #5-15P	✗
3	1	VULCAN	VCCG48-AR	GRIDDLE	120V/1PH/2.0A - NEMA #5-15P	✗
4	1	BEVERAGE AIR	WTRCS48HC	CHEF BASE REFRIGERATOR	115V/1PH/3.3A - NEMA #5-15P	✗
5	1	VULCAN	2GR45MF	GAS FRYER	115V/1PH/6.0A - NEMA #5-15P	✗
6	2	T.B.D.	T.B.D.	HEAT LAMPS	(VERIFY VOLTAGE) - HARD WIRED	✓
7	1	DOYON	JA125L	CONVECTION OVEN	208V/1PH/103A - HARD WIRED	✗

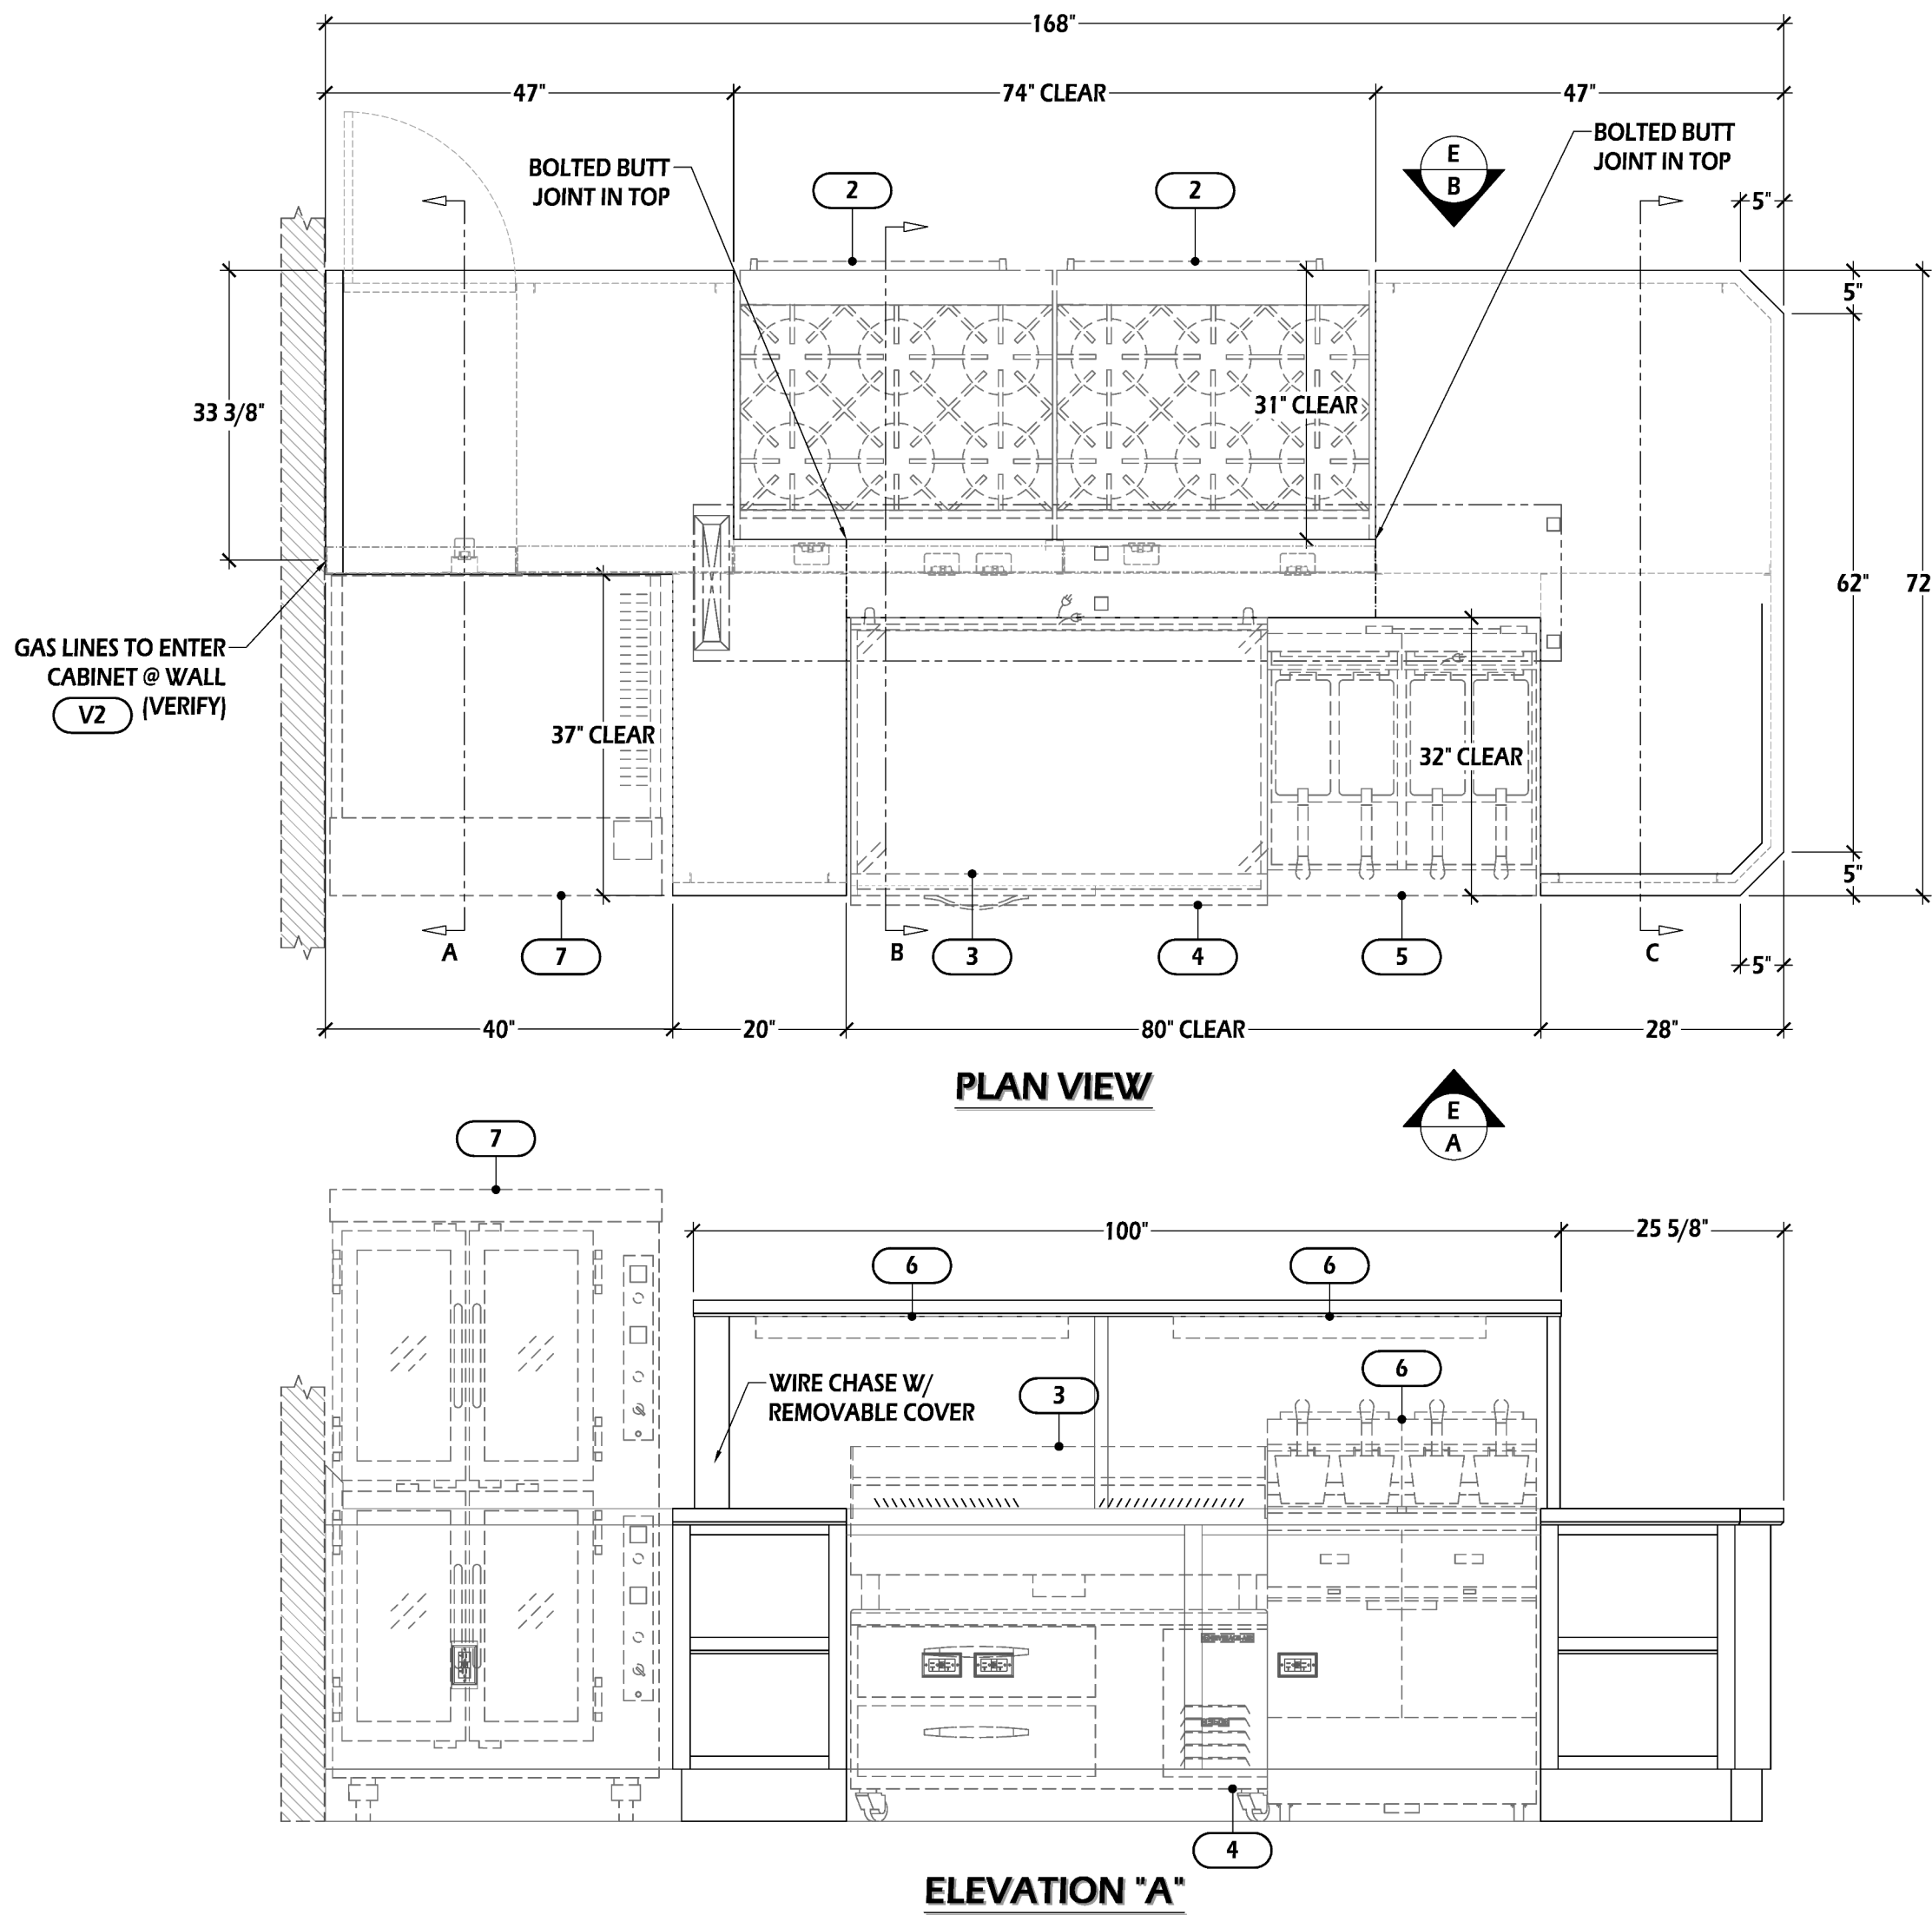COUNTER TO BE FABRICATED AS FOLLOWS, UNLESS OTHERWISE SPECIFIED:



TOP: (3) PIECES  
CABINET BODY: (4) PIECES  
OVERSHELF: (1) PIECE

GENERAL NOTES (ITEMS FABRICATED OR PROVIDED BY TITAN):

- TOP: 16 GA. S/S  
A. REINFORCEMENT: S/S
- BODY, HEADER, & UNDERSHELVING: 18 GA. S/S  
A. REINFORCEMENT: GALV.
- HINGED DOOR: 18 GA. S/S W/ FLAG HINGES & RECESSED DOOR PULL
- OVERSHELF: 16 GA. S/S  
A. REINFORCEMENT: S/S  
B. SUPPORTS: 1-1/2" SQ. S/S TUBING W/ EXPANSION FASTENERS  
C. WIRE CHASE & REMOVABLE COVERS: 18 GA. S/S
- CURB BASE: S/S

SCHEDULE OF REQUIRED CONFIRMATIONS (VERIFY LIST)  
ITEMS MUST BE CONFIRMED BEFORE RELEASING FOR PRODUCTION

TAG	DESCRIPTION
V1	NEED MAKE AND MODEL OF HEAT LAMPS
V2	VERIFY WHERE GAS LINES WILL ENTER CABINET

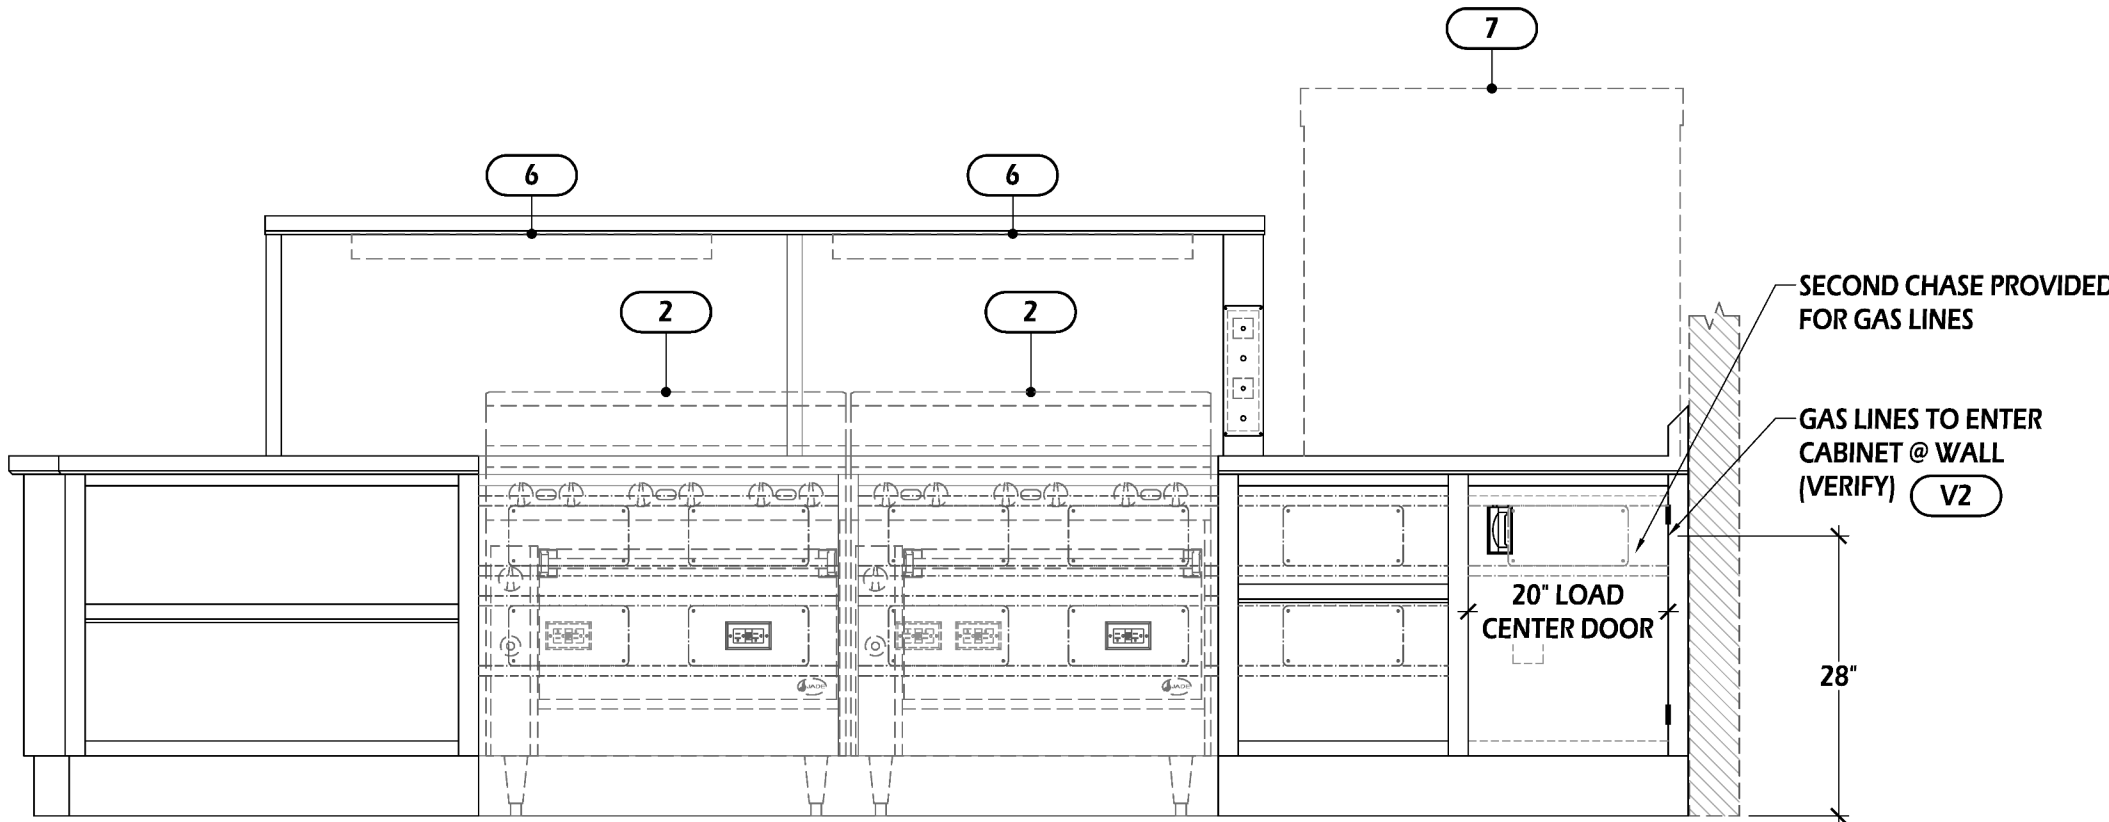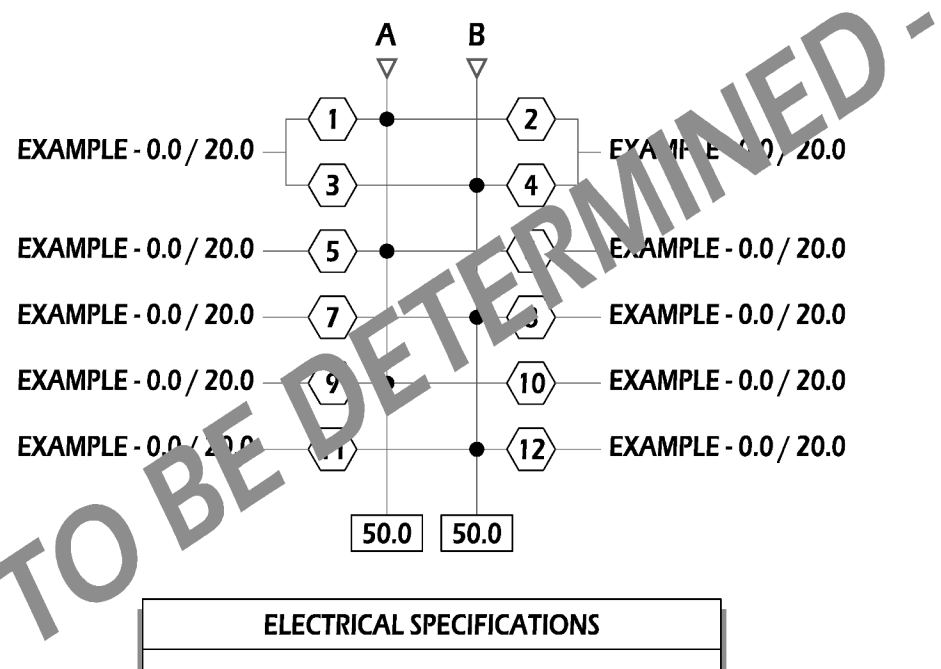

MODEL NUMBER: 168STC-72-100TMSS-18-CRB-MTR-ET	THIS DRAWING IS FOR APPROVAL PURPOSES - PLEASE REVIEW CAREFULLY	<input type="checkbox"/> APPROVED (AS NOTED)	<input type="checkbox"/> REVISE / RESUBMIT
ITEM NUMBER: 1	QUANTITY: 1	Drawing(s) must be APPROVED and SIGNED in ink before items are put into production	APPROVED BY: DATE:



KATOM  
RESTAURANT  
SUPPLY, INC.

THE LADY - AR

DRAWN BY:  
CY

DATE:  
01/08/2025

REVISED: BY:  
01/21/25 CY

SHEET #:

1

TOTAL SHEETS: 2

KaTom  
RESTAURANT SUPPLY INC.

305 KaTom Drive Kodak, TN 37764  
t (865) 225-1545 f (800) 821-9130  
www.KaTom.com

A New Facility For:

The Lady

Little Rock, AR

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FOR  
CONSTRUCTION


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Revisions:	
No.	Description
1	01/31/25 Beer Taps

Sheet Title:  
Kitchen Equipment  
Stainless Drawings  
Sheet No:


K8.0

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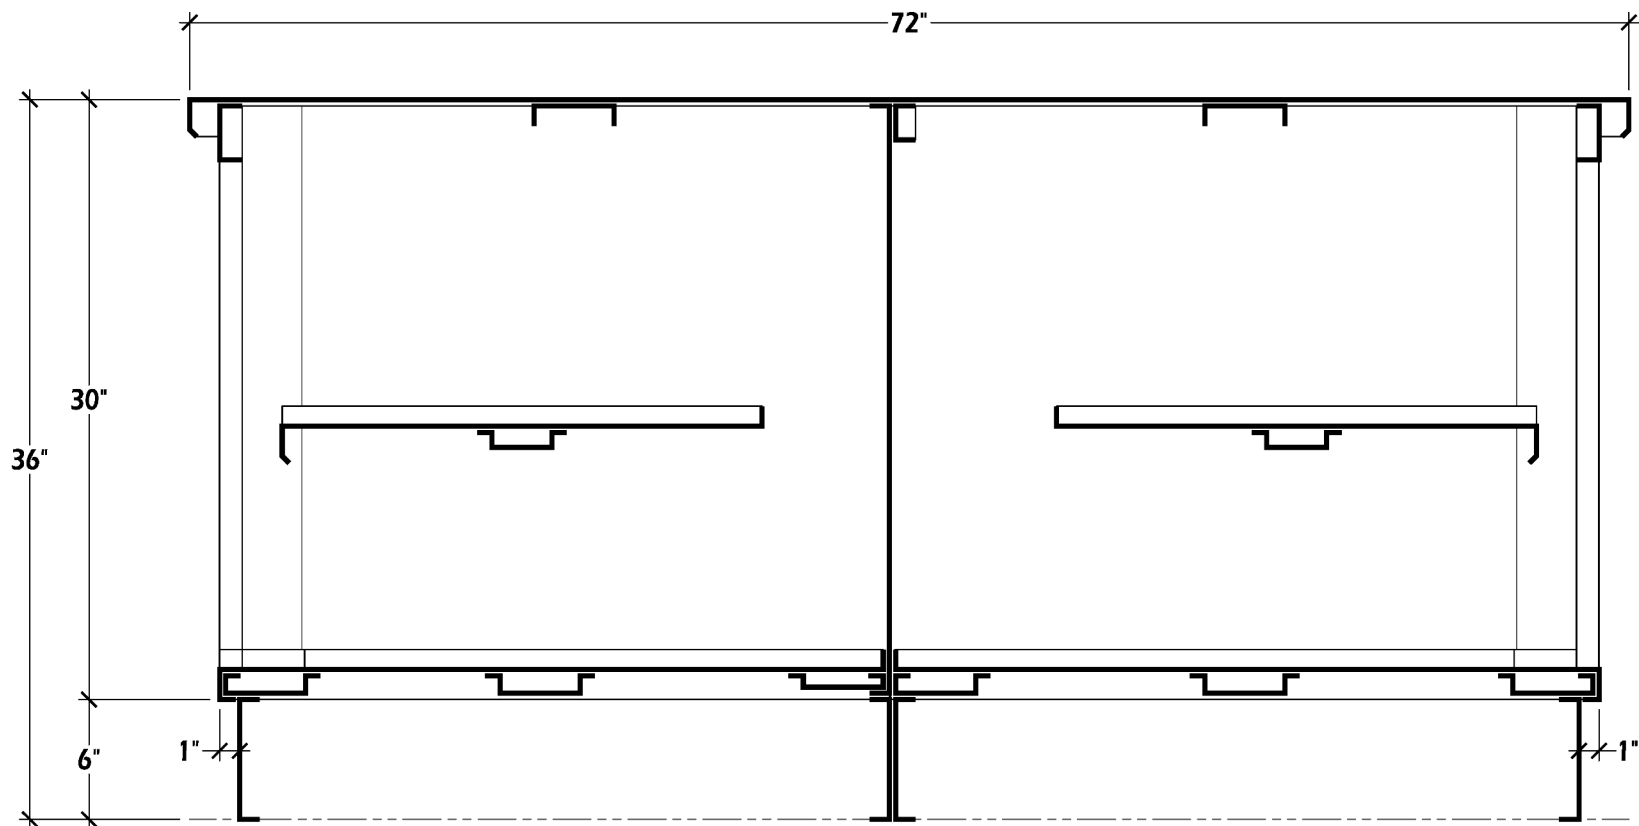
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SECTION "A"

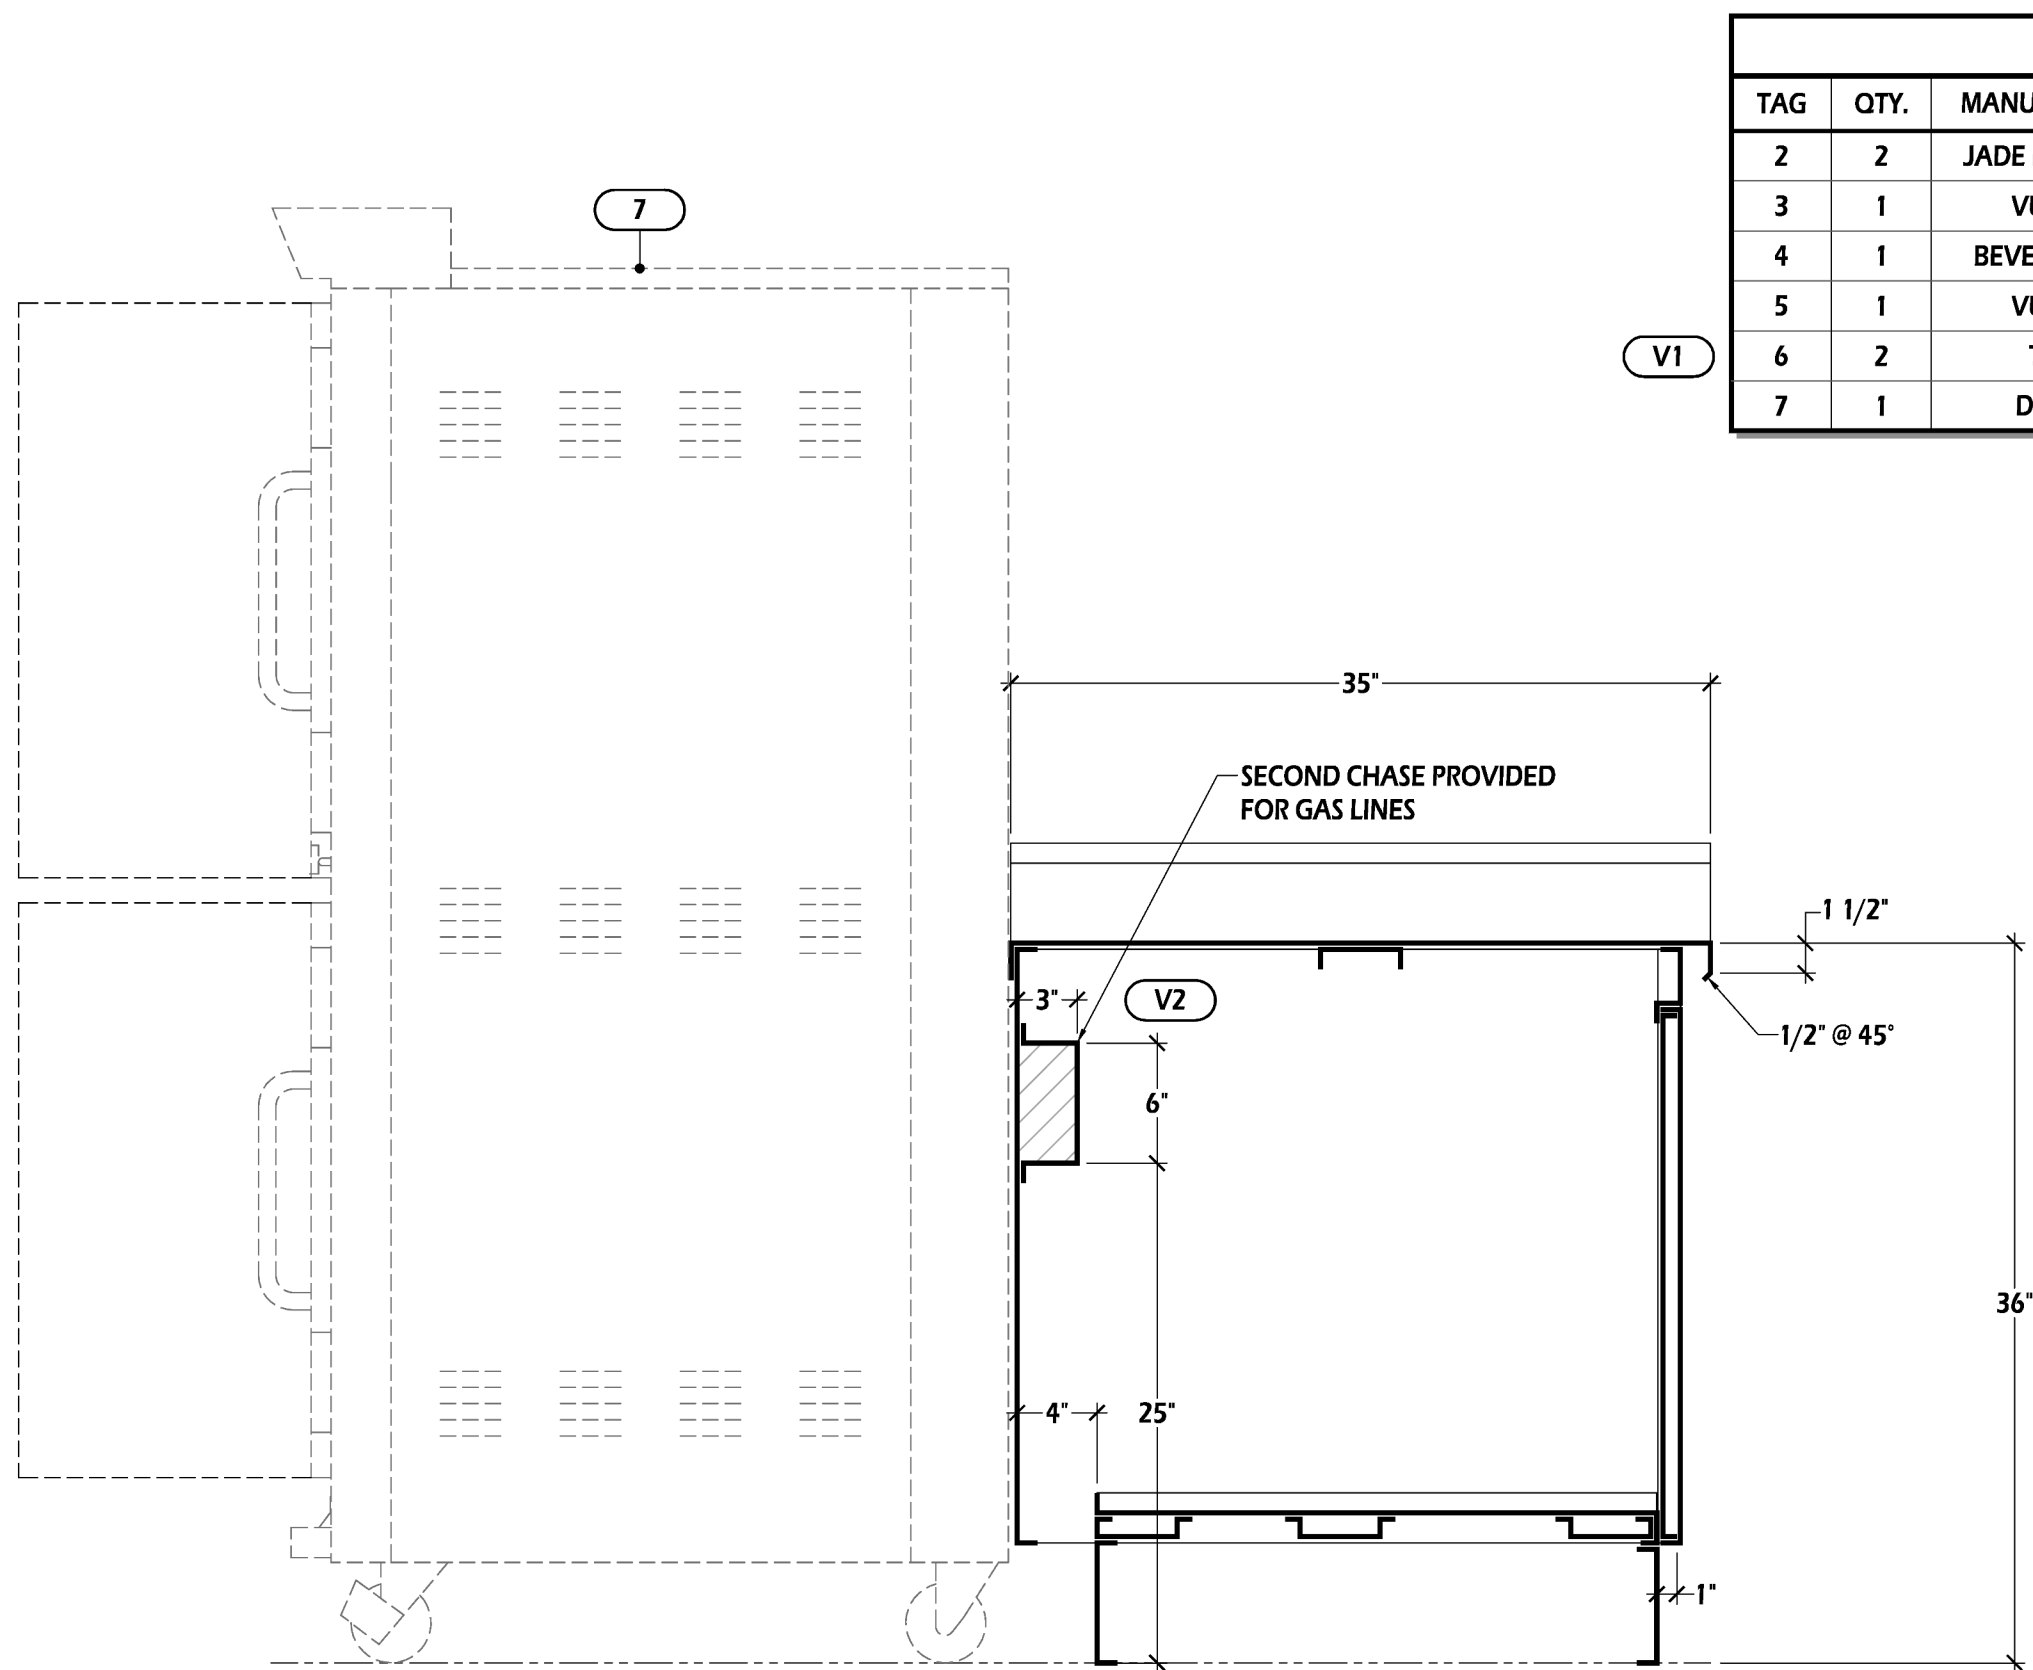

SECTION "B"

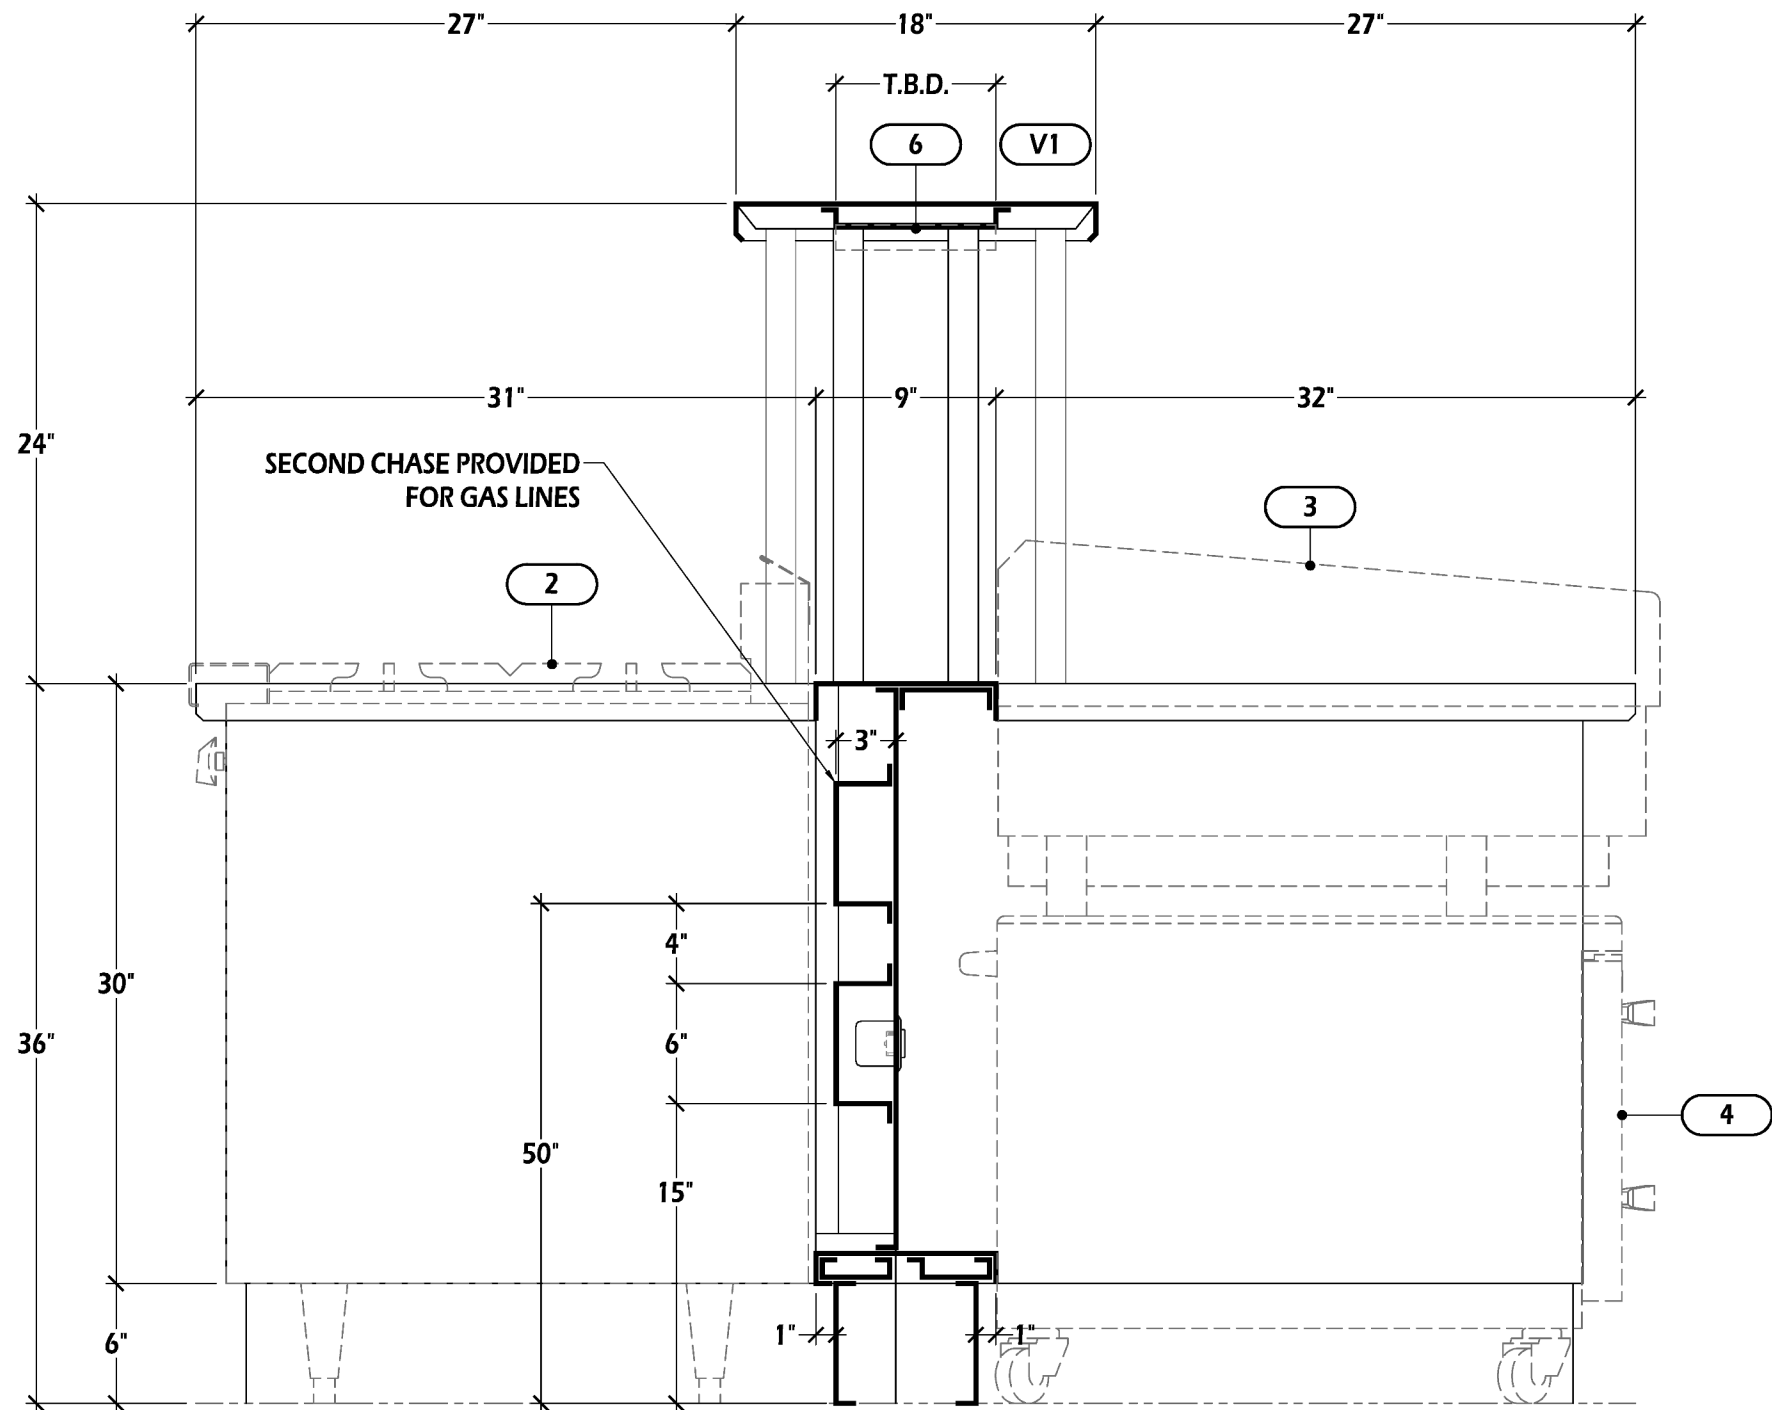

SECTION "C"

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4	1	BEVERAGE AIR	WTRCS48HC	CHEF BASE REFRIGERATOR	115V/1PH/3.3A - NEMA #5-15P	☒
5	1	VULCAN	2GR45MF	GAS FRYER	115V/1PH/6.0A - NEMA #5-15P	☒
6	2	T.B.D.	T.B.D.	HEAT LAMPS	(VERIFY VOLTAGE) - HARD WIRED	☑
7	1	DOYON	JA12SL	CONVECTION OVEN	208V/1PH/103A - HARD WIRED	☒

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B. WIRE CHASE & REMOVABLE COVERS: 18 GA. S/S
- HINGED DOOR: 18 GA. S/S W/ FLAG HINGES & RECESSED DOOR PULL
- OVERSHELF: 16 GA. S/S  
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TAG	DESCRIPTION
V1	NEED MAKE AND MODEL OF HEAT LAMPS
V2	VERIFY WHERE GAS LINES WILL ENTER CABINET

**TITAN**  
STAINLESS

502 USHER STREET PACELAND, SC 29728  
PHONE: 704-243-8777 FAX: 843-672-2211  
ONLINE: WWW.TITANSTAINLESS.COM



**KATOM**  
RESTAURANT  
SUPPLY, INC.

**THE LADY - AR**

DRAWN BY:  
CY

DATE:  
**01/08/2025**

REVISED: BY:  
**01/21/25 CY**

SHEET #:

**2**

TOTAL SHEETS: 2

A New Facility For:

**The Lady**

Little Rock, AR

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