

DOOR SCHEDULE - BUILDING 600 / HENDERSON

DOOR NO.	TYPE	DOOR			LOUVER			FRAME			FRAME FINISH			FIRE RATING IN MINUTES	HARDWARE SET NO.	DOOR NO.	COMMENTS
		W	HT	THK	MATERIAL	W	H	TYPE	MATERIAL	FINISH	HEAD	JAMB	THRS/SLD.				
B600-101A	A	3'-0"	7'-0"	1 3/4"	IHM	-	-	HM-1	HM	PAINTED	1/A-520	2/A-520	5/A-520	2.0	2.0	B600-101A	
B600-101B	A	3'-0"	7'-0"	1 3/4"	IHM	-	-	HM-1	HM	PAINTED	1/A-520	2/A-520	5/A-520	2.0	2.0	B600-101B	
B600-102	B	4'-0"	7'-0"	1 3/4"	IHM	-	-	HM-1	HM	PAINTED	7/A-521	8/A-521	9/A-521	60 MIN.	7.0	B600-102	SUPPLY HOLD OPEN
B600-103A	B	3'-0"	7'-0"	-	IHM	-	-	HM-1	HM	PAINTED	1/A-521	2/A-521	-	9.0	B600-103A		
B600-103B	OHD-1	12'-0"	14'-0"	-	ALUM.	-	-	-	-	-	9/A-521	10/A-521	-	15.0	B600-103B	RYTEC - HIGH PERFORMANCE, HIGH SECURITY AND HIGH SPEED SPIRAL ROLL UP DOOR	
B600-103C	OHD-1	12'-0"	14'-0"	-	ALUM.	-	-	-	-	-	9/A-521	10/A-521	-	15.0	B600-103C	RYTEC - HIGH PERFORMANCE, HIGH SECURITY AND HIGH SPEED SPIRAL ROLL UP DOOR	
B600-103D	B	3'-0"	7'-0"	-	IHM	-	-	HM-1	HM	PAINTED	1/A-521	2/A-521	-	9.0	B600-103D		
B600-103E	OHD-1	12'-0"	14'-0"	-	ALUM.	-	-	-	-	-	3/A-520	4/A-520	-	15.0	B600-103E	RYTEC - HIGH PERFORMANCE, HIGH SECURITY AND HIGH SPEED SPIRAL ROLL UP DOOR	
B600-104	A	3'-0"	7'-0"	1 3/4"	HM	-	-	HM-1	HM	PAINTED	5/A-521	6/A-521	60 MIN.	3.0	B600-104		
B600-105	AA	6'-0"	7'-0"	1 3/4"	WOOD	-	-	HM-2	HM	PAINTED	3/A-521	4/A-521	-	5.0	B600-105		
B600-107A	OHD-1	8'-0"	8'-0"	-	-	-	-	-	-	-	-	-	INTEGRAL	-	B600-107A	RYTEC - HIGH PERFORMANCE, HIGH SECURITY AND HIGH SPEED SPIRAL ROLL UP DOOR	
B600-107B	B	3'-0"	7'-0"	-	IHM	-	-	HM-1	IHM	PAINTED	-	-	-	-	B600-107B	INSULATED DOOR AND FRAME	
B600-107C	OHD-1	8'-0"	8'-0"	-	-	-	-	-	-	-	-	-	INTEGRAL	-	B600-107C	RYTEC - HIGH PERFORMANCE, HIGH SECURITY AND HIGH SPEED SPIRAL ROLL UP DOOR	
B600-EX	EXIST	3'-0"	7'-0"	-	-	-	-	-	-	-	-	-	32.0	B600-EX	B600-EX	SUPPLY CARD READER	

DOOR SCHEDULE NOTES:
• REPLACE DOOR HINGES AND BOTTOM WETHER SEALS ON ALL EXTREIOR EXISTING DOORS.

MATERIALS	
AL	ALUMINUM
ALG	ALUMINUM AND GLASS STOREFRONT DOOR
CT	CLEAR TEMPERED GLASS
CW	CLEAR WIRE GLASS (VERTICAL AND HORIZONTAL WIRE PATTERN - NOT DIAGONAL)
GHM	GALVANIZED HOLLOW METAL
HM	HOLLOW METAL
IHM	INSULATED HOLLOW METAL
SCW	SOLID CORE WOOD
ST	STEEL
W	WOOD
MATERIALS	
S	STAIN
P	PAINT
CA	CLEAR ANODIZED

ROOM FINISH SCHEDULE															
NUMBER	ROOM NAME	FLOOR	BASE	NORTH WALL		SOUTH WALL		EAST WALL		WEST WALL		CEILING		ROOM NUMBER	REMARKS
				MATERIAL	COLOR	MATERIAL	COLOR	MATERIAL	COLOR	MATERIAL	COLOR	MATERIAL	COLOR		
B600-100	PROCESS AREA	CF	---	IMP/GWB	---/EPT-1	IMP	---	IMP	---	IMP	---	---	---	B600-100	
B600-102	CHEM. STOR.	CF	RB-1	GWB	EPT-1	GWB	EPT-1	GWB	EPT-1	GWB	EPT-1	GWB	EPT-2	B600-102	
B600-103	SHIPPING / RECEIVING	CF	RB-1/---	GWB	EPT-1	MP	---	MP	---	GWB	EPT-1	---	---	B600-103	
B600-104	ELEC.	CF	---	GWB	EPT-1	GWB	EPT-1	GWB	EPT-1	IMP	---	---	---	B600-104	
B600-105	JAN.	CF	RB-1	MRGWB/FRP	EPT-1/FRP-1	MRGWB	EPT-1	MRGWB	EPT-1	MRGWB/FRP	EPT-1/FRP-1	---	---	B600-105	
B600-107	DEHUMIDIFYING	CF	---	IMP	---	IMP	---	IMP	---	IMP	---	---	---	B600-107	


MATERIAL LEGEND	
---	"NO" OR "NONE"
CF	CONCRETE FINISH
CG	CORNER GUARD
CONC	SEALED CONCRETE
EPT	EPOXY PAINT
EXP	EXPOSED
FRP	FIBERGLASS REINFORCED PANEL
GWB	GYPSUM WALL BOARD
IMP	INSULATED METAL PANEL
MD	METAL DECKING
MRGWB	MOISTURE RESISTANT GYPSUM WALL BOARD
RB	RESILIENT BASE

GENERAL NOTES:

- HOLLOW METAL DOORS AND FRAMES TO BE SEMI-GLOSS PAINT TO MATCH ADJACENT WALL.
- JANITORS CLOSETS TO RECEIVE 4'-0" HIGH FRP WAINSCOT AT SINK AREA ONLY. FRP TO START AT TOP OF SPECIFIED BASE.
- EXPOSED COLUMN MATERIAL AND FINISH TO MATCH ADJACENT WALLS.
- WOOD DOOR STAIN TO BE FACTORY FINISHED AND SELECTED FROM MANUFACTURER'S STANDARD OFFERING.
- CORNER GUARD LOCATIONS SHOWN ON B600-A-101


FINISHES LEGEND

FLOORS	
CF	RESTOCRETE POLISHED CONCRETE SYSTEM
CONC	SEALED CONCRETE
BASE	
RB-1	JOHNSONITE/TARKETT, 4"H BASEWORKS THERMOSET RUBBER WALL BASE. COLOR: 20 CHARCOAL
WALLS	
EPT-1	BENJAMIN MOORE, DECORATOR'S WHITE OC-149 EPOXY PAINT WITH SATIN/EG-SHEL FINISH
FRP-1	CRANE COMPOSITES, GLASBORD CLASS A, 4' X 8' PANEL SIZE, COLOR: WHITE WITH EMBOSSED FINISH
IMP	FACTORY FINISHED. SELECT COLOR FROM STANDARD FINISH OPTIONS.
CEILINGS	
EPT-2	SHERWIN WILLIAMS, SW7007 BRIGHT CEILING WHITE, EPOXY PAINT WITH SATIN/EG-SHEL FINISH
MD	FACTORY FINISHED. SELECT COLOR FROM STANDARD FINISH OPTIONS.
MISCELLANEOUS	
CG	CS ACROVYN STAINLESS STEEL CORNER GUARD, SCO-8, 3 1/2" WING, TYPE 304, SATIN FINISH

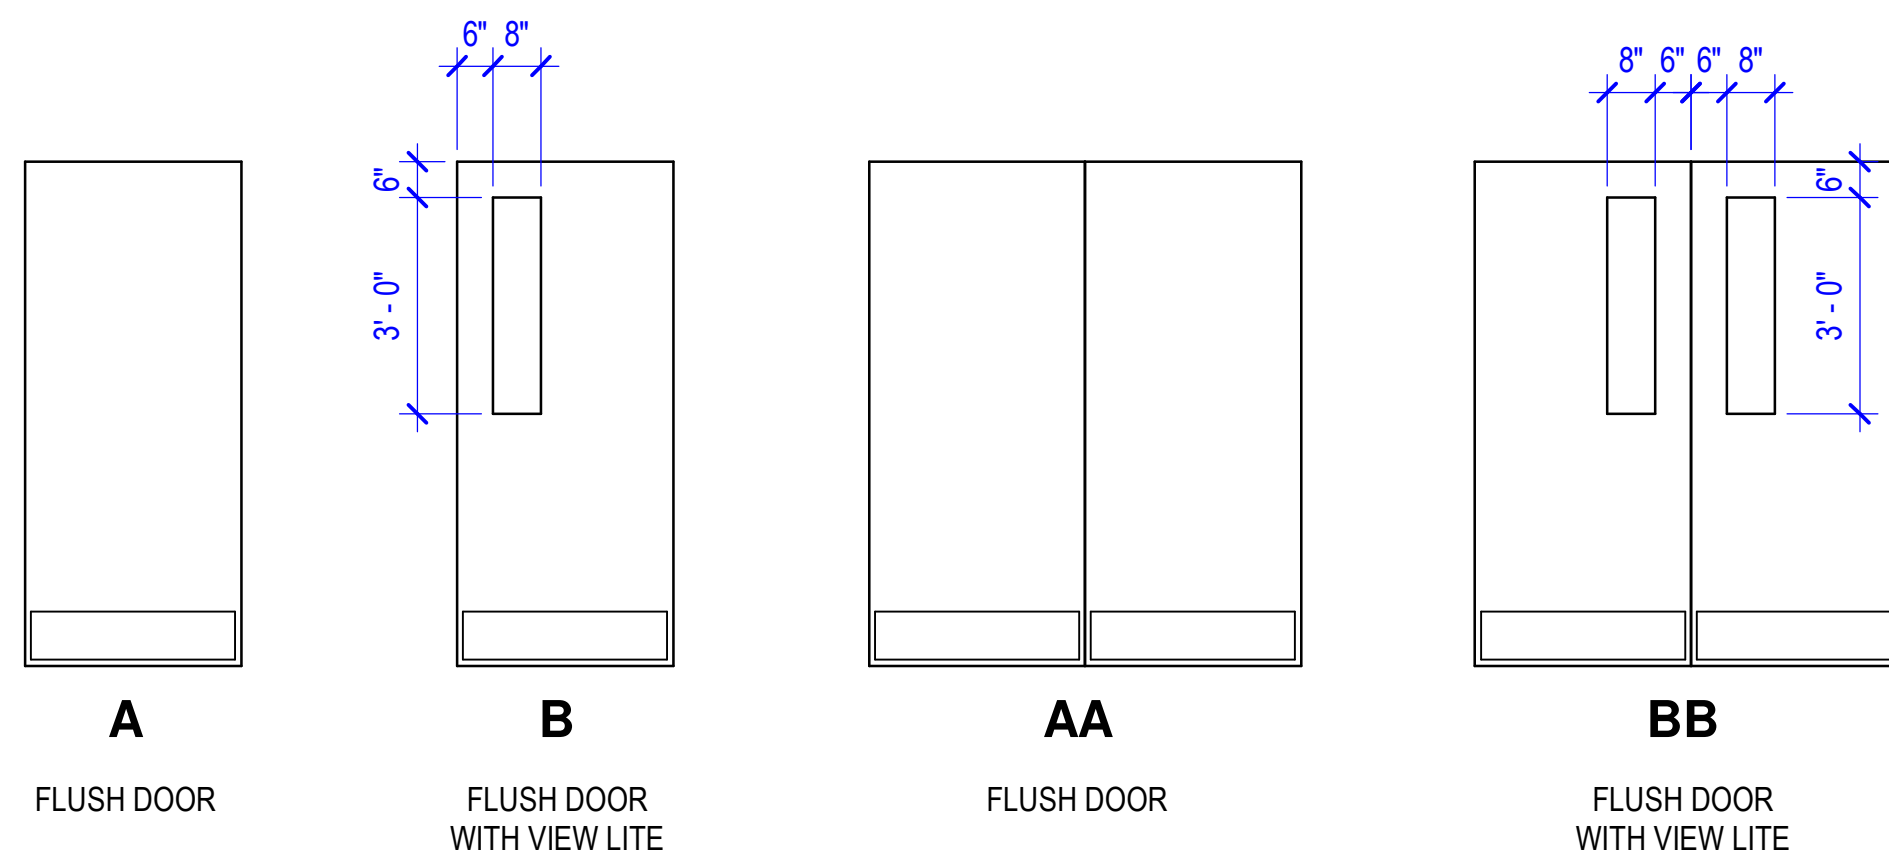


1 DOOR TYPE A
3/8" = 1'-0"

2 DOOR TYPE AA
3/8" = 1'-0"

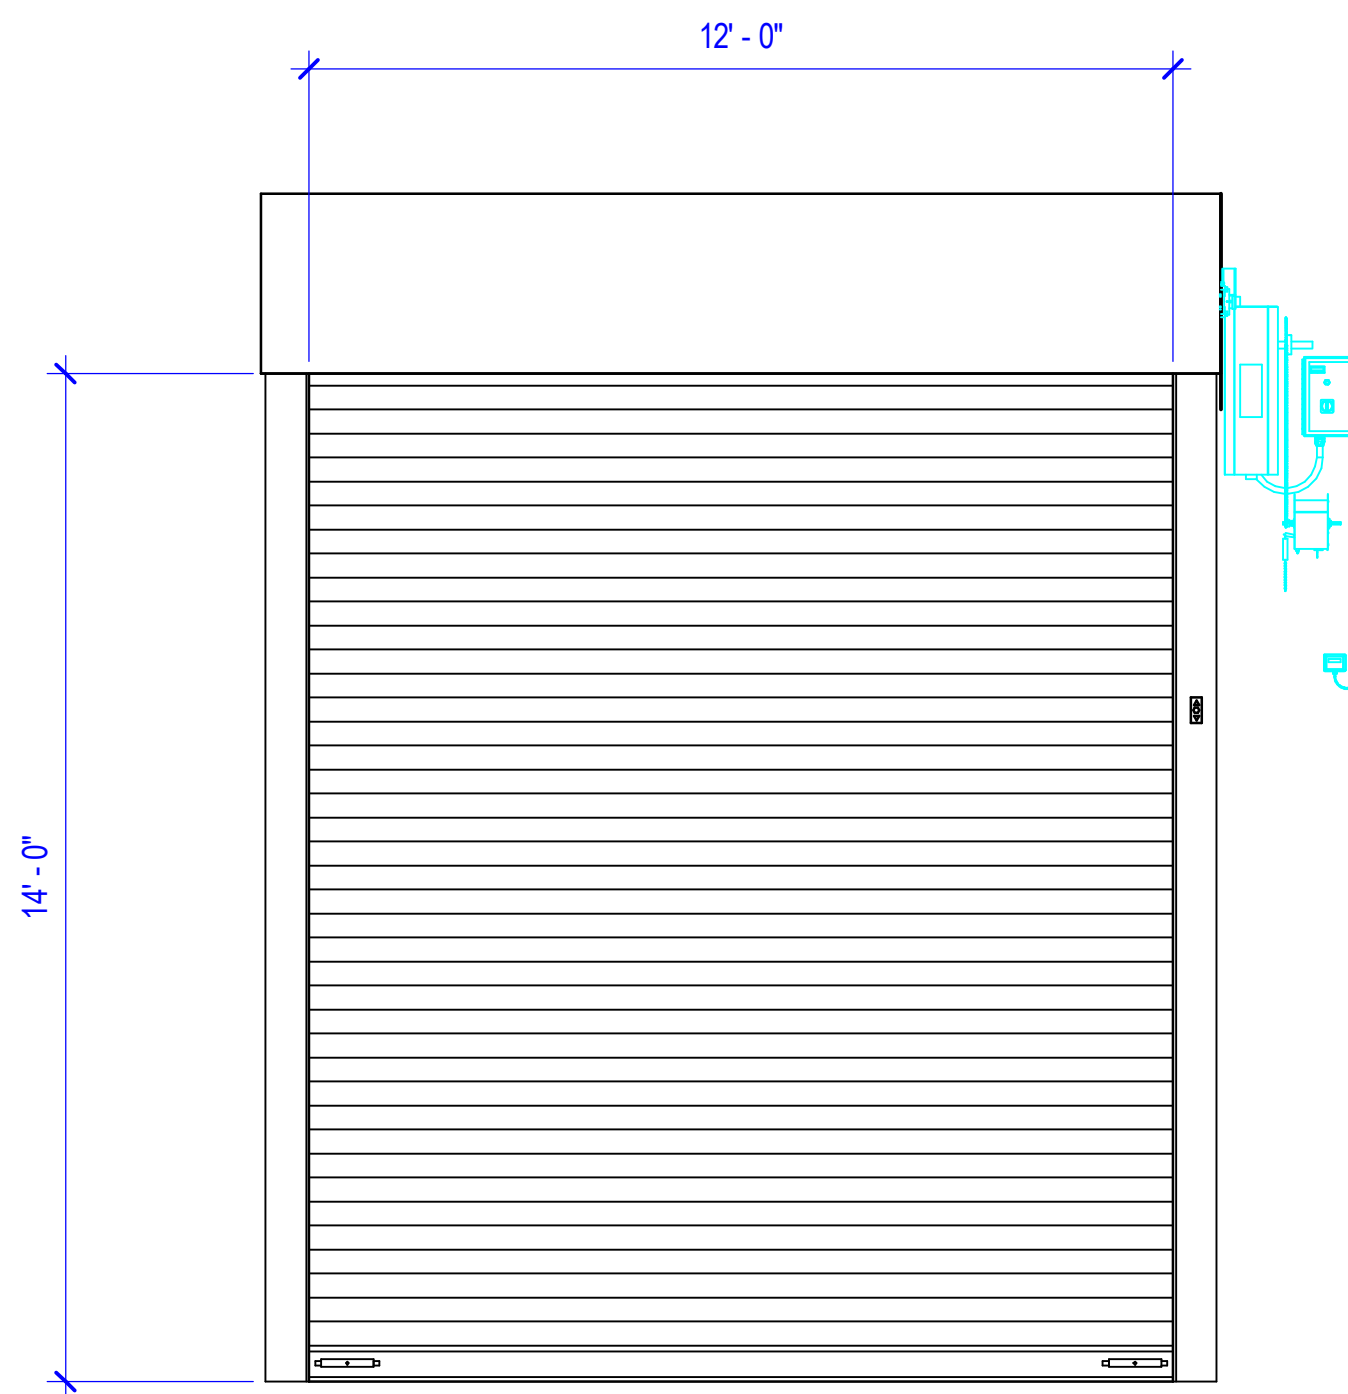

HIGH SPEED OPERATING EXTERIOR INSULATED PAINTED OVERHEAD COILING DOOR

3 OHD-1
3/8" = 1'-0"

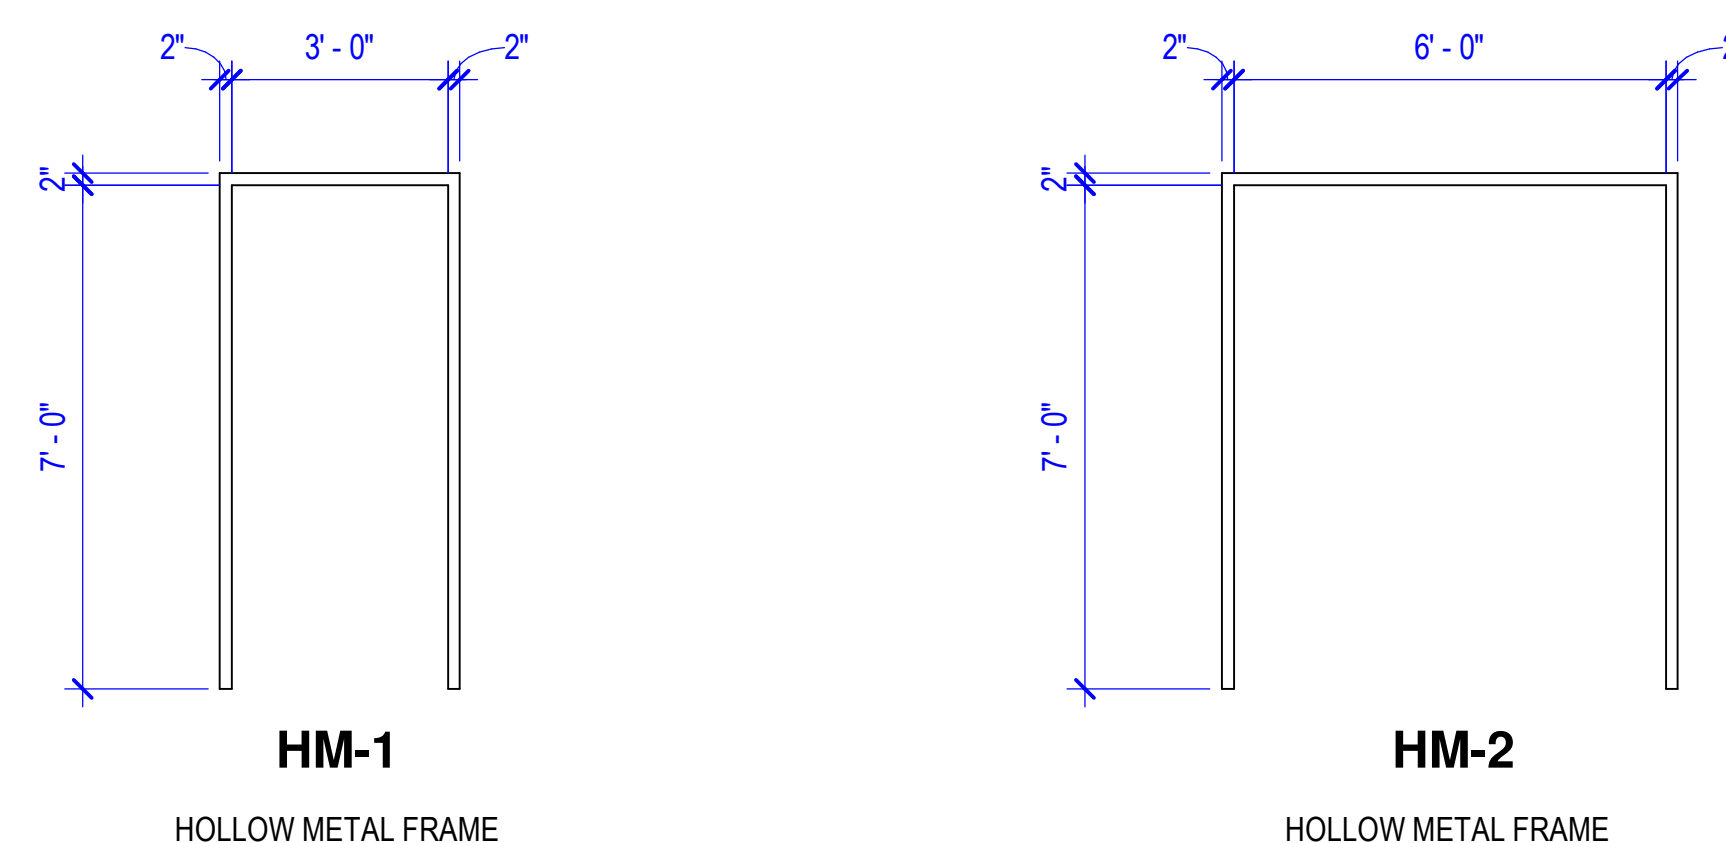

4 DOOR FRAME TYPES
3/8" = 1'-0"

Project

Anduril Industries - McHenry, MS
Rocket Motor Systems
Additions and Renovations to Buildings 300, 301, 302, 400, 600 and 700 - McHenry, Mississippi

Design Phase

CONSTRUCTION DOCUMENTS

Revisions

No.	Date	Description
1	03-18-2024	RB 003
2	11-21-2024	RB 013

Notes

1. THIS SHEET DESIGNED FOR COLOR PRINTING. CRITICAL INFORMATION MAY BE LOST WITH BLACK AND WHITE PRINTING.

Project Number 2023-047
Issue Date 10-26-2023
Sheet Title DOOR SCHEDULE AND FINISH SCHEDULE
Sheet Number B600-A-601

Stamp

10-26-2023