
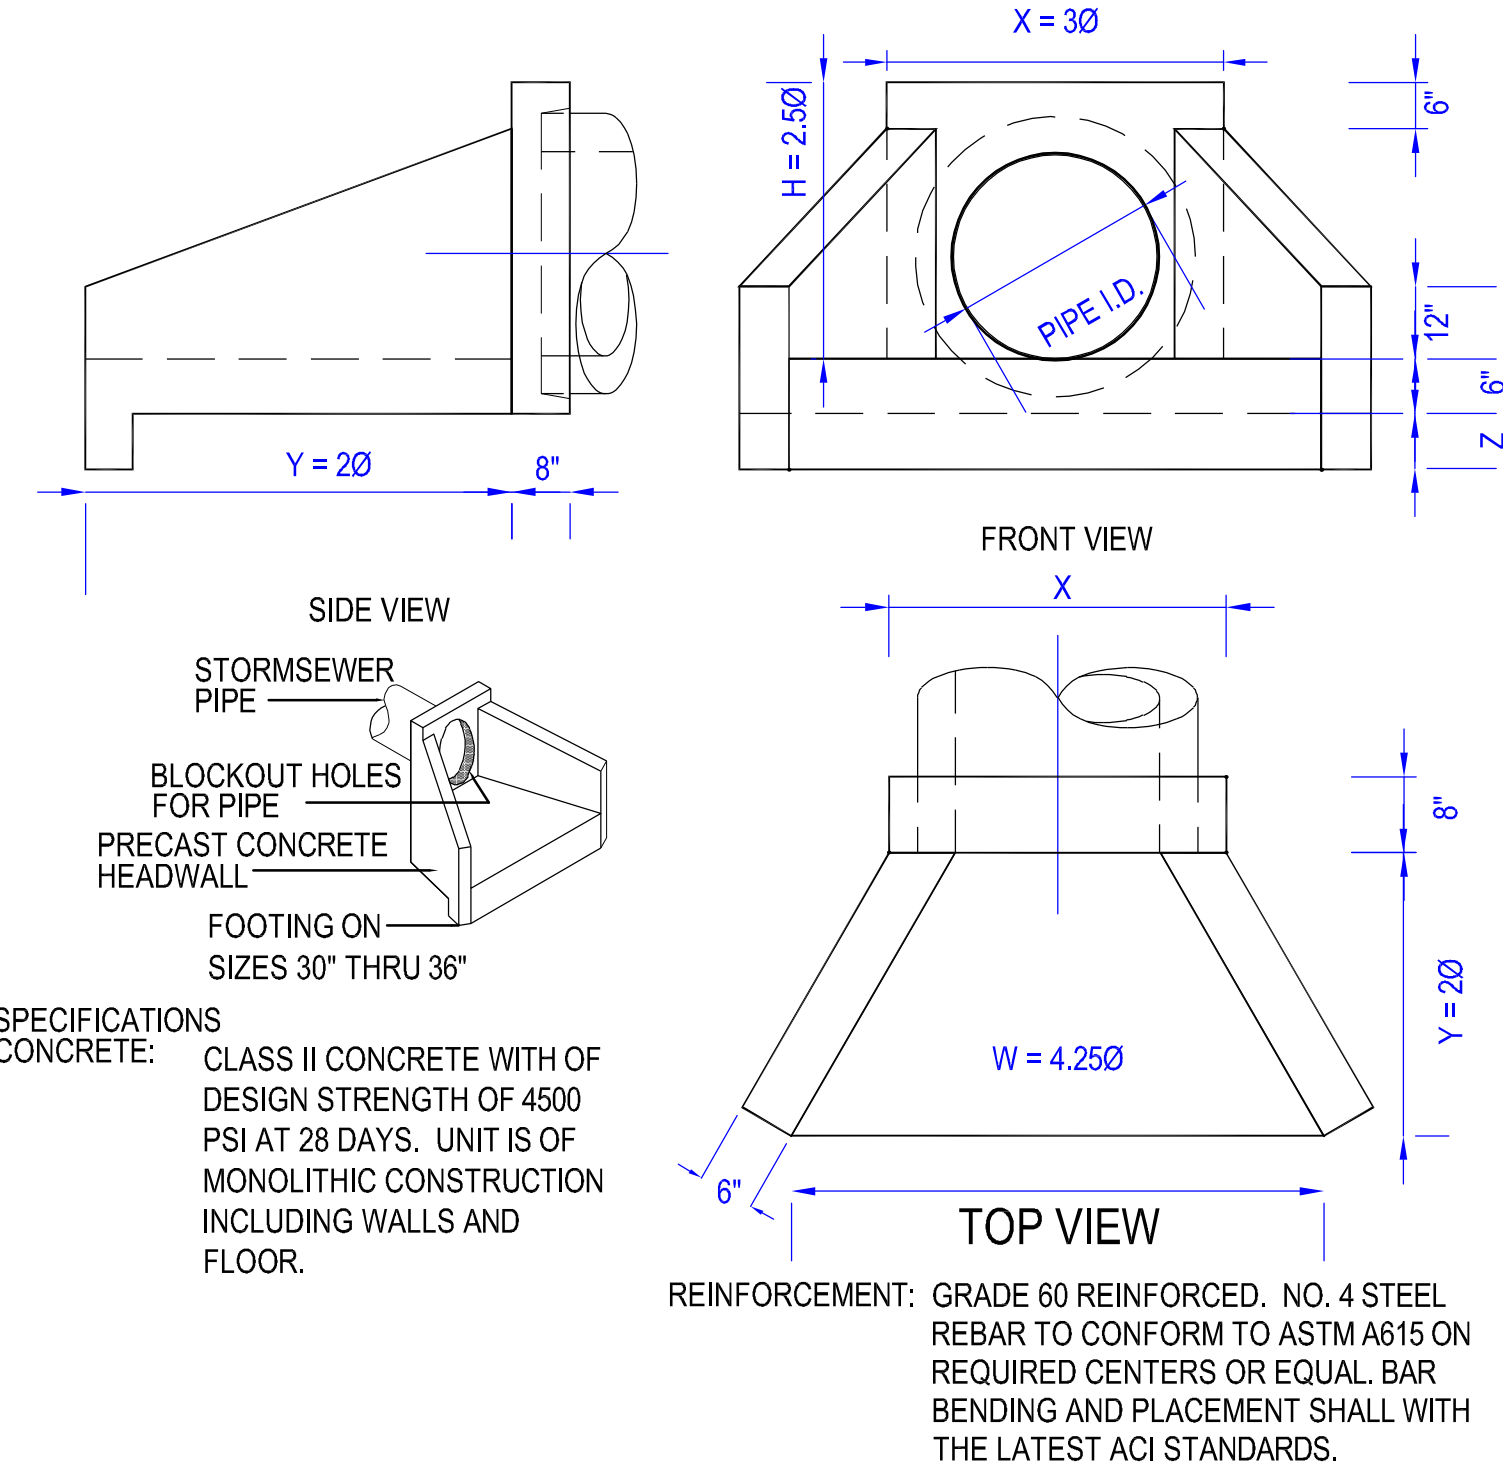


LEGEND

- EXISTING GRADE CONTOUR
(1 FOOT INTERVAL) ---142---
- EXISTING GRADE CONTOUR
(5 FOOT INTERVAL) ---145---
- FINISHED GRADE CONTOUR
(1 FOOT INTERVAL) 142
- FINISHED GRADE CONTOUR
(5 FOOT INTERVAL) 150
- 7CU. FT. OF DUMPED RIPRAP
UNDERLAIN BY FILTER FABRIC STONE
SIZE TO BE SIMILAR TO SECTION 816 OF
ARDOT STANDARD SPECIFICATIONS

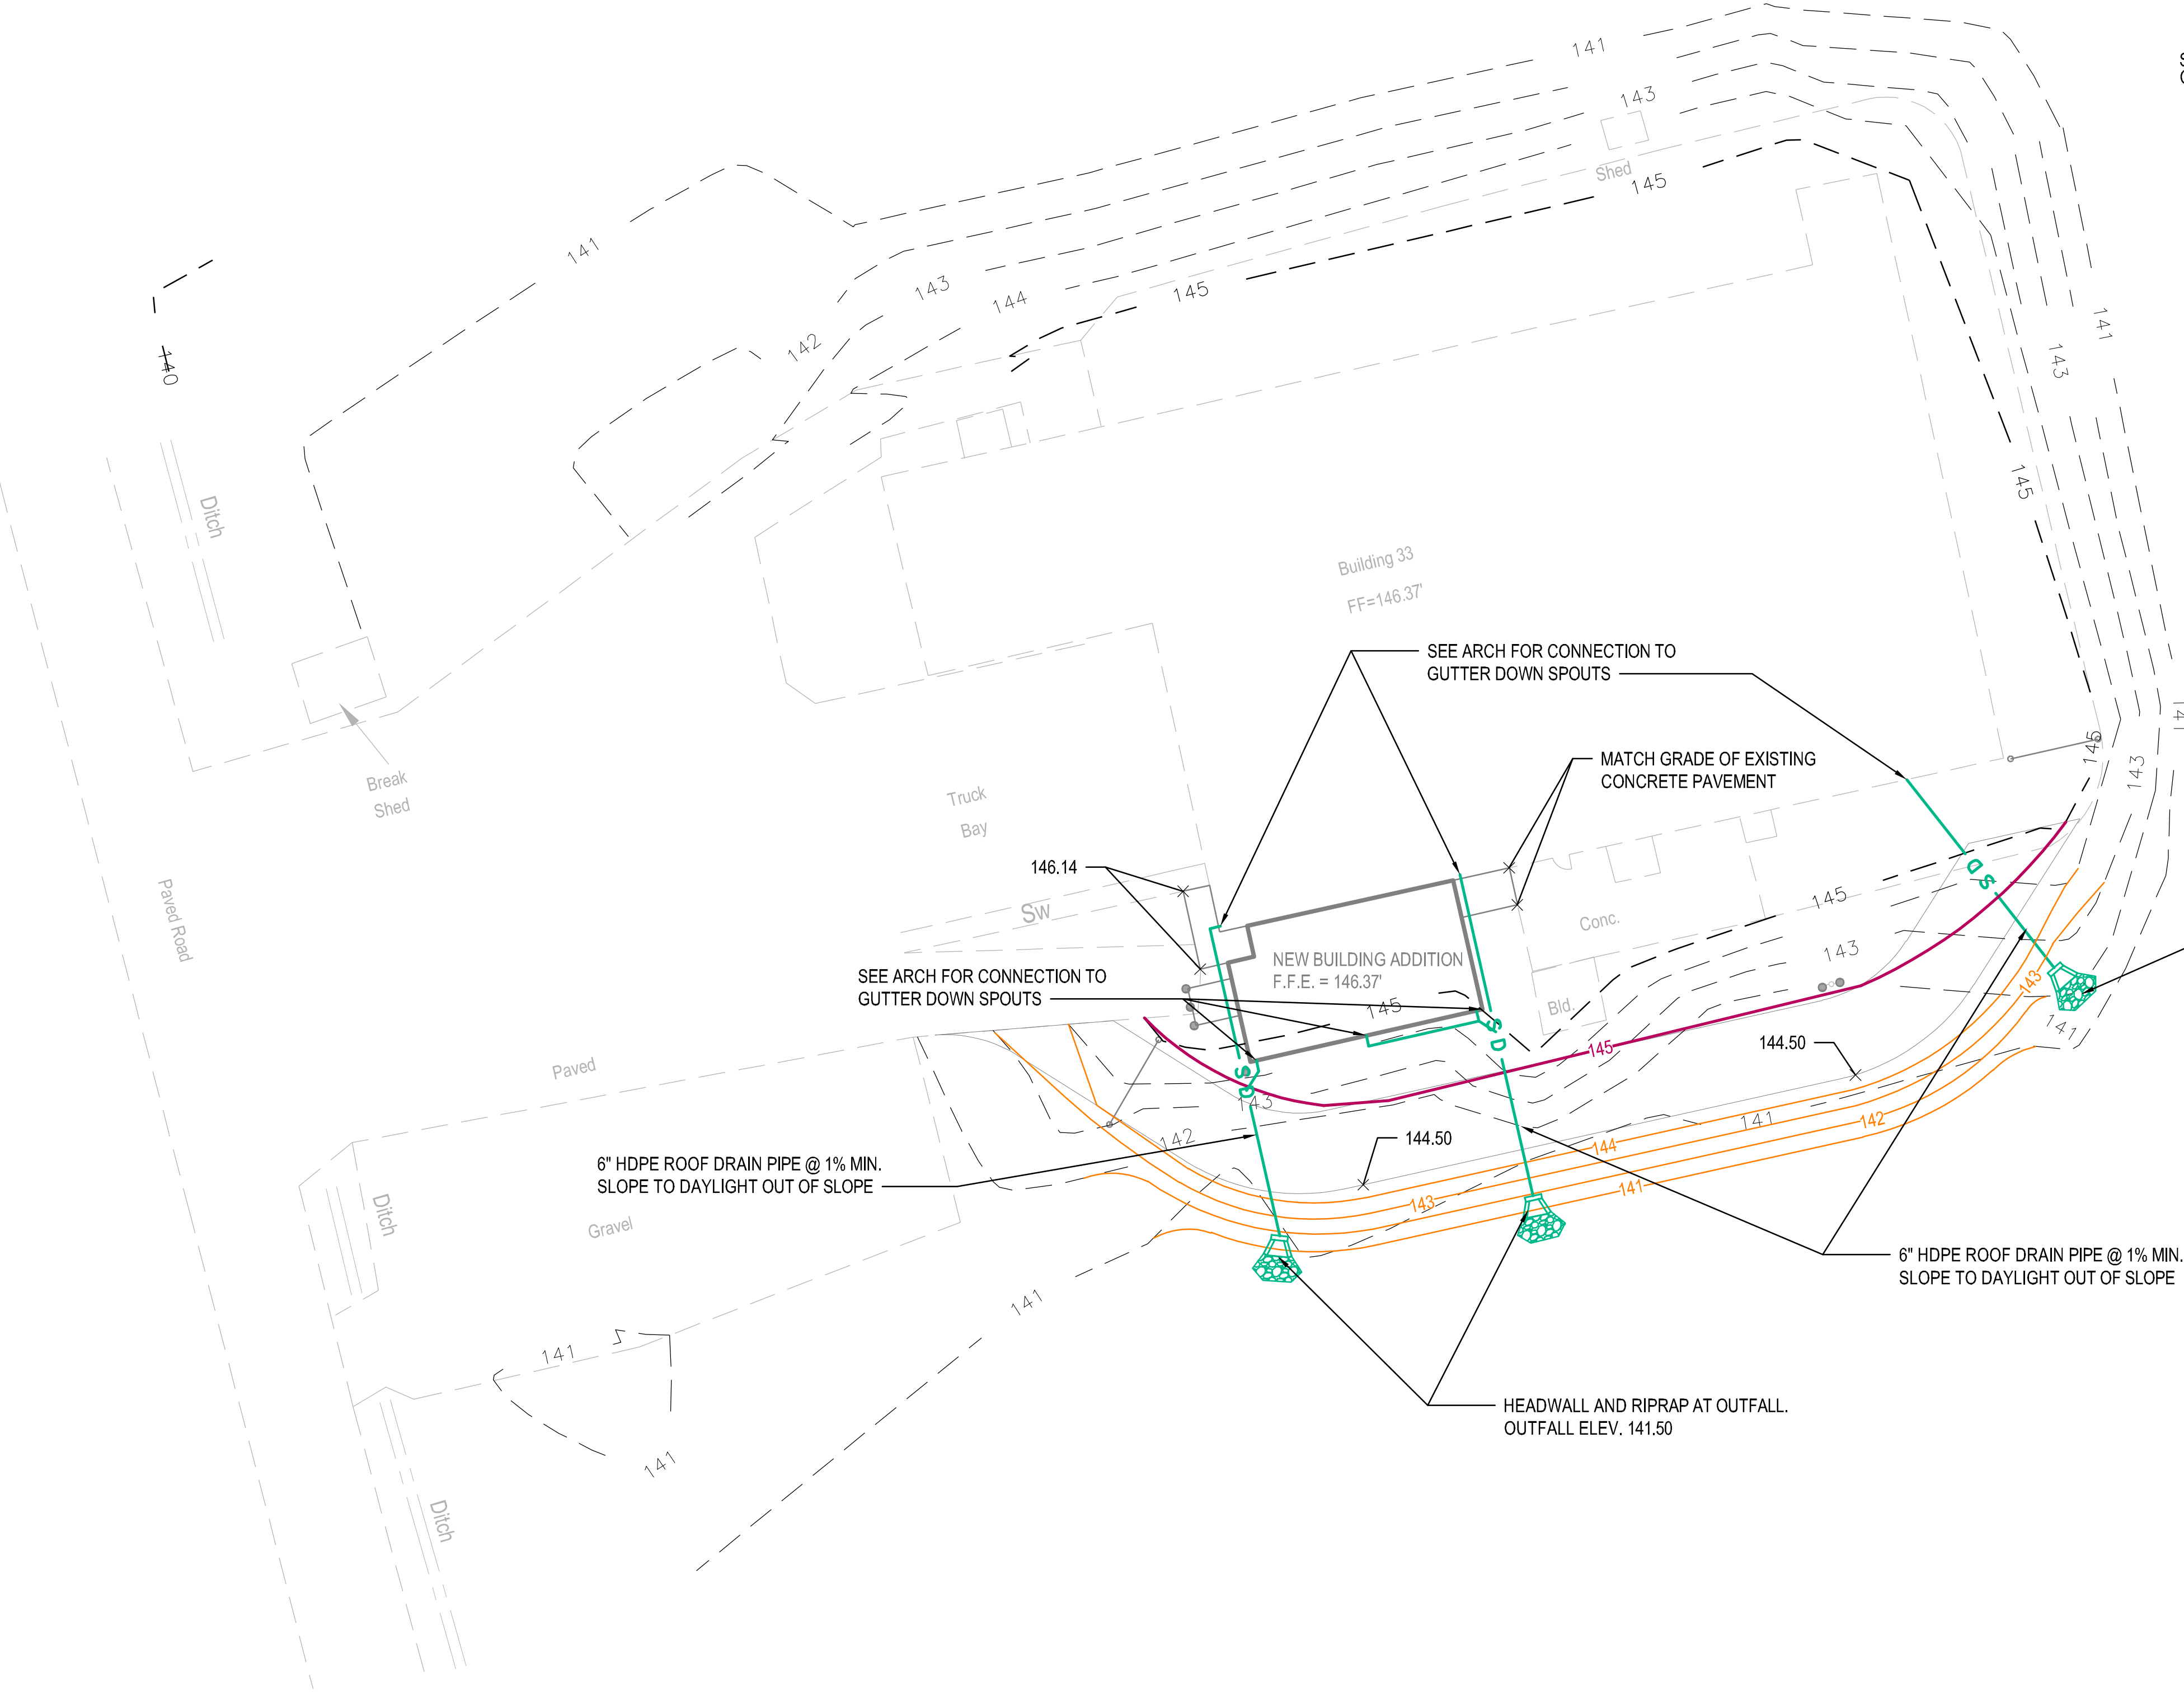

2 HEADWALL DETAIL
NOT TO SCALE

1 SITE GRADING & DRAINAGE PLAN
SCALE: 1"=20'



1300 East 6th Street Little Rock, AR 72202
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Project

AEROJET BUILDING E33
OFFICE EXPANSION
EAST CAMDEN,
ARKANSAS

Design Phase

CONSTRUCTION
DOCUMENTS

Revisions

No.	Date	Description

Stamp

CERTIFICATE OF AUTHORIZATION
CROMWELL ARCHITECTS/ENGINEERS
#6
ARKANSAS-ENGINEER

STATE OF ARKANSAS
REGISTERED PROFESSIONAL ENGINEER
JOHN T. PETERSON
No. 10649
12-19-2024

Notes

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Sheet Title SITE GRADING & DRAINAGE PLAN

Sheet Number

CG101