



C ARCHITECTURAL EXTERIOR WEST ELEVATION
SCALE: 3/16" = 1'-0"

GENERAL NOTES

1. EXHAUST FAN DAMPERS AND LOUVERS SHOWN FOR REPRESENTATION ONLY. COORDINATE SIZE, QUANTITY, AND FINAL LOCATIONS WITH EACH DISCIPLINE AND SITE CONDITIONS.
2. THROUGH WALL PENETRATIONS APPROXIMATE, COORDINATE SIZE, QUANTITY, AND FINAL LOCATIONS WITH EACH DISCIPLINE AND SITE CONDITIONS.
3. DIMENSIONS TO LOUVERS AND FAN/DAMPERS FROM OUTSIDE FACE OF METAL PANELS.
4. RAINHOOD FINISH TO MATCH SIDING COLOR, REF MECHANICAL FOR SIZE/TYPE AND ATTACHMENT PER DETAIL SHEETS.
5. EXTERIOR SIDING, ROOF, TRIM, COPING, FLASHING, GUTTER, DOWNSPOUT, DOOR/FRAME, LOUVER, WEATHER HOOD FINISH COLORS TO BE COORDINATED AND APPROVED BY OWNER.

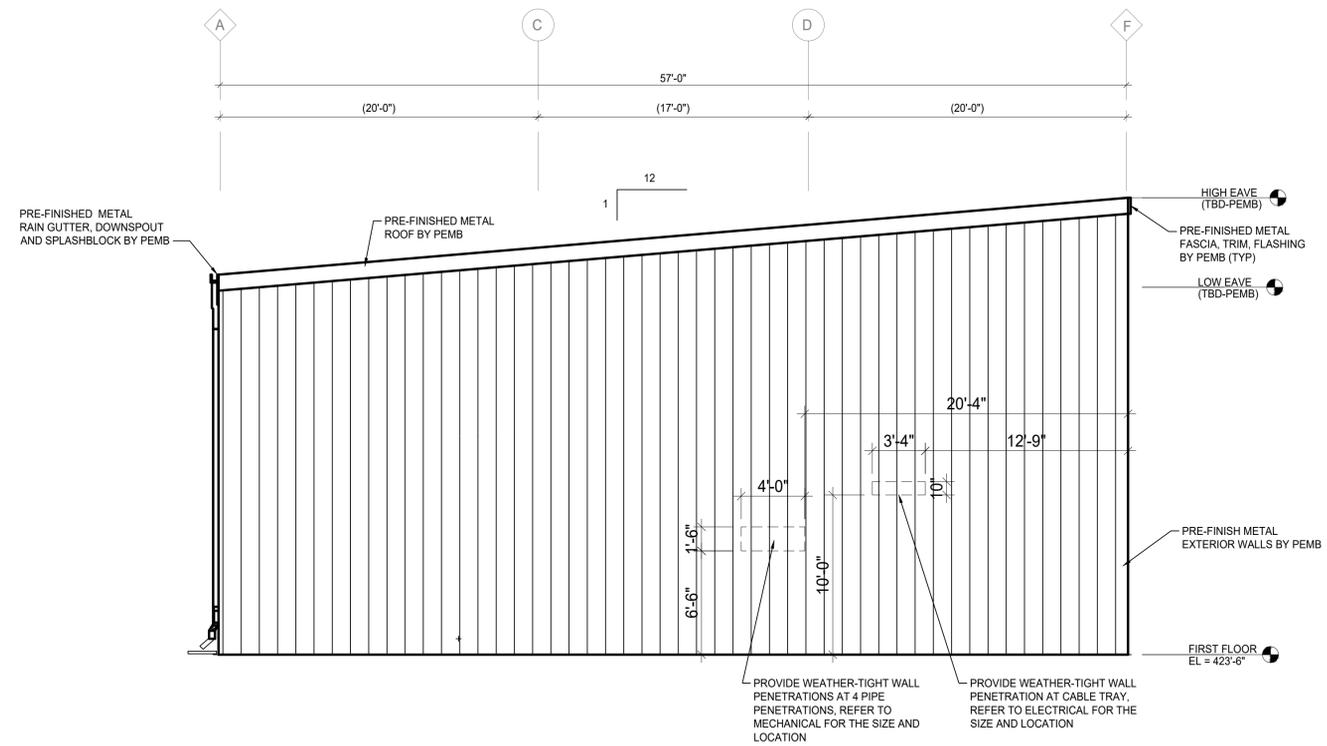

D ARCHITECTURAL EXTERIOR NORTH ELEVATION
SCALE: 3/16" = 1'-0"

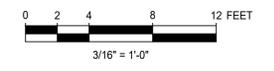

REVISIONS		
NO.	DATE	DESCRIPTION
D	07/23/25	ISSUED FOR REVIEW
C	06/16/25	ISSUED FOR REVIEW
B	05/28/25	ISSUED FOR REVIEW
A	03/05/25	ISSUED FOR REVIEW

**PRELIMINARY,
NOT FOR
CONSTRUCTION,
RECORDING PURPOSES,
OR IMPLEMENTATION**

SAM BORMAN, LIC # 10136

POWER ENGINEERS
Power Engineers Inc. - Arkansas State
Certificate of Registration # 645
PROJECT LOCATION:
6006 LOCK AND DAM ROAD
OZARK, FRANKLIN CO., ARKANSAS

**ARKANSAS ELECTRIC
COOPERATIVE CORPORATION**

FITZHUGH GENERATING STATION
ARCHITECTURAL
EXTERIOR BUILDING ELEVATIONS

NOT FOR CONSTRUCTION		POWER ENGINEERS INC.	DWG. NO.: 34001-A2-0-2
DRAWN BY: D. SILVERTHORNE	APPD: S. BUFFINGTON	REV. NO.: D	SH. NO.: 1
CHECKED: J. LUDEWIG	DATE: 03/05/25	SCALE: 3/16" = 1'-0"	CTN. ON SH.: 1