



GENERAL NOTES


1. EXHAUST FAN DAMPERS AND LOUVERS SHOWN FOR REPRESENTATION ONLY. COORDINATE SIZE, QUANTITY, AND FINAL LOCATIONS WITH EACH DISCIPLINE AND SITE CONDITIONS.
2. THROUGH WALL PENETRATIONS APPROXIMATE, COORDINATE SIZE, QUANTITY, AND FINAL LOCATIONS WITH EACH DISCIPLINE AND SITE CONDITIONS.
3. DIMENSIONS TO LOUVERS AND FAN/DAMPERS FROM OUTSIDE FACE OF METAL PANELS.
4. RAINHOOD FINISH TO MATCH SIDING COLOR, REF MECHANICAL FOR SIZE/TYP AND ATTACHMENT PER DETAIL SHEETS.
5. EXTERIOR SIDING, ROOF, TRIM, COPING, FLASHING, GUTTER, DOWNSPOUT, DOOR/FRAME, LOUVRE, WEATHER HOOD FINISH COLORS TO BE COORDINATED AND APPROVED BY OWNER.

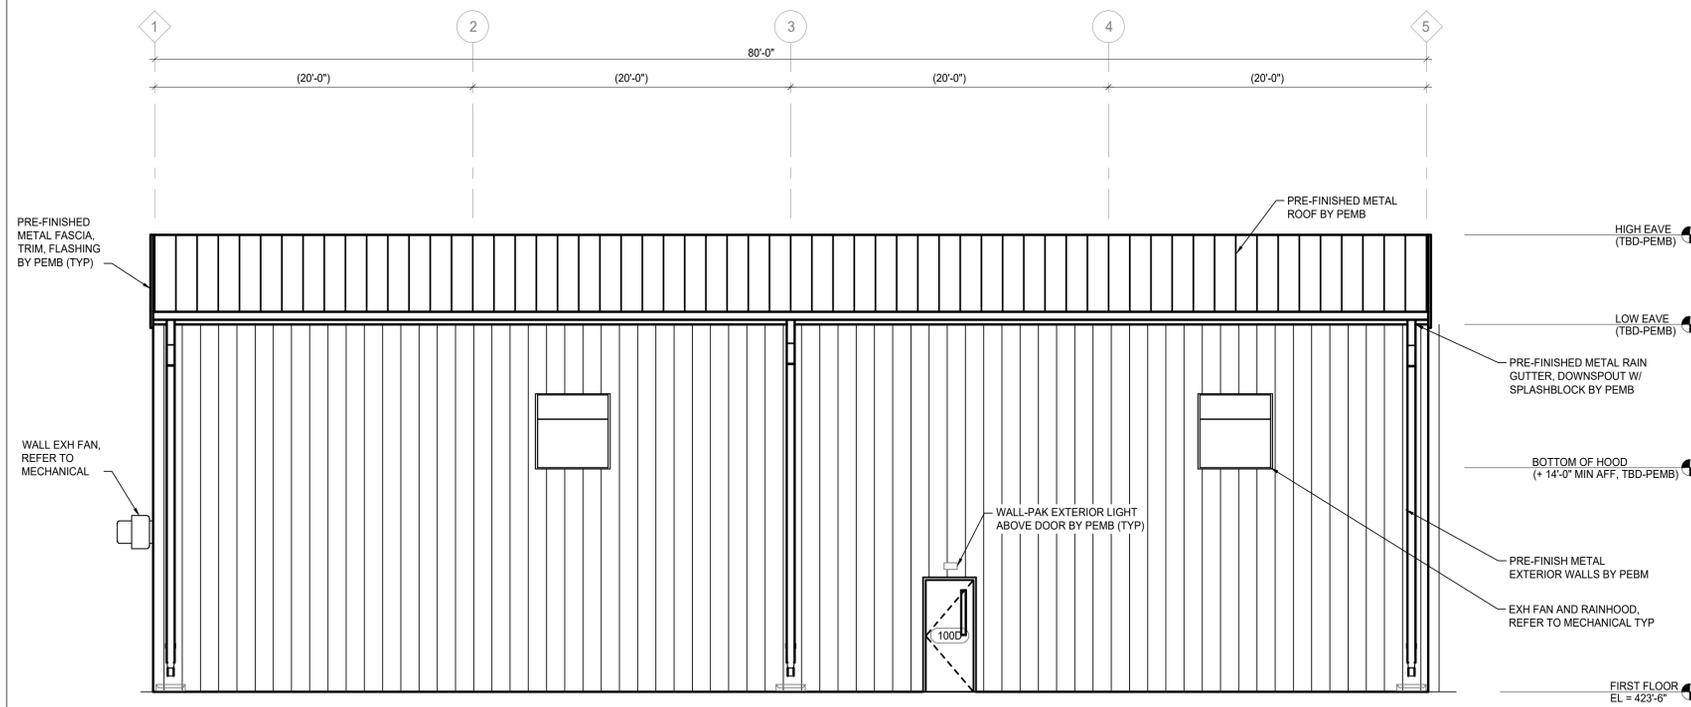

A ARCHITECTURAL EXTERIOR EAST ELEVATION
SCALE: 3/16" = 1'-0"

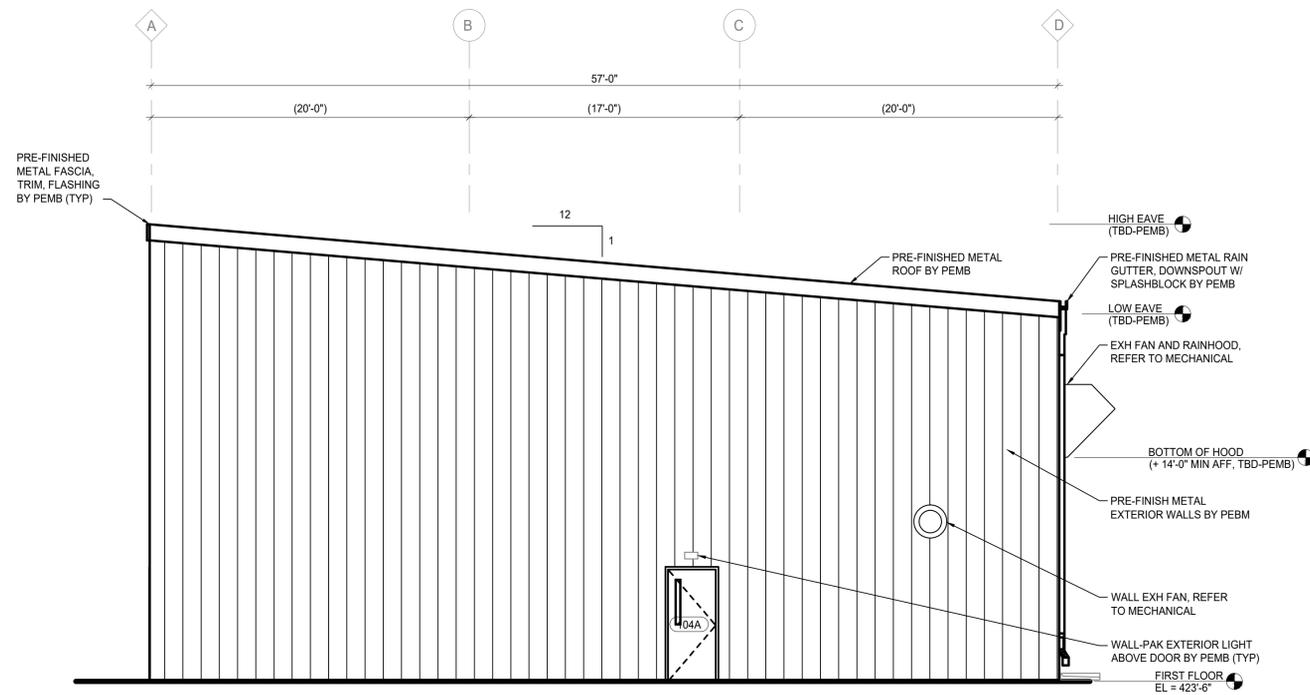

B ARCHITECTURAL EXTERIOR SOUTH ELEVATION
SCALE: 3/16" = 1'-0"

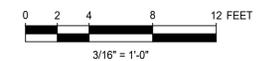

| REVISIONS | | |
|-----------|----------|-------------------|
| NO. | DATE | DESCRIPTION |
| D | 07/23/25 | ISSUED FOR REVIEW |
| C | 06/16/25 | ISSUED FOR REVIEW |
| B | 05/28/25 | ISSUED FOR REVIEW |
| A | 03/05/25 | ISSUED FOR REVIEW |

**PRELIMINARY,
NOT FOR
CONSTRUCTION,
RECORDING PURPOSES,
OR IMPLEMENTATION**

SAM BORMAN, LIC # 10136

POWER ENGINEERS INC. - Arkansas State
Certificate of Registration # 645

PROJECT LOCATION:
6006 LOCK AND DAM ROAD
OZARK, FRANKLIN CO., ARKANSAS

NOT FOR CONSTRUCTION

DRAWN BY: D. SILVERTHORNE APPD: S. BUFFINGTON
CHECKED: J. LUDEWIG DATE: 03/05/25

POWER ENGINEERS

ARKANSAS ELECTRIC COOPERATIVE CORPORATION

FITZHUGH GENERATING STATION
ARCHITECTURAL
EXTERIOR BUILDING ELEVATIONS

POWER ENGINEERS INC. DWG. NO.34001-A2-0-1
REV. NO.: D SH. NO.: 1
SCALE: 3/16" = 1'-0" CTN. ON SH.: 1