

Quality People. Building Solutions.

Comfort Systems USA (Arkansas), Inc. P.O. Box 16620 Little Rock, AR 72231 Phone 501-834-3320 Fax 501-834-5416

Date: 5/17/2024

Return Request: 5/27/2024

Project: CALS Main Library Renovations

Supplier: Powers of Arkansas **Manufacturer:** Loren Cook

Submittal: HVAC Power Ventilators (KEF-1)

Submittal Number: 23 34 23-02

Drawing # and Installation: Mechanical Drawings

ARCHITECT

Polk Stanley Wilcox 801 South Spring St. Little Rock, AR 72201 501-378-0878

GENERAL CONTRACTOR

CDI 3000 Cantrell Rd. Little Rock, AR 72202 501-5666-4300

ENGINEER

Bernhard 1 Allied Drive, Bldg. 2, Suite 2600 Little Rock, AR 72202 501-666-6776

MECHANICAL SUBCONTRACTOR

Comfort Systems USA (Arkansas), Inc. 9924 Landers Rd. N. Little Rock, AR 72117 501-834-3320

Notes:			

CSUSA PROJECT NO. 23-8016

dpierce@comfortar.com







MARK: KEF-1

PROJECT: CALS MAIN LIBRARY RENOVATION

DATE: 5/6/2024


SQN-D VF


Centrifugal Square Inline Direct Drive Preprogrammed EC


Electronically Commutated Vari-Flow® Motor

STANDARD CONSTRUCTION FEATURES:

All aluminum wheel - Galvanized 18 gauge steel housing - Three removable access doors - Closed cell neoprene gasketing - Inlet and discharge duct collars - Universal mounting feet - Preprogrammed EC electronically commutated Vari-Flow® motor/drive package - Transit tested packaging.

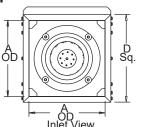

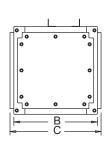

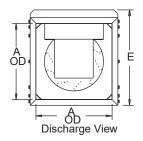

Performance

Qty	Catalog Number	Flow SP (inwc)			Power (HP)		FEI	Speed Control
1	120SQN28D (VF)	1400	1.00	1872	.499	n/a(<1HP)	1.17	EC

Altitude (ft): 266 Temperature (F): 70

Motor Information

HP	RPM*	Volts/Ph/Hz	Enclosure	RLA	
3/4	2800	115/1/60	OPEN -EC	8.5	



*Motor programmed to max speed of 2110 RPM.

RLA based on motor manufacturer's data at programmed HP and max RPM. Motor is electronically/thermally protected.

Sound Data Sound Power by Octave Band

	1	2	3	4	5	6	7	8	LwA	dBA	Sones
Inlet	69	77	79	76	68	63	61	54	76	65	12.8
Outlet	80	83	80	72	69	68	63	55	77	65	14.4

- Distance from Sound source 5 ft

Accessories:


EXTERNAL SIGNAL SPEED CONTROL CTL & XFMR BY OTHERS DISCONNECT NEMA 1 PRE-WIRED BDM-16 MTR DPR 115V FLANGED INLET FLANGED OUTLET RC-75 SET(4) - ISOLATORS

Dimensions (inches)

	milenere (mence)								
Α	16								
В	20								
С	22								
D Sq	18-7/16								
E	20								
Housing Gauge	18								

NOTE: Accessories may affect dimensions shown.

***Includes fan, motor & accessories.

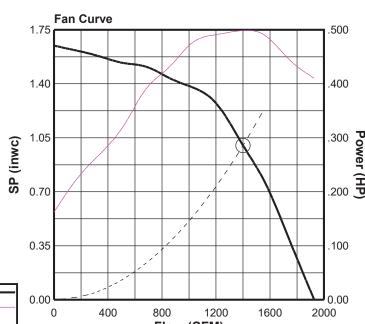

CFM vs SP
CFM vs HP
Point of Operation



PROJECT: CALS MAIN LIBRARY RENOVATION

DATE: 5/6/2024


Speed Control

External Speed Control Electronically Commutated (EC) Motor Type N

STANDARD CONSTRUCTION FEATURES:

Vari-Flow EC Motors are available in 1/8 to 1 HP for 120V or 208-230V -Single phase applications have a adjustable speed range of 500 to 1725 or 500 to 2800 - Some motors come with a factory programmed maximum RPM for specific applications - External signal speed control requires a 0-10 VDC control signal to adjust speed of the motor - The motor will operate from 2-10 VDC and turns off when the control signal is below 1.9 VDC - Dial on speed control must be set to 0 for proper external speed control operation.

	_	Description
KEF-1	1	OPEN -3/4HP - 115V/1 PH/ 60 2800/0000 -EC

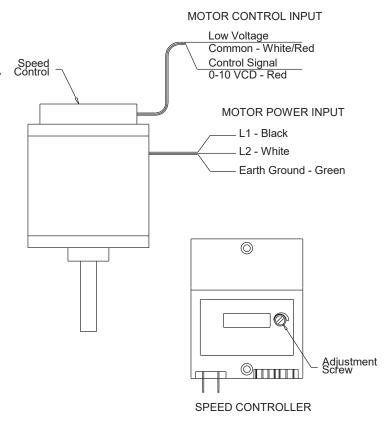



PROJECT: CALS MAIN LIBRARY RENOVATION

DATE: 5/6/2024


BDM

Motorized Backdraft Damper STANDARD CONSTRUCTION FEATURES:

.020 aluminum blades - .060 aluminum frame - Aluminum hinge pins - Brass bushings -Non-overloading motor.

Notes:

Max operating temperature 130 Deg F (50 Deg C)

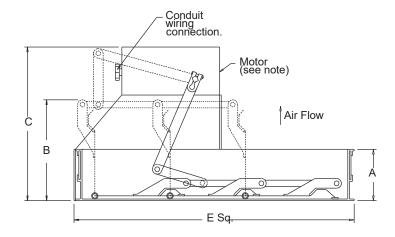

	_	Description	Α	В Мах	С	E Sq.	# Motors
KEF-1	1	BDM-16 MTR DPR 115V	1-7/8	5-3/16	8	15-3/4	1




Companion Flange

Inlet/Discharge

PROJECT: CALS MAIN LIBRARY RENOVATION

DATE: 5/6/2024

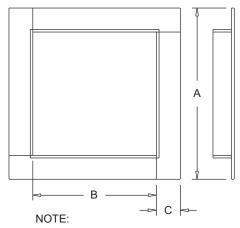

Mat'l: C" X C" X 1/8 6063-T5 aluminum or 1020 steel.

Mark	Qty	Description	Α	В	С
KEF-1	1	FLANGED INLET	19-1/4	16-1/4	1-1/2




Companion Flange

Inlet/Discharge

PROJECT: CALS MAIN LIBRARY RENOVATION

DATE: 5/6/2024

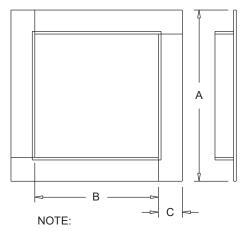

Mat'l: C" X C" X 1/8 6063-T5 aluminum or 1020 steel.

Mark	Qty	Description	Α	В	С
KEF-1	1	FLANGED OUTLET	19-1/4	16-1/4	1-1/2



RIS CEILING


Rubber-In-Shear Isolator Ceiling Mounted

NOTE:

Dimensions are for informational purposes only - Not for construction.

PROJECT: CALS MAIN LIBRARY RENOVATION

DATE: 5/6/2024

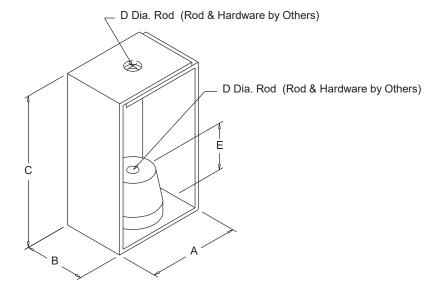

Mark	Qty	Description	Α	В	С	D	E	
KEF-1	1	RC-75 SET(4)	2.15	1.50	2.72	0.38	0.45	



SUBMITTAL

PRODUCT Kitchen Hood Package

MANUFACTURER Stratovent

JOB NAME CALS Main Library Renovation

LOCATION Little Rock, AR

ENGINEER Bernhard TME

CONTRACTOR Comfort Systems

DATE 5/14/2024

SUBMITTED BY Courtney Michael

5440 Northshore Drive - North Little Rock, Arkansas 72118 - Tel: 501.374.5420 Fax: 501.370.9298

FOR QUESTIONS, CALL THE Stratovent REGION 24

PHONE: (919) 573 - 4250 EMAIL: jeff.johnson@stratovent.com

HOOD INFORMATION - JOB#6779909

11001	1111	UNMATION	- JOD#01									EVIIAI	ICT DI	CNIIIM			
HOOD TAG	TAG	MODEL	EL MANUFACTURER	LENGTH	MAX COOKING TEMP	TYPE	APPLIANCE DUTY	APPLIANCE DESIGN CFM/FT	ESIGN TOTAL FM/FT EXH CFM	EXHAUST PLENUM RISER(S)							НООТ
	'"			LLINGIII						WIDTH	LENG	HEIGHT	DIA	CFM	VEL	SP	CONSTRUCTION
1		4824 SV-ND-2	STRATOVENT	4′ 0″	450 DEG	I	MEDIUM	162	650			4"	12"	650	828	-0.280*	430 SS WHERE EXPOSED

STRATOVENT HOODS ARE BUILT IN COMPLIANCE WITH



NFPA #96 NSF STANDARD #2 UL STANDARD 710 ETL FILE ND. 3054804-001 UL710 RATINGS: MODEL SV-ND2

450F APPLIANCES
6' MIN OVERHANGS (OPEN ENDS)
48' MAX ABOVE APPLIANCES

MINIMUM AIRFLOW: 150 CFM PER LINEAR FT WITH OPEN ENDS

4	<u>HOOL</u>) INF	<u>ORMATION</u>									
ı					FILTER	(2			LIGHT(S)		FIRE	ноор
	NO HOOD	TAG	TYPE	QTY	HEIGHT	LENGTH	EFFICIENCY @ 7 MICRONS	QTY	TYPE			HANGING
	1		CAPTRATE SOLO FILTER	2	16*	20*	85% SEE FILTER SPEC	2	L55 SERIES E26 100W MAX A19 BULBS BY OTHERS	NO	YES	252 LBS

HOOD OPTIONS

11000		10110							
HOOD NO	TAG				OPTI	ON			
		FIELD	WRAPPER	18.00"	HIGH	FRONT	, LEFT,	RIGHT,	BACK.
1		FINISHED	BACK -	GROUND/F	POLISH	48.00"	LONG.		
		SENSOR-0	CV.						


WALL-MOUNT UTILITY CABINET


		OTTENTE O		UTILITY CABINET(S	>		
ноор			FIF	RE SYSTEM	ELECTRICAL	SWITCHES	
NO HOOD	LOCATION	SIZE	TYPE	SIZE	MODEL #	QUANTITY	WEIGHT
1	WALL MNT	12"×42"×24"	TANK FS	4.0	DCV-1011	1 LIGHT 1 FAN	240.00 LBS

WALL-MOUNT UTILITY CABINET ASSEMBLY INSTRUCTIONS

HANGING ANGLE MUST BE SUPPORTED WITH 1/2" - 13 TPI GRADE 5 (MINIMUM) ALL-THREAD. SANDWICH HANGING ANGLES AND CEILING ANCHOR POINTS WITH 1/2" GRADE 5 (MINIMUM) STEEL FLAT WASHERS AND 1/2" - 13 TPI GRADE 5 (MINIMUM) HEX NUTS AS SHOWN. MUST USE DUBLED HEX NUT CONFIGURATION BENEATH UTILITY CABINET HANGING ANGLES AND ABOVE CEILING ANCHORS. MAINTAIN 1/4" OF EXPOSED THREADS BENEATH BOTTOM HEX NUT. TORQUE ALL HEX NUTS TO 57 FT-LBS.

CABINET TO BE HUNG BY HOOD INSTALLER. SEE UTILITY CABINET SCHEDULE FOR CABINET SIZE.

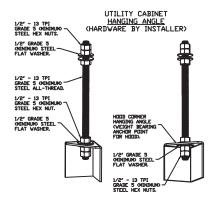

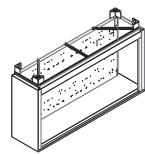



JOB HOOD-CALS LIBRARY-LITTLE ROCK,AR

AR, 72201

JOB # 6779909 *DRAWN BY* REG24-JJ


SCALE 3/8" = 1'-0"

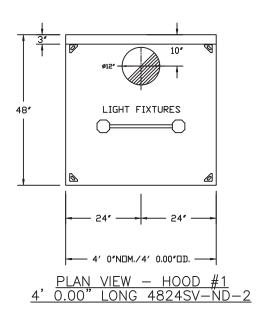

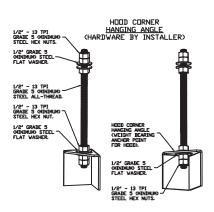

ASSEMBLY INSTRUCTIONS

HANGING ANGLE MUST BE SUPPORTED WITH 1/2" - 13 TPI GRADE 5 (MINIMUM) ALL-THREAD. SANDWICH HANGING ANGLES AND CEILING ANCHOR POINTS WITH 1/2" GRADE 5 (MINIMUM) STEEL FLAT WASHERS AND 1/2" - 13 TPI GRADE 5 (MINIMUM) HEX NUTS AS SHOWN. MUST USE DIUBLED HEX NUT CONFIGURATION BENEATH HOOD HANGING ANGLES AND ABOVE CEILING ANCHORS. MAINTAIN 1/4" OF EXPOSED THREADS BENEATH BOTTOM HEX NUT. TORQUE ALL HEX NUTS TO 57 FT-LBS.

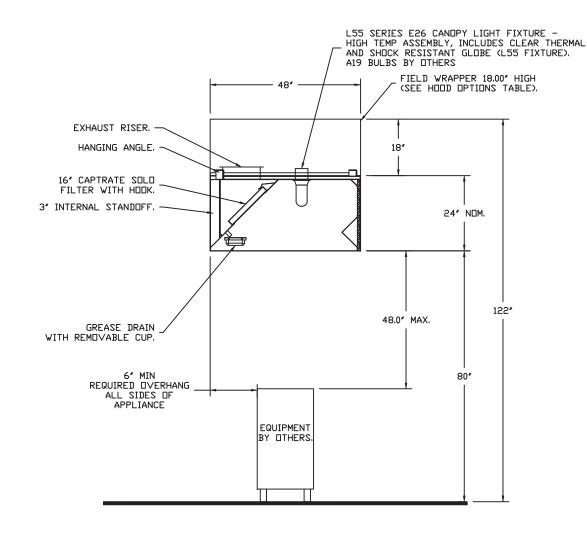

 $\frac{SECTION\ VIEW\ -\ MODEL\ 4824SV-ND-2}{HOOD\ -\ \#1}$

JOBHOOD-CALS LIBRARY-LITTLE ROCK,AR

AR, 72201 JOB # 6779909 DRAWN BY REG24-JJ

SCALE 3/8" = 1'-0"

Page 41 of 68

EXHA	AUST .	FAN	INFORMATION - JOB#67	79909												
FAN UNIT NO	TAG	QTY	FAN UNIT MODEL #	MANUFACTURER	CFM	ESP	RPM	MOTOR ENCL	HP	BHP	PHASE	VOLT	FLA	DISCHARGE VELOCITY	WEIGHT (LBS)	SONES
1	KHEF-3	1	SV-DU50HFA	STRATOVENT	650	1.220	1522	TEAD-ECM	0.500	0.3610	1	115	6.3	247 FPM	78	16
2	KEF-5	1	SV-DU50HFA	STRATUVENT	650	1.220	1597	TEAD-ECM	0.500	0.4170	1	115	6.3	247 FPM	76	17.8

AIR FLOW

(ROOF OPENING).

BACKDRAFT DAMPER.


PLEASE NOTE THAT EF-5 ON THE FAN SCHEDULE IS INCLUDED IN THE HOOD PACKAGE SUBMITTAL HOOD MANUFACTURER MIS-LABELED EF-5 W/

FAN	OPTION	S	
FAN UNIT NO	TAG	QTY	DESCRIPTION
		1	GREASE BOX
1	KHEF-3	1	ECM WIRING PACKAGE - PWM SIGNAL FROM ECPMO3 PREWIRE (TELCO MOTOR), CCW ROTATION
		1	2 YEAR PARTS WARRANTY
		1	ECM WIRING PACKAGE - MANUAL OR 0-10VDC REFERENCE SPEED CONTROL -RTC- (TELCO MOTOR), CCW ROTATION
2	KEF-5	1	SCR-13 BIRD SCREEN
		1	I 15-BDD DAMPER
		1	2 YEAR PARTS WARRANTY

CURB ASSEMBLIES

	ND	ON FAN	TAG	WEIGHT	ITEM	SIZE
	1	# 1	KHEF-3	38 LBS	CURB	19.500'W X 19.500'L X 26.000'H VENTED HINGED.
ı	2	# 2	KEF-5	34 LBS	CURB	19.500°W X 19.500°L X 26.000°H.

FAN #2 SV-DU50HFA - EXHAUST FAN (KEF-5)

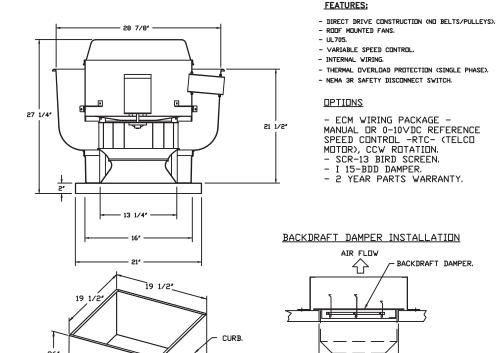


20 GAUGE

- 3" FLANGE.

STEEL CONSTRUCTION.

FAN #1 SV-DU50HFA - EXHAUST FAN (KHEF-3)

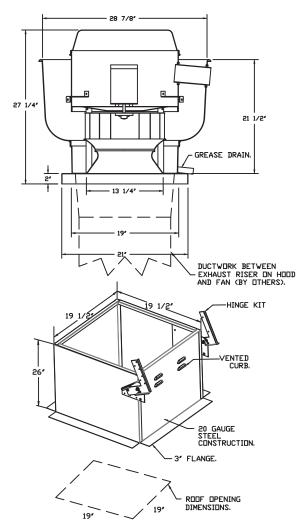

FEATURES:

- DIRECT DRIVE CONSTRUCTION (NO BELTS/PULLEYS).
- ROOF MOUNTED FANS.
- RESTAURANT MODEL.
- UL705 AND UL762 AND ULC-S645
- VARIABLE SPEED CONTROL.
- INTERNAL WIRING.
- THERMAL OVERLOAD PROTECTION (SINGLE PHASE).
- HIGH HEAT OPERATION 300°F (149°C).
- GREASE CLASSIFICATION TESTING.
- NEMA 3R SAFETY DISCONNECT SWITCH.

<u>OPTIONS</u>

- GREASE BOX.
- ECM WIRING PACKAGE PWM SIGNAL FROM ECPMO3 PREWIRE (TELCO MOTOR), CCW ROTATION.
- 2 YEAR PARTS WARRANTY.

JOB HOOD-CALS LIBRARY-LITTLE ROCK,AR

AR, 72201 JOB # 6779909


DRAWN BY REG24-JJ SCALE 3/8" = 1'-0"

Page 42 of 68


FIRE SYSTEM INFORMATION - JOB#6779909

FIRE			"	MAY ED	DESIGN	INSTALLATION		
SYSTEM NO	TAG	TYPE	SIZE	MAX FP	FP	SYSTEM	LOCATION ON HOOD	
1		TANK FS	4.0	20	18	WALL UTILITY CABINET LEFT	N/A	

	YSTE	M PARTS LIST KEY		
FIRE SYSTEM NO	TAG	KEY NUMBER - PART DESCRIPTION	QTY BY FACTURY	QTY BY DIST
		0 - 0 - TANK FIRE SUPPRESSION MAINTENANCE GUIDE UTILITY CABINET LABEL SHEET.	1	0
		0 - 0 - TANK FIRE SUPPRESSION POST-DISCHARGE PROCEDURE UTILITY CABINET LABEL SHEET.	1	0
		0 - 0 - 12-F28021-32144-DT-360 DUCT FIRE THERMOSTAT WITH 12 FOOT WIRE LEADS. NO, CLOSE ON TEMP RISE AT 360°F.	1	0
		0 - 0 - 32-00002 QUIK SEAL - 1/2" (UL).	1	0
		0 - 0 - 361091 3/8' BRASS PLUG.	3	0
		0 - 0 - 4429K153 1/2" MALE NPT TO 1/2" FEMALE NPT ELBOW, BRASS.	1	0
		0 - 0 - 4429K422 1/2" X 1/4" BRASS REDUCING BUSHING.	1	0
		0 - 0 - 79425 3/8" NPT FEMALE TO 1/2" MALE PROPRESS ADAPTER.	3	0
		0 - 0 - 79525 1/2' 90 PRO-PRESS ELBOW WITH 1/2" NPT FEMALE CONNECTION, VIEGA.	1	0
		0 - 0 - 79580 1/2" X 1/2" PRO-PRESS TEE X 1/2" NPT FEMALE CONNECTION, VIEGA.	1	0
		0 - 0 - 87-300001-001 TANK - PRESSURIZED TANK USED FOR TANK FIRE SUPPRESSION.	1	0
		0 - 0 - 87-300030-001 PRIMARY ACTUATOR KIT (PAK) - ACTUATOR AND RELEASE SOLENDID ASSEMBLY, ONE NEEDED PER FIRE SYSTEM, SUPERVISED, TANK FIRE SUPPRESSION.	1	0
		0 - 0 - 87-300152-001 HARDWARE, SVA BOLTS, TANK FIRE SUPPRESSION.	4	0
		0 - 0 - 9055455PC PRO PRESS 1/2 PRESS X PRESS 90 ELBOW LD.	3	0
		0 - 0 - 9097200PC PRO PRESS PC611 1/2 PRESS TEE LD.	4	0
		0 - 0 - 98694A115 HARDWARE, DATANKLOCK LOCKING BRACKET SQUARE NUTS 5/16' ZINC, TANK FIRE SUPPRESSION.	2	0
		0 - 0 - A0034332 JUNCTION BOX FOR MANUAL PULL STATION. 1.5' DEEP BACK BOX, RED COLOR.	1	0
1		0 - 0 - A31484 1/4' NPT SCHRADER VALVE AND CAP, JB INDUSTRIES 1/4' FLARE X 1/4' MPT HALF UNION USED ON TANK SERVICE PORT.	1	0
		0 - 0 - BI145 3/8" BLACK IRDN 90 ELL.	2	0
		0 - 0 - DATANKLOCK DISCHARGE ADAPTER TANK LOCKING PLATE FOR FIRE SYSTEM TANK INSTALLATION IN UTILITY CABINETS, TANK FIRE SUPPRESSION.	1	0
		0 - 0 - SLPCDN-30FT SUPERVISED LOOP CONNECTION KIT. CONTAINS THE PARTS NEEDED TO CONNECT THE SUPERVISED LOOP BETWEEN HOODS WITH UPTO 29' GAP. KIT CONTAINS 32 FEET OF BLACK MG WIRE, 32 FEET OF TAN MG WIRE, 30 FEET OF FLEXIBLE CONDUIT, AND TWO 7/8' CONNECTORS.	1	0
		0 - 0 - SLPCDN-40FT SUPERVISED LOOP CONNECTION KIT. CONTAINS THE PARTS NEEDED TO CONNECT THE SUPERVISED LOOP BETWEEN HOODS WITH UPTO 39' GAP. KIT CONTAINS 42 FEET OF BLACK MG WIRE, 42 FEET OF TAN MG WIRE, 40 FEET OF FLEXIBLE CONDUIT, AND TWO 7/8' CONNECTORS.	1	0
		0 - 0 - TANK STRAP TANK STRAP - USED FOR TANK FIRE SUPPRESSION.	3	0
		0 - 0 - TFS-UCTANKBRACKET TANK BRACKET FOR FIRE SYSTEM TANK INSTALLATION IN UTILITY CABINETS, TANK FIRE SUPPRESSION.	1	0
		0 - 0 - WK-283952-000 DISCHARGE ADAPTER, TANK FIRE SUPPRESSION.	1	0
		16 - 16 - 79210 1/2" X 3/8" NPT MALE ADAPTER, VIEGA.	4	0
		16 - 16 - DL-F NOZZLE - TANK PROTECTION APPLIANCE COVERAGE NOZZLE (INCLUDES METAL BLOW OFF CAP, LANYARD, USED WITH CHROME-PLATED PIPE).	4	0
		26 - 26 - QSA-3/8 QUIK SEAL - 3/8' (UL).	4	0
		34 - 34 - A0034331 24VDC SINGLE ACTION MANUAL ACTUATION DEVICE (PUSH/PULL STATION) WITH PROTECTIVE COVER, DNE (1) NORMALLY OPEN CONTACT. RED COLOR.	1	0

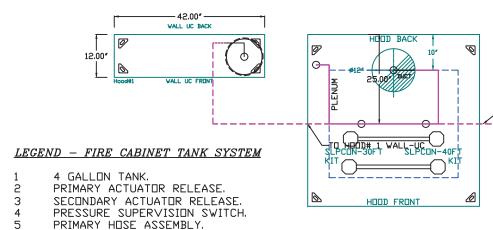

HDDD # 1 JDB # 6779909 FS # 1 MODEL: ND-2 SIZE: 48"x24" LENGTH:

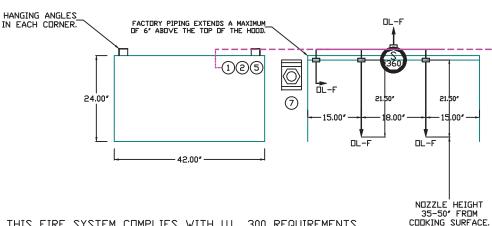

- THIS FIRE SYSTEM COMPLIES WITH U.L. 300 REQUIREMENTS. JDB #: 6779909.

JOB NAME: HOOD-CALS LIBRARY-LITTLE ROCK, AR.

SECONDARY HOSE ASSEMBLY.

REMOTE MANUAL ACTUATION DEVICE.

SYSTEM SIZE: TANK-SP-1-WC DESIGN FP: 18. MAXIMUM FP: 20.

HODD # 1 4' 0.00" LONG \times 48" WIDE \times 24" HIGH.

RISER # 1 SIZE: 12" DIA.

6

HOOD # 1 METAL BLOW-OFF CAPS INCLUDED.

(plumbing, mechanical, etc).

ALTERNATE FIELD-CONNECTION POINT

Price is for surface mounted conduit for low voltage wiring to pull station (conduit recessed into the wall is extra) Any appliance layout changes that occur after hood production could result in added cost and job site delays. Price includes two trips to job site. One trip is for installation, second trip is for test. Additional charges will apply for additional trips needed because of failed tests. Full system dump test are not included, air puff test only. Enunciating alarms, strobes, or special alarm systems are not included and must be contracted directly by installing contractor with fire suppression contractor if required. Fire extinguishers are not included.

If a wall-mounted s/s utility cabinet is included in the hood quote, this cabinet must be hung be the mechanical contractor prior to the fire suppression contractor showing up to the job site. Cabinet to be supported from above with all-thread.

The quoted hood fire suppression system is $N\Box T$, Ansul R102, it is TANK-brand Fire Suppression System, TANK-brand system is certified to UL300/NFPA17A

Price includes Installation by a certified Fire Suppression Subcontractor sourced and hired by hood vendor, non union / non prevailing wage labor ONLY, (REQUEST RE-BID IF SPECIAL WAGES ARE REQUIRED) Includes chrome sleeving on exposed piping, Test, and standard Permits. Special permitting required by the city or others is NOT included. Special permitting is considered to be anything requiring Engineering work or sealed/stamped drawing by a licensed engineer. Price is for a system that is installed during normal daytime weekday business hours. Any weekend or night work required will be extra.

Before purchasing this option, the contractor should research local jurisdictional requirements. Multiple permits may be required by others prior to fire system connection

Pricing assumes the hood mounted fire suppression cabinet housing all tanks and release system. I low voltage pull station NO GAS SHUTDOWN VALVE INCLUDED, ASSUMES ELECTRIC APPLIANCE

JOB HOOD-CALS LIBRARY-LITTLE ROCK,AR

AR, 72201 JOB # 6779909 DRAWN BY REG24-JJ

SCALE 3/16" = 1'-0"

Page 44 of 68

(45.25")

TANK OVERLAPPING

PROTECTION - 30 HIGH PROXIMITY

36.00" L X30.00" D

MAX HAZARD AREA SHOWN

ELECTRICAL PACKAGE - JOB#6779909 SWITCHES FANS CONTROLLED ΝП PACKAGE # LOCATION OPTION TAG LOCATION QUANTITY FAN TAG TYPE ф HP VOLT FLA FACE MOUNT LEFT 1 LIGHT SIDE OF HOOD 1 DCV-1011 WALL UTILITY CABINET LEFT SMART CONTROLS DCV KHEF-3 **EXHAUST** 0.500 115 6.3 1


1 FAN

DEMAND CONTROL VENTILATION HOOD CONTROL PANEL SPECIFICATIONS:

- CONTROLS SHALL BE LISTED BY ETL (UL 508A) AND SHALL COMPLY WITH DEMAND VENTILATION SYSTEM TURNDOWN REQUIREMENTS DUTLINED IN IECC 403.7.5 (2021).

HUUD # 1

- THE CONTROL ENCLOSURE SHALL BE NEMA 1 RATED AND LISTED FOR INSTALLATION INSIDE OF THE EXHAUST HOOD UTILITY CABINET. THE CONTROL ENCLOSURE MAY BE CONSTRUCTED OF STAINLESS STEEL OR PAINTED STEEL.
- TEMPERATURE PROBE(S) LOCATED IN THE EXHAUST DUCT RISER(S) SHALL BE CONSTRUCTED OF STAINLESS STEEL.
- A DIGITAL CONTROLLER SHALL BE PROVIDED TO ACTIVATE THE HOOD EXHAUST FANS DYNAMICALLY BASED ON A FIXED DIFFERENTIAL BETWEEN THE AMBIENT AND DUCT TEMPERATURES SENSORS. THIS FUNCTION SHALL MEET THE REQUIREMENTS OF IMC 507.1.1.
- A DIGITAL CONTROLLER SHALL PROVIDE ADJUSTABLE HYSTERESIS SETTINGS TO PREVENT CYCLING OF THE FANS AFTER THE COUKING APPLIANCES HAVE BEEN TURNED OFF AND/OR THE HEAT IN THE EXHAUST SYSTEM IS REDUCED.
- A DIGITAL CONTROLLER SHALL PROVIDE AN ADJUSTABLE MINIMUM FAN RUN-TIME SETTING TO PREVENT FAN CYCLING.
- VARIABLE FREQUENCY DRIVES (VFDS) SHALL BE PROVIDED FOR FANS AS REQUIRED. THE DIGITAL
 CONTROLLER SHALL MODULATE THE VFDS BETWEEN A MINIMUM SETPOINT AND A MAXIMUM SETPOINT ON
 DEMAND. THE DUCT TEMPERATURE SENSOR INPUT(S) TO THE DIGITAL CONTROLLER SHALL BE USED TO
 CALCULATE THE SPEED REFERENCE SIGNAL.
- THE VFD SPEED RANGE OF OPERATION SHALL BE FROM 0% TO 100% FOR THE SYSTEM, WITH THE ACTUAL
 MINIMUM SPEED SET AS REQUIRED TO MEET MINIMUM VENTILATION REQUIREMENTS.
- AN INTERNAL ALGORITHM TO THE DIGITAL CONTROLLER SHALL MODULATE SUPPLY FAN VFD SPEED PROPORTIONAL TO ALL EXHAUST FANS THAT ARE LOCATED IN THE SAME FAN GROUP AS THE SUPPLY FAN.
- THE SYSTEM SHALL OPERATE IN PREP MODE DURING LIGHT COOKING LOAD OR COOL DOWN MODE WHEN SUFFICIENT HEAT REMAINS UNDERNEATH THE HOOD SYSTEM AFTER COOKING OPERATIONS HAVE COMPLETED, OPERATION DURING EITHER OF THESE PERIODS WILL DISABLE THE SUPPLY FANS AND PROVIDE AN EXHAUST FAN SPEED THAT IS EQUAL TO THE MINIMUM VENTILATION REQUIREMENT.
- A DIGITAL CONTROLLER SHALL DISABLE THE SUPPLY FAN(S), ACTIVATE THE EXHAUST FAN(S), ACTIVATE THE APPLIANCE SHUNT TRIP, AND DISABLE AN ELECTRIC GAS VALVE AUTOMATICALLY WHEN FIRE CONDITION IS DETECTED ON A COVERED HOOD.
- A DIGITAL CONTROLLER SHALL ALLOW FOR EXTERNAL BMS FAN CONTROL VIA DRY CONTACT (EXTERNAL CONTROL SHALL NOT OVERRIDE FAN OPERATION LOGIC AS REQUIRED BY CODE).
- AN LCD INTERFACE SHALL BE PROVIDED WITH THE FOLLOWING FEATURES:
 - A. DN/DFF PUSH BUTTON FAN & LIGHT SWITCH ACTIVATION.
 - B. INTEGRATED GAS VALVE RESET FOR ELECTRONIC GAS VALVES (NO RESET RELAY REQUIRED).
 - C. VFD FAULT DISPLAY WITH AUDIBLE & VISUAL ALARM NOTIFICATION.
 - D. DUCT TEMPERATURE SENSOR FAILURE DETECTION WITH AUDIBLE & VISUAL ALARM NOTIFICATION.
 - E. MIS-WIRED DUCT TEMPERATURE SENSOR DETECTION WITH AUDIBLE & VISUAL ALARM NOTIFICATION.
 - F. A SINGLE LOW VOLTAGE CAT-5 RJ45 WIRING CONNECTION.
 - G. AN ENERGY SAVINGS INDICATOR THAT UTILIZES MEASURED KWH FROM THE VFDS.

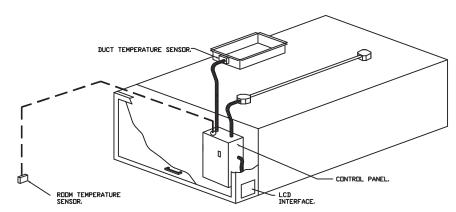

TYPICAL HOOD CONTROL PANEL INSTALLATION

SEQUENCE OF OPERATIONS:


THE HOOD CONTROL PANEL IS CAPABLE OF OPERATING IN ONE OR MORE OF THE FOLLOWING STATES AT ANY GIVEN TIME:


- AUTUMATIC: THE SYSTEM OPERATES BASED ON THE DIFFERENTIAL BETWEEN ROOM TEMPERATURE AND THE TEMPERATURE AT THE HOOD CAVITY OR EXHAUST DUCT COLLAR. FANS ACTIVATE AT A CONFIGURABLE TEMPERATURE DIFFERENTIAL THRESHOLD. DEPENDING ON THE JOB CONFIGURATION EACH FAN ZONE CAN BE CONFIGURED AS STATIC OR DYNAMIC. THESE TERMS REFER TO WHETHER A VARIABLE MOTOR (SUCH AS EC MOTORS OR VFD DRIVEN MOTORS) MODULATE WITH TEMPERATURE. IF THE PANEL IS EQUIPPED WITH VARIABLE SPEED FANS AND THE ZONE IS DEFINED AS "DYNAMIC", THESE WILL MODULATE WITHIN A USER-DEFINED RANGE BASED ON THE TEMPERATURE DIFFERENTIAL. PANELS EQUIPPED WITH VARIABLE SPEED FANS AND A FAN ZONE DEFINED AS "STATIC", FANS WILL RUN AT A SET SPEED CALCULATED FOR THE DRIVE, DEMAND CONTROL VENTILATION SYSTEMS ARE CAPABLE OF MODULATING EXHAUST AND MAKE UP AIR FAN SPEEDS PER THE REQUIREMENTS OUTLINED IN IECC 403.7.5 (2021).
- MANUAL: THE SYSTEM OPERATES BASED ON HUMAN INPUT FROM AN HMI.
- SCHEDULE: A WEEKLY SCHEDULE CAN BE SET TO RUN FANS FOR A SPECIFIED PERIOD THROUGHOUT THE DAY. THERE ARE THREE OCCUPIED TIMES PER DAY TO ALLOW FOR THE USER TO SET UP A TIME THAT IS SUITABLE TO THEIR NEEDS. ANY TIME THAT IS WITHIN THE DEFINED OCCUPIED TIME, THE SYSTEM WILL RUN AT MODULATION MODE AND FOLLOW THE FAN PROCEDURE ALGORITHM BASED ON TEMPERATURE DURING THIS TIME. DURING UNDOCCUPIED TIME, THE SYSTEM WILL HAVE AN EXTRA OFFSET TO PREVENT UNINTENDED ACTIVATION OF THE SYSTEM DURING A TIME WHERE THE SYSTEM IS NOT BEING OCCUPIED.
- <u>OTHER:</u> THE SYSTEM OPERATES BASED ON THE INPUT FROM AN EXTERNAL SOURCE (DDC, BMS OR HARD-WIRED INTERLOCK).
- FIRE: UPON ACTIVATION OF THE HOOD FIRE SUPPRESSION SYSTEM, THE EXHAUST FAN WILL COME ON OR CONTINUE TO TO RUN, THE HOOD MAKEUP AIR WILL SHUTDOWN, AND A SIGNAL WILL BE SENT FOR ACTIVATING THE SHUNT TRIP BREAKER PROVIDED BY THE ELECTRICIAN. FUEL GAS WILL SHUT OFF VIA A MECHANICAL/ELECTRICAL GAS VALVE ACTUATED BY THE HOOD FIRE SUPPRESSION SYSTEM.

JOB HOOD-CALS LIBRARY-LITTLE ROCK,AR

AR, 72201 *JOB #* 6779909

> DRAWN BY REG24-JJ SCALE 3/8" = 1'-0"

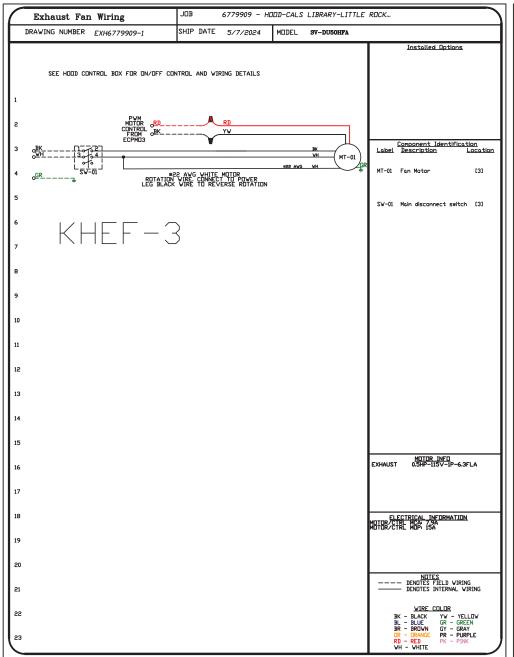


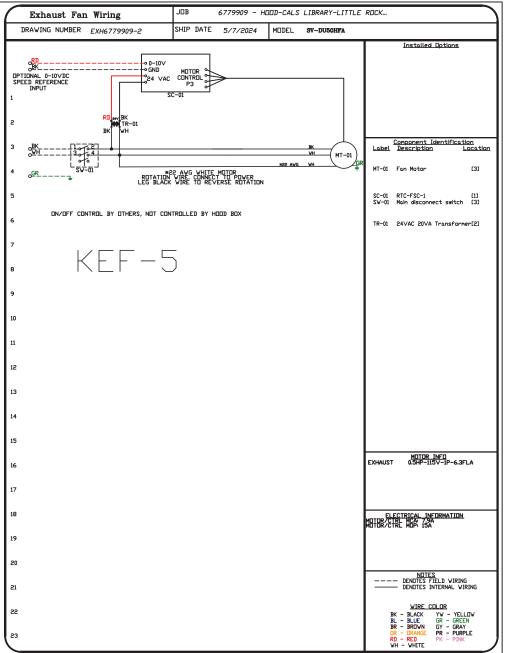

JOB HOOD-CALS LIBRARY-LITTLE ROCK,AR

AR, 72201

Page 46 of 68

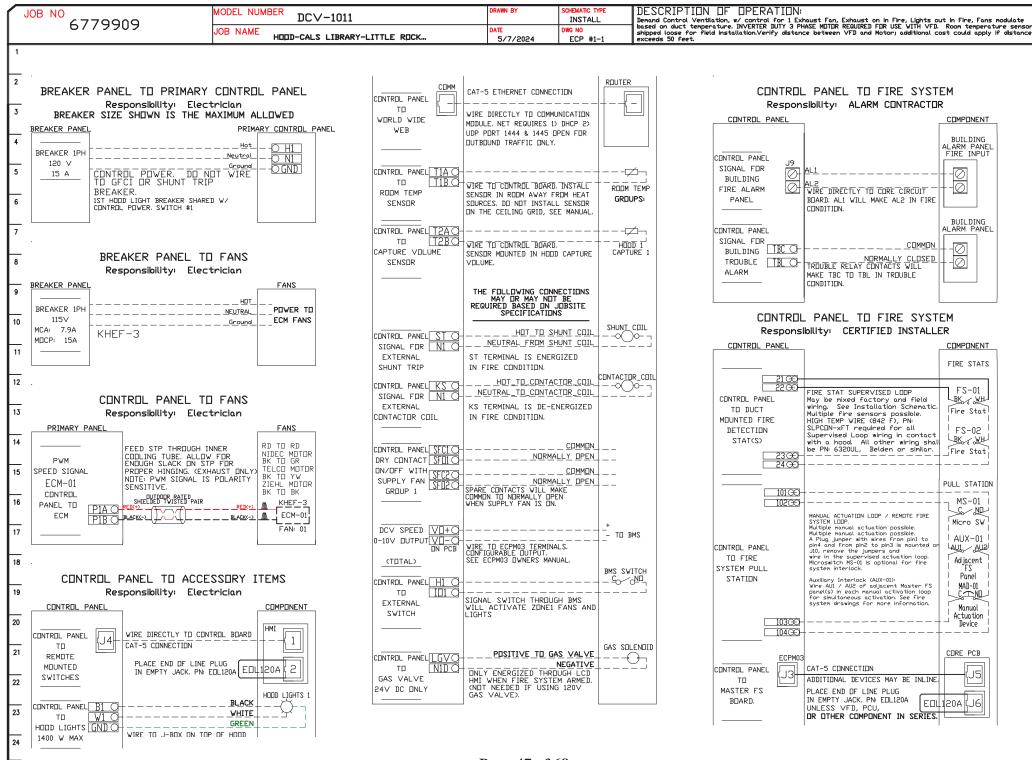

JOB NO 6779909

NOTE: SEE INSTALLATIO

2

MODEL NUMBER DCV-1011

JOB NAME UPDER CALE LYDRAY

HODD-CALS LIBRARY-LITTLE ROCK...

DATE 5/7/2024 INSTALL

ECP #1-3

OWG NO

DESCRIPTION OF OPERATION: Fire System #1 TANK FS - 4.0.

WALL MOUNT UTILITY CABINET TANK PROTECTION ELECTRICAL DETAIL

10/01/2023 Rev. 03

FS-1: MASTER

ELECTRICIAN:

1. VIRE MAIN CONTROL PANEL PER INCLUDED SCHEMATIC


2. VIRE ALL FANS PER INCLUDED SCHEMATIC

3. VIRE SHUNT TRIP BREAKER (OPTIONAL)

4. VIRE UDS APPLIANCE KILL SVITCH, IF EQUIPPED (OPTIONAL)

5. VIRE GAS VALVE

	ELECTRICAL CONTRACTOR REQUIREMENT									
ITEM	CONNECTION IN PANEL	CONNECTION IN DEVICE	VOLTAGE	AMPERAGE	COMMENTS					
SHUNT TRIP BREAKER (OPTIONAL)	ST & N1	BREAKER CDIL (A1 & A2)	120 VAC	< 4 AMPS	ST TO A1 ON SHUNT BREAKER COIL, AND NEUTRAL TO A2 ON SHUNT TRIP BREAKER COIL					
CONTROL PANEL POWER	H1 & N1 + GROUND	CIRCUIT BREAKER	120 VAC	15 AMPS	CONTROL PANEL POWER MUST NOT BE RUN THROUGH SHUNT TRIP BREAKER					
UDS APPLIANCE KILL SWITCH (OPTIONAL)	KTS & N1	KTS & N1	120 VAC	< 4 AMPS	KILL SWITCH TERMINALS MUST BE IN SERIES WITH DTHER KILL SWITCHES					
REMOTE 120VAC ANSUL AUTOMAN (OPTIONAL)	AU1, AU2	SOLENDID	120 VAC	< 6 AMPS	120V TO AU1, AU2 TO ANSUL ELECTRIC AUTOMAN, ANSUL SOLENDID TO NEUTRAL					
GAS VALVE	LGV & N1D (IF 24 VDC) GAS & N1 (IF 120 VAC)	RED/RED/GREEN	24 VDC DR 120 VAC	< 1.0 AMPS	IF 24 VDC - 2 VIRES & GROUND, N1D TO RED, LGV TO RED, AND GREEN TO GROUND IF 120 VAC - 2 VIRES & GROUND GAS TO RED, N1 TO RED, AND GREEN TO GROUND					

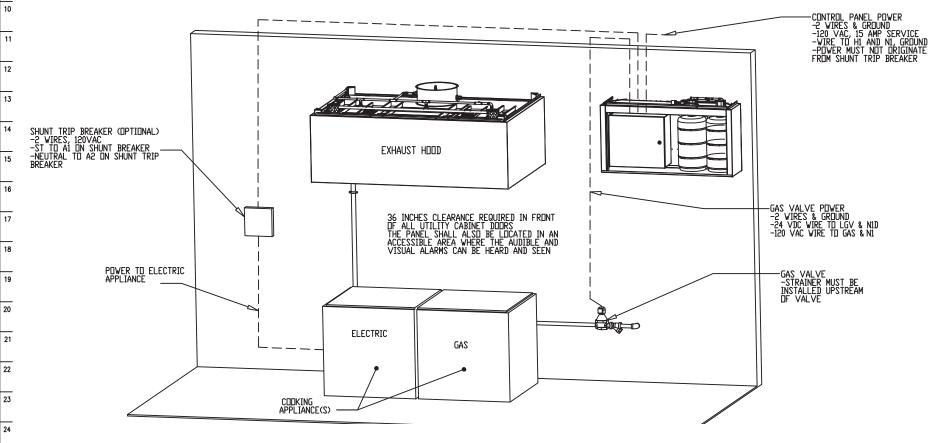

JOB NO
6779909

| MODEL NUMBER | DCV-1011 | DRAWN BY | SCHEMATIC TYPE | INSTALL | Fire System #1 TANK FS - 4.0.
| JOB NAME | HDDD-CALS LIBRARY-LITTLE RDCK... | DATE | 5/7/2024 | DWG NO | ECP #1-4 | DESCRIPTION OF OPERATION: Fire System #1 TANK FS - 4.0.

WALL MOUNT UTILITY CABINET TANK PROTECTION LOW-

2

3

22

23

24

NOTE: SEE INSTALLATIO

ALARM CONTRACTOR:

1. WIRE MANUAL ACTUATION DEVICE(S), REMOTE FIRESTAT(S), CORE INTERLOCK(S), FIRE SENSOR(S) AND FIRE ALARM CONTACTS

2. COMPLETE FINAL HODKUP DE SYSTEM

3. VERIFY FINAL FIRE SYSTEM TEST

......

FS-1: MASTER

Γ			AL ADM C	ONTRACTOR R	EUITDEWEN:	T
-	ITEM	CONNECTION IN PANEL	CONNECTION ON DEVICE	UNIKACIUR K VOLTAGE	AMPERAGE	COMMENTS
ŀ	MANUAL ACTUATION DEVICE(S)	101 AND 104 102 AND 103	1 & 2	24 VDC	< 1.0 AMPS	WIRE MANUAL ACTUATION DEVICE TERMINAL 3 BETWEEN CORE PANEL TERMINALS 102 AND 103 WIRE MANUAL ACTUATION DEVICE TERMINAL 2 BETWEEN CORE PANEL TERMINALS 101 AND 104 JUMPER 101 TO 104 AND 102 TO 103 IF NO MANUAL ACTUATION DEVICE IS INSTALLED
ŀ	MANUAL ACTUATION DEVICE COVER	N/A	N/A	N/A	N/A	JUMPER 101 TO 104 AND 102 TO 103 IF NO MANUAL ACTUATION DEVICE IS INSTALLED MANUAL ACTUATION DEVICE COVER MUST BE INSTALLED IF SURFACE MOUNTED, USE COVER EXTENSION STI-6531B
	REMOTE FIRESTAT SENSOR(S)	21 AND 24 22 AND 23	BLACK AND WHITE	24 VDC	< 1.0 AMPS	MANUAL ACTUATION DEVICE COVER MUST BE INSTALLED IF SURFACE MOUNTED, USE COVER EXTENSION STI-6531B WIRE FIRE SENSOR WHITE WIRES BETWEEN HOLD CORE PANEL TERMINALS 22 AND 23 WIRE FIRE SENSOR BLACK WIRE BETWEEN HOLD CORE PANEL TERMINALS 21 AND 24 HIGH TEMP (842°F) #441601C6FE9 (WHT) & #441601C6FE0 (BLK)WIRE OR SIMILAR DNLY IF RAN OF HODD, DTHERWISE BELDEN #6320UL DR SIMILAR PLENUM RATED WIRE, SEE FIGURE 1
	FIRE ALARM CONTACT	AL1, AL2	VARIES	50V MAX (AC/DC)	UP TD 1 AMP	FIRE ALARM RELAY CONTACTS FOR BUILDING FIRE ALARM LOCATED IN THE CORE ELECTRICAL CONTROL PANEL
	CORE INTERLOCK(S)	CA, CB, CC	CA, CB, CC	RS-485 COMMUN SIGNA	NICATIONS AL	CDRE SYSTEM (1) CA, TD CDRE SYSTEM (2) CA. CDRE SYSTEM (1) CB, TD CDRE SYSTEM (2) CB. CDRE SYSTEM (1) CC, TD CDRE SYSTEM (2) CC. USE BELDEN# 88760 DR SIMILAR WIRE
	TROUBLE CONTACT	TBC, TBL, TOK	VARIES	MAX 120 VAC	UP TO 6 AMPS	WIRE TO TBL & TBC NORMALLY OPEN CONTACT, CLOSES IN TROUBLE CONDITION
	CORE COMMUNICATIONS CABLE	RJ-45 Jack	INTERNET CONNECTION	SIGNAL	<1.0 AMPS	TYPICAL CONNECTION CATS CABLE TO LOCAL AREA NETWORK VIA ETHERNET SWITCH OR WIRELESS ROUTER WITH VALID INTERNET CONNECTION
	-2 WIRES WIRED TO NORMALLY DPEN CI CLOSES IN FIRE CONDITION) -CORE CONTROL PANEL ALI AND AL2 -SEE FIGURE 2 TROUBLE CONTACT -2 WIRES TO NORMALLY DPEN CONTACTS (CLOSE IN TROUBLE	JATHOTS				FIRE ALARM PANEL CDRE INTERLICK 2 WIRES + SHIELD -USE BELDEN#88760 DR SIMILAR WIRE -SEE FIGURE 3
	CONDITION) -CDRE PANEL TERMINALS TBL AND TBC -SEE FIGURE 4 SUPERVISED LODP -4 WIRES, 24VDC CONNECT BLACK WIRES BETWEEN 21 AND 24 IN PANEL, CONNECT WHITE (DR RED) WIRES BETWEEN 22 AND 23 IN PANEL -ADDITIONAL FIRESTATS, WIRED IN SUPERVISED LODP -USE HIGH TEMP (842*F) #441601C6.FE9 (WHT) & #441601C6.FE0 (BLK)WIRE DINLY IF PAN MIVEP TIPD IS HODD.		EXHAUST HODD		MANU	ATTIN I II SUPERVISED LOOP
	RAN DVER TOP OF HODD; OTHERVISE BELDEN #6320UL OR SIMILAR PLENUM RATED VIRE -SEE FIGURE 1		36 INCHES CLEARANCE REQUERINT DE ALL UTILITY CAB THE PANEL SHALL ALSD BE AN ACCESSIBLE AREA WHERE AUDIBLE AND VISUAL ALARM HEARD AND SEEN	INCE DIORS LDCATED IN THE S CAN BE	DEV: 10 TE FEET HODD LE NEAR F OF EG FROM	TO SEE FIGURE IA SECTIONE IA MANUAL ACTUATION DEVICE PART #SS2031ZA-EN PROTECTIVE COVER MUST BE INSTALLED RESS
			ELECTRIC	GAS		CENTER OF PUSH STATION
		COOKING APPLIANCE(S	(3)			
	ATTENTION: LC BE ROUTED IN			Page	49 of 68	

Page 49 of 68



SUBMITTAL

PRODUCT Recirculating Kitchen Hood with Fire Suppression

MANUFACTURER Denlar

JOB NAME CALS Main Library Renovation

LOCATION Little Rock, AR

ENGINEER Bernhard TME

CONTRACTOR Comfort Systems

DATE 5/14/2024

SUBMITTED BY Courtney Michael

5440 Northshore Drive - North Little Rock, Arkansas 72118 - Tel: 501.374.5420 Fax: 501.370.9298



Date:		Job Name:	CALS	S Library Renovatio	Mark:
Refere	nce:	Unit Location:			Prepared By:
Engine	eer:	Contractor:			Approval:
Expect	red Job Date:	Notes:			
UNIT	OPTIONS:				
	ADA Fan/Light Control		×	Manual Pull Station	
	ClockBox			ClockBox Pro	
	Custom Color Specify Color	:		Top Cover	
	Test Tank			Make-Up Air Control Module	Please specify correct receptacle
	Strobe -Light & Annunciator			Limiting Speed Control Modu	
	Power Distribution Block Mod	lule		Relay Control Module	
DISCO	ONNECT OPTIONS:				
	3/4" NPT Natural Gas (DED	Needed if Electric	Compone	ents Need to be Controlled on a	Gas Range)
×	Electric *Specify NEMA: 220	VAC = □ 14-50R	□ 6-20F	R □ 10-50R 120VAC = □ 5	15R □ 5-20R
	Dual Element (includes 3/4" N	NPT Natural Gas a	ınd Electri	c)	
	*Specify NEMA: 220VAC =	□ 14-50R □ 6-20F	R □ 10-5	50R 120VAC = 5-15R □ 5	-20R
				120VAC = □ 5-15R □ 5-20F	
ELEC'	TRIC NEMA (RECEPTACL	E) OPTIONS	K		
		· W		□G /	

□ 6-20

220VAC 20AMP

120VAC 15AMP

GENERAL FEATURES:

220VAC 50AMP

- Wall Mounted
- Pre-Engineered Fire Suppression System
- Variable Fan Speed Control
- Two Step Pre-Suppression
- Plenum Nozzle
- MAIN Power Switch
- Reset Switch
- Light Switch
- Pressure Gauge
- Temperature Switches Triggering Pre-emptive Shutdown

220VAC 50AMP

- Hard Wired Fuel Source Disconnect
- Dry Alarm Contacts
- On Board Diagnostics
- Status LED
- Trouble Signal
- Service Key
- Audible Buzzer (90dB)
- Service Switch
- Pressure Switch
- Grease Baffle w/ Drip Tray
- ETL/CSA Listed
- Permanently Lubricated Centrifugal Fan Motor listed to
 UI 507
- Local, Remote and Trouble Alarms
- Shatter-Proof or LED Bulb

FEATURES		DESCRIPTION				
Compliance	UL300A	NSF	UL507			
Canopy Width	36 Inches					
Dimensions In.	35-7/8 x 19	9-3/8 x 10-1	1/2			
Weight Lbs.	56.8					
Voltage / Hz / Amps	120 / 60 / 3	3				
МОСР	15A					
Fire Control	Programmable Logic Controller					
Tank Type / Pressure / Volume	Stainless Steel / 102+-8% Psi / 1.84 Liters					
Venting / Fan Type / Speed	Recirculating / Integral / Variable Speed					
CFM	174 ~ 276					
Min / Max Installation Height	30 / 36 Inc	hes				
Duct Collar (In. / mm)	N/A					
Sound Rating	62 / 70 dB					
Finish	18 & 20 GA	304 Brush	ned Stainless Steel			
Lighting	(1) LED Bul	b Medium	Base			
Suppression Agent	Low pH Wet Chemical Amerex 660					
No. of Nozzles / Spray	4 / 60 Degree Conical					
Actuation Type	Mechanical Fail-Safe					
Protection Device / Limit	3 Globe Links / 280°F					

120VAC 20AMP

Model D1036-F

Technical Data Book



Not responsible for typographical errors. Continuing research results in product improvement, therefore specifications are subject to change without notice. For the most updated information, please consult factory directly.

LAB-110259 REV12202021

Table of Contents

D1036-F Model Information

Model Identification

D1000 Dimensions and Weights

Electrical Specifications

Fan Specifications and Dimensions

Exhaust Layout

Back Plate Support Layout

D1000 Nozzle Placement


D1000 Tank Information

Accessories	Part Number
Alarm Information	
Manual Pull Station	D1000-MPK
ClockBox Specifications and Dimensions	CLBX & CLBX-PRO
Electric Disconnect	D1000-E
Gas Disconnect	D1000-G
<u>Dual Receptacle Disconnect</u>	D1000-DRD
<u>Dual Element Disconnect</u>	D1000-DED
Tank Fully Charged	D1000-TANK-FC
Tank with Amerex Only	D1000-TANK-SA
Tank Test-Nitrogen Only	D1000-TANK-TEST
Tank Not Charged	D1000-TANK-E
Horn and Strobe	D1000-STROBE
Fan by Others	D1000-FBO
Make Up Air Fan Control Module/Damper Control	D1000-MACM
CFM Limiting Speed Control	D1000-LSC
Handicap Accessible Controls	D1000-ADA
Top Cover	D1030-TC-F(R)



Model Identification

Model Identification

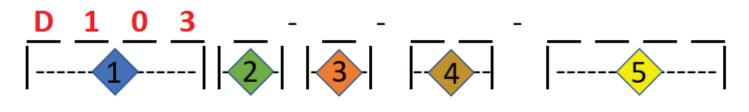

ID	1
Label	Model
D103	Denlar

ID	2
Label	Size
0	30" Model
6	36" Model

ID	3
Label	Exhaust Type
F	Front Exhaust
R	Rear Exhaust
D	Top Ducted Exhaust


ID	4
Label	Top Ducted Fan Type
IF	Inline Fan
RF	Roof Fan
WF	Wall Mount Fan

ID	5
Label	NFPA Compliant
	Includes High Performance Fan,
NFPA	Manual Pull Station, Timer Lock
	Out System



D1000 Dimensions and Weights


	Mode	el Dimensions a	nd Weight			
MODEL	MOUNTING CONFIG.	MOUNTING HEIGHT (In.)	LENGTH (In.)(A)	DEPTH (In.)(B)	HEIGHT (In.)(C)	WEIGHT (Lbs.)
D1030-F					10.5	53.4
D1030-F-NFPA					14.8	75
D1030-R					10.5	53.4
D1030-R-NFPA					14.8	75
D1030-D-IF		MIN:24	30			
D1030-D-IF-NFPA		MAX:30	30			
D1030-D-RF					10.5	53.4
D1030-D-RF-NFPA					10.5	33.4
D1030-D-WF						
D1030-D-WF-NFPA	WALL			19.375		
D1036-F	VVALL			19.373	10.5	56.8
D1036-F-NFPA					14.8	78.8
D1036-R					10.5	56.8
D1036-R-NFPA					14.8	78.8
D1036-D-IF		MIN:30	36			
D1036-D-IF-NFPA		MAX:36	30			
D1036-D-RF					10.5	56.8
D1036-D-RF-NFPA					10.5	30.0
D1036-D-WF						
D1036-D-WF-NFPA						

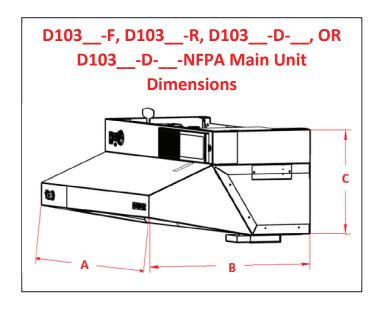



Electrical Specifications

				Florantical tod					
MODEL	VOLATGE (AC)	OLATGE (AC) PHASE FREQUENCY BREAKER (Hz.) SIZE		CIRCUIT BREAKER SIZE (AMPS)	OPERATING CURRENT (AMPS)	FAN OPERATING CURRENT (AMPS)	OUTPUT OPERATING CURRENT (AMPS)	INPUT WIRING	OUTPUT WIRING
D1030-F					1.38	0.8			
D1030-F-NFPA					3.7	3.1			
D1030-R					1.38	0.8			
D1030-R-NFPA					3.7	3.1			
D1030-D-IF					2.4	1.8			
D1030-D-IF-NFPA					3.1	2.5			
D1030-D-RF					4.6	4			
D1030-D-RF-NFPA					5.6	5			
D1030-D-WF					1.38	0.8	0.25	12/2	14/2
D1030-D-WF-NFPA	120	1	60	15-20	3.7	3.1	to	MC	MC
D1036-F	120	1	60	15-20	1.38	0.8	0.5	WIRE	WIRE
D1036-F-NFPA					3.7	3.1			
D1036-R					1.38	0.8			
D1036-R-NFPA					3.7	3.1			
D1036-D-IF					2.4	1.8			
D1036-D-IF-NFPA					3.1	2.5			
D1036-D-RF					4.6	4			
D1036-D-RF-NFPA					5.6	5			
D1036-D-WF					1.38	0.8			
D1036-D-WF-NFPA					3.7	3.1			

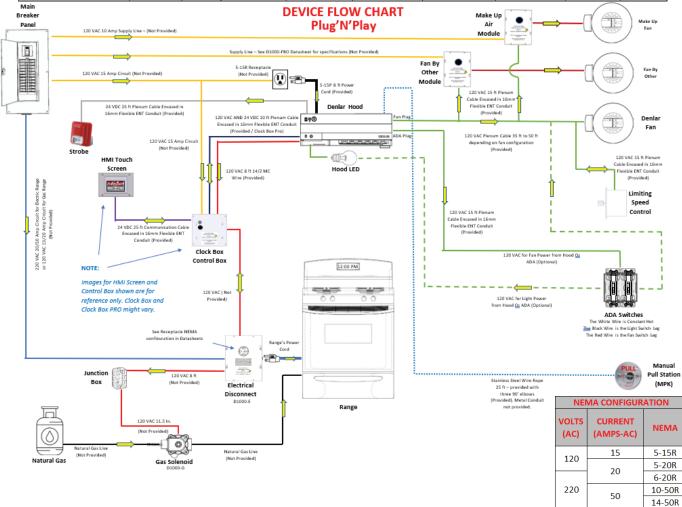




Fan Specifications


								Fan Ratings								
MODEL	STYLE	ТҮРЕ	WEIGHT (Lbs.)	OPERATING CURRENT (AMPS)	VOLATGE (AC)	PHASE	FREQUENCY (Hz.)	CFM +-2.5% (LOW-HIGH)	PRESSURE (In. WATER)	DBA (LOW-HIGH)	HOOD OUTLET (In.)(LxH)	DUCT	FAN INLET	FAN OUTLET	CONTROL	SPEEDS
D1030-F	Front		6.25	0.8				174~276	-0.09 ~ -0.18	62~70	12 X 3	N/A	6.5 (Dia.)	12 X 3		
D1030-F-NFPA	Discharge	Integral	22	3.1				216~514	-0.26 ~ -1.38	60~84	30 x 4	N/A	9.8 x 9.7	30 x 4		
D1030-R	Rear	to Hood	6.25	0.8				139~279	-0.09 ~ -0.17	62 ~ 70	12 X 3	4- 24 In.	6.5 (Dia.)	12 X 3		
D1030-R-NFPA	Discharge		22	3.1				174~519	-0.25 ~ -1.35	60~80	10 X 4.25	4- 24 III.	9.8 x 9.7	10 X 4.25		
D1030-D-IF	Inline	Durated	10.5	1.8				283~474	-0.23 ~ -0.61	57~69		35 ft.	10 (Dia.)	10 (Dia.)		
D1030-D-IF-NFPA	Inline	Ducted	13.5	2.5				297~545	-0.29 ~ -0.89	60 ~ 70		35 IL.	12 (Dia.)	12 (Dia.)		
D1030-D-RF	Inline Ducted	Roof w/Curb adapter		4				357~499	-0.40 ~ -0.84	61~73			10 (Dia.)	20-13/16 (Dia.)		
D1030-D-RF-NFPA	Roof Mount	(Without physical curb)	35	5				326~548	-0.39 ~ -1.09	63 ~ 75	7 (Dia)	7 (Dia) 50 ft.	9 7/8	20 (Dia.)		
D1030-D-WF	Wall	External Wall	13.5	0.8				208~281	-0.14 ~ -0.28	56 ~ 60		35 ft.	6.5 (Dia.)	14 x 3		
D1030-D-WF-NFPA	Mount	Ducted	20.5	3.1				172~522	-0.10 ~ -0.66	60 ~ 75		35 π.	8.5 (Dia.)	12 X 3	Electronic Control	
D1036-F	Front		6.25	0.8	120	1	60	174~276	-0.09 ~ -0.18	62~70	12 X 3	N/A	6.5 (Dia.)	12 X 3	Module	Variable
D1036-F-NFPA	Discharge	Integral	22	3.1				216~514	-0.26 ~ -1.38	60~84	30 x 4	IN/A	9.8 x 9.7	30 x 4	(ECM)	
D1036-R	Rear	to Hood	6.25	0.8				139~279	-0.09 ~ -0.17	62 ~ 70	12 X 3	4- 24 In.	6.5 (Dia.)	12 X 3		
D1036-R-NFPA	Discharge		22	3.1				174~519	-0.25 ~ -1.35	60~80	10 X 4.25	4- 24 111.	9.8 x 9.7	10 X 4.25		
D1036-D-IF	Inline	Ducted	10.5	1.8				283~474	-0.23 ~ -0.61	57~69		35 ft.	10 (Dia.)	10 (Dia.)		
D1036-D-IF-NFPA	IIIIII	Ducteu	13.5	2.5				297 ~ 545	-0.29 ~ -0.89	60~70		33 11.	12 (Dia.)	12 (Dia.)		
D1036-D-RF	Inline Ducted	Roof w/Curb adapter	35	4				357~499	-0.40 ~ -0.84	61~73		50 ft.	10 (Dia.)	20-13/16 (Dia.)		
D1036-D-RF-NFPA	Roof Mount	(Without physical curb)	35	5				326~548	-0.39 ~ -1.09	63 ~ 75	7 (Dia)	50 π.	9 7/8	20 (Dia.)		
D1036-D-WF	Wall	External	13.5	0.8				208~281	-0.14 ~ -0.28	56 ~ 60			6.5 (Dia.)	14 x 3		
D1036-D-WF-NFPA	Mount	Wall Ducted	20.5	3.1				172~522	-0.10 ~ -0.66	60 ~ 75		35 ft.	8.5 (Dia.)	12 X 3		

Fan Dimensions

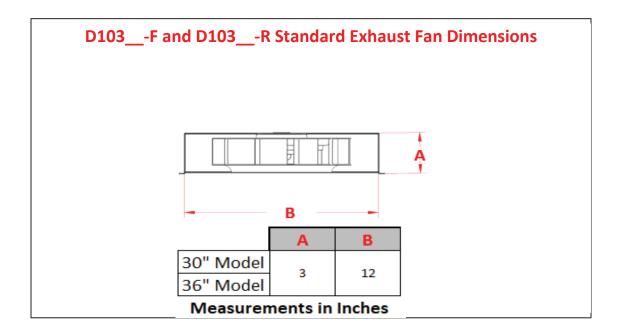





Exhaust Layout

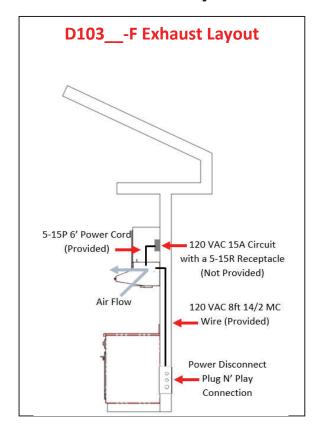


Back Plate Support (BPS) Layout

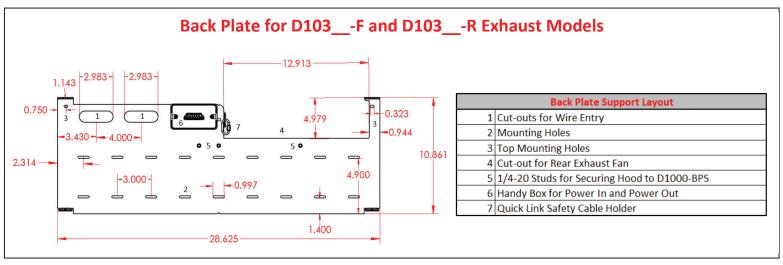


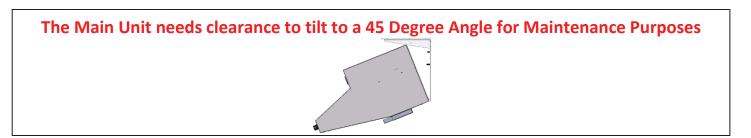



D1000 Nozzle Placement

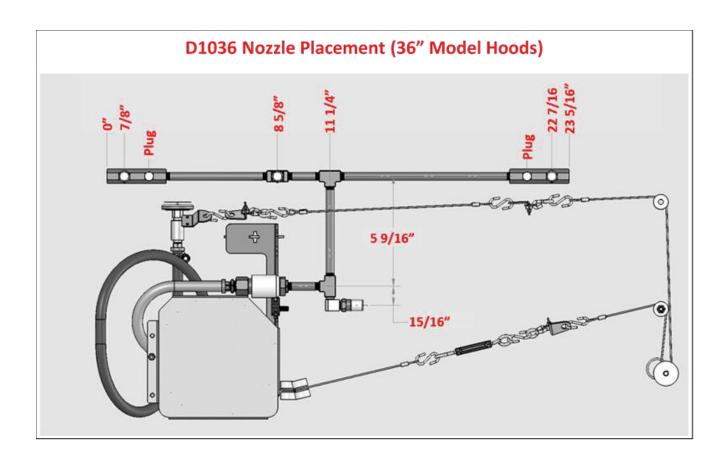

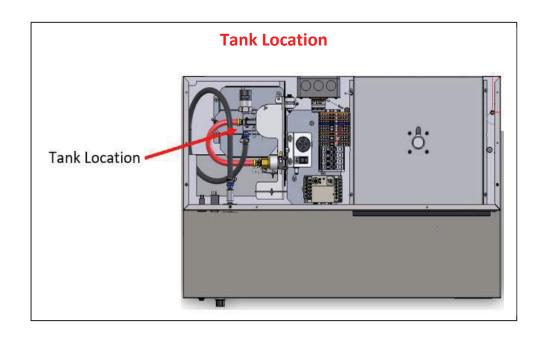




D1000-Tank Information

D1000-TANK-FC

(Integral to all D1000 Hood Models)

		Tank Information												
	ТҮРЕ	COMPLIANCE	MOUNTING CONFIGURATION	LENGTH (In.)	DEPTH (In.)	HEIGHT (In.)	WEIGHT (Lbs.)	VESSEL	CHEMICAL TYPE	VOLUME (mL.)	CHEMICAL WEIGHT (Lbs.)	PRESSURE (PSI)+-8%		
D1000-TANK-FC	Self Contained Fire Supppresion System	UL-1995	Integral to the Hood	N/A	6	8	9.4	Stainless Steel	Amerex 660	1300	2.2	102		

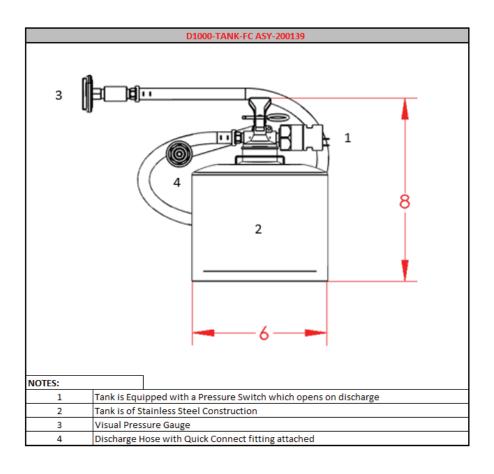





Alarm Information

(Integral to all D1000 Models)

		Alarm Ratings												
	TYPE OF CONTACTS		CONTACT AMPERAGE DECIBLES (AC)		LOCATION	Activates Upon								
Internal Buzzer	Audible	None	None	90	Top Center of the Main Unit	Tank Discharge Hose Disconnected, Low Pressure in the Tank, or High Temperature								
Maintenance Alarm			5	None	PLC Contacts CO and YO	Fault (190'F Deg. At the Hood)								
Local Alarm	Dry Contact	Com / NO			PLC Contacts C1 and Y1	Low Pressure in the Tank and High Temperature Fault (190'F Deg. At the Hood)								
Micro-Switch	Dry Contacts	Com/NO/NC	15		Micro-Switch above Tank Actuation Paddle	Mechanical Discharge of the Tank								

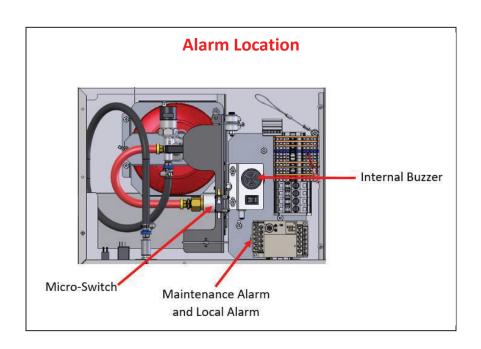

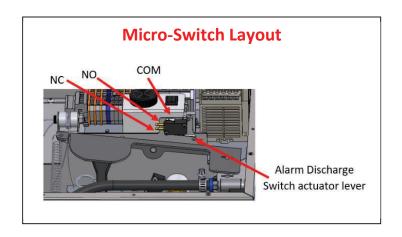



Manual Pull Station Data

D1000-MPK

(Included in NFPA Models)

The Manual Pull Station (D1000-MPK) is designed to discharge the D1000 Model when a user pulls the tab from the Manual Pull Station Face Plate. The D1000-MPK is provided with 25 feet Stainless-steel Cable and with three 90 Degree Corner Pulleys. It is required to have 7-10 inches extra of the Stainless-steel Cable at the Pull Station Box.

The D1000-MPK comes equipped with the following:

- 1x Enclosure 4" x 1.5" Octagon Metal Box
- 1x Manual Pull Station Face Plate
- 1x 1/2" ENT Conduit Connector
- 3x 90 Degree Corner Pulleys
- 1x 25' Stainless-steel Cable with Clevis Pin



1x Enclosure 4" x 1.5" Octagon Metal Box




1x Manual Pull station Face Plate



1x 1/2" ENT Conduit
Connector



3x 90' Degree Corner
Pulleys

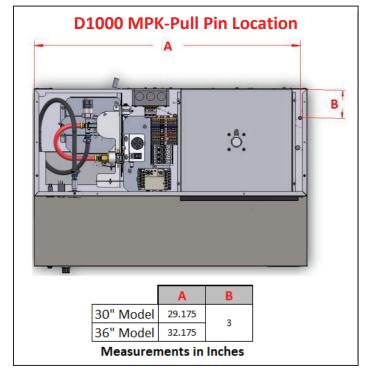





ELECTRICAL DISCONNECT

D1000-E

		ELECTRICAL SPECIFICATIONS										
		RE	CEPTACLE RATI	NGS	COIL RATINGS							
MODEL	PART NUMBER	NEMA	OUTPUT VOLTS (AC)	OUTPUT CURRENT (AMPS)	COIL VOLTAGE (AC)	PHASE	FREQUENCY (Hz.)	FUSE (AMPS)	FUSE TYPE	OPERATING CURRENT (AMPS)		
D1000-E-120 5-15	ASY-300068	5-15R	120	15			60	0.5	5X20mm CARTRIDGE			
DS-E-120 5-15	ASY-300071	J-13K										
D1000-E-120 5-20	ASY-300035	5-20R	120									
DS-E-120 5-20	ASY-300038	3-2UK		20								
D1000-E-220 6-20	ASY-300067	6-20R		20	420							
DS-E-220 6-20	ASY-300070	6-2UK			120	1		0.5		0.25		
D1000-E-220 10-50	ASY-300055	10-50R	220									
DS-E-220 10-50	ASY-300069	10-50K	220	50								
D1000-E-220 14-50	ASY-200074	14 500		50								
DS-E-220 14-50	ASY-200178	14-50R										

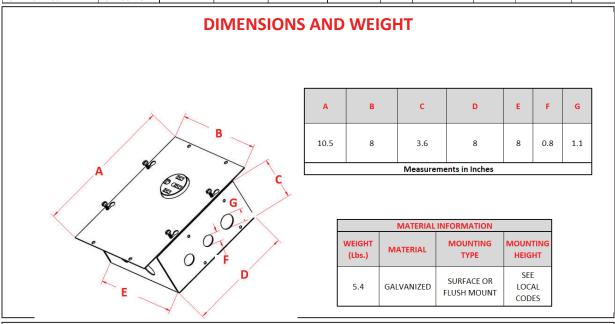

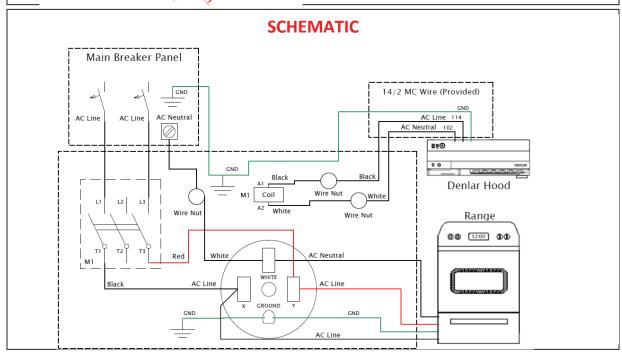



TANK FULLY CHARGED

D1000-TANK-FC

(Integral to all D1000 Hood Models)

						Tanl	k Informat	tion					
MODEL	PART NUMBER	ТҮРЕ	COMPLIANCE	MOUNTING CONFIGURATION	LENGTH (In.)	DEPTH (In.)	HEIGHT (In.)	WEIGHT (Lbs.)	VESSEL	CHEMICAL TYPE	VOLUME (mL.)	CHEMICAL WEIGHT (Lbs.)	PRESSURE (PSI)+-8%
D1000-TANK-FC	ASY-200139	Self Contained Fire Suppression System	UL-1995	Integral to the Hood	N/A	6	8	9.4	Stainless Steel	Amerex 660	1300	2.2	102

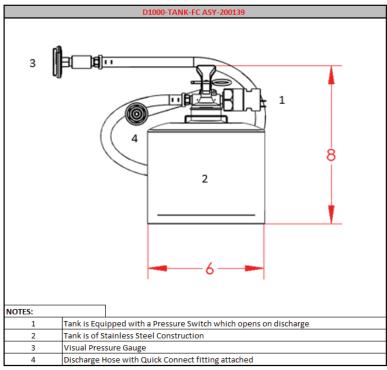

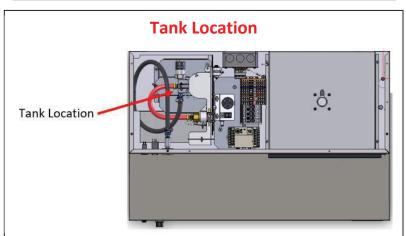





TANK WITH AMEREX AND NOT CHARGED

D1000-TANK-SA

		Tank Information											
MODEL	PART NUMBER	ТҮРЕ	COMPLIANCE	MOUNTING CONFIGURATION	LENGTH (In.)	DEPTH (In.)	HEIGHT (In.)	WEIGHT (Lbs.)	VESSEL	CHEMICAL TYPE	VOLUME (mL.)	CHEMICAL WEIGHT (Lbs.)	PRESSURE (PSI)+-8%
D1000-TANK-SA	ASY-200143	Self Contained Fire Suppression System	UL-1995	Integral to the Hood	N/A	6	8	6	Stainless Steel	Amerex 660	1300	2.2	(Charge to 102 on location)

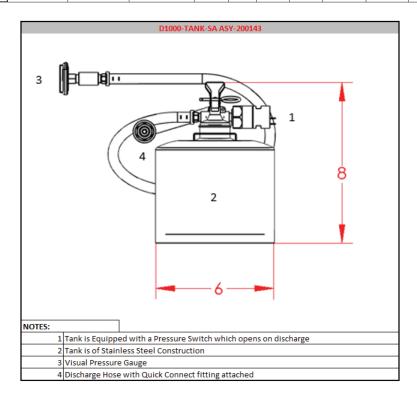

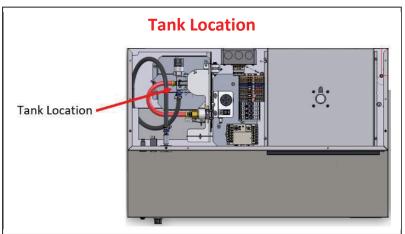





TANK TEST – NITROGEN CHARGED ONLY

D1000-TANK-TEST

		Tank Information											ı	
MODEL	PART NUMBER	ТҮРЕ	COMPLIANCE	MOUNTING CONFIGURATION	LENGTH (In.)	DEPTH (In.)	HEIGHT (In.)	WEIGHT (Lbs.)	VESSEL	CHEMICAL TYPE	VOLUME (mL.)	CHEMICAL WEIGHT (Lbs.)	PRESSURE (PSI)+-8%	
D1000-TANK- TEST	ASY-200140	Self Contained Fire Suppression Test System with Nitrogen	III ₋ 1995	Integral to the Hood	N/A	6	8	6	CRS	None	0	None	102	

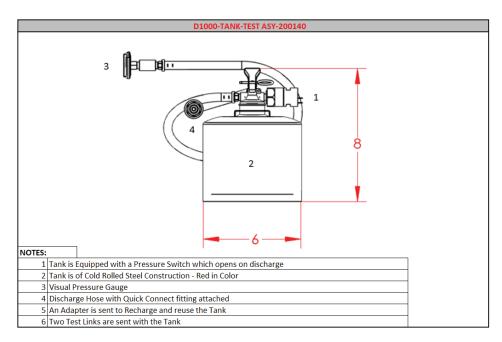

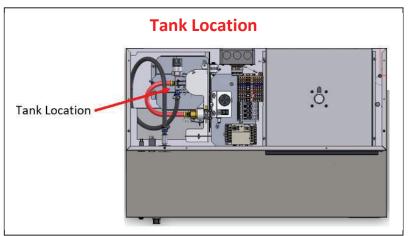





TANK NOT CHARGED

D1000-TANK-E

						Tanl	k Informat	tion					
MODEL	PART NUMBER	ТҮРЕ	COMPLIANCE	MOUNTING CONFIGURATION	LENGTH (In.)	DEPTH (In.)	HEIGHT (In.)	WEIGHT (Lbs.)	VESSEL	CHEMICAL TYPE	VOLUME (mL.)	CHEMICAL WEIGHT (Lbs.)	PRESSURE (PSI)+-8%
D1000-TANK-E	ASY-200141	Self Contained Fire Suppression Test System	UL-1995	Integral to the Hood	N/A	6	8	6	CRS	None	0	None	(Charge to 102 on location)

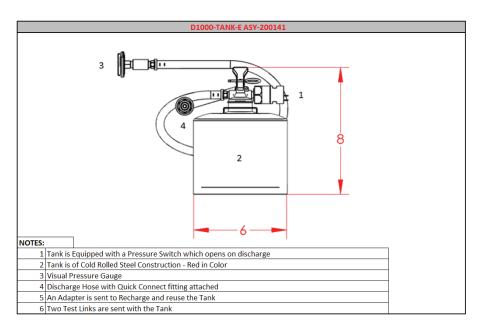

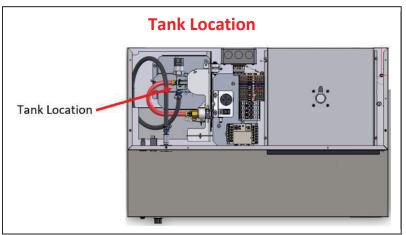



TOP COVER

D1030-TC-F(R)

(D1000 Only)

