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P	SHEET INDEX VOLUME 1																			
N	SHEET INDEX VOLUME 1																			
M	SHEET INDEX VOLUME 1																			
L	SHEET INDEX VOLUME 1																			
K	SHEET INDEX VOLUME 1																			
J	SHEET INDEX VOLUME 1																			
H	SHEET INDEX VOLUME 1																			
G	SHEET INDEX VOLUME 1																			
F	SHEET INDEX VOLUME 1																			
E	SHEET INDEX VOLUME 1																			
D	SHEET INDEX VOLUME 1																			
C	SHEET INDEX VOLUME 1																			
B	SHEET INDEX VOLUME 1																			
A	SHEET INDEX VOLUME 1																			



AM0003 - REVISED INDEX FOR AMENDMENT 03	JAN 2026
AM0002 - REMOVED CATHODIC PROTECTION	JAN 2026
READY TO ADVERTISE (RTA) SUBMITTAL	JUL 2026
MARK	DATE
2	
1	
0	
DESCRIPTION	

DESIGNED BY:	ISSUE DATE:	CONTRACT NO.:	FILE NAME:
J. VOIGHT	JUL 2025	W9127S24F007	165438_G_R22.rvt
DRAWN BY:	SUBMITTAL NO.:	CONTRACT NO.:	FILE NAME:
J. VOIGHT	W9127S25RA001	W9127S24F007	165438_G_R22.rvt
CHECKED BY:	CONTRACT NO.:	CONTRACT NO.:	FILE NAME:
B. STREIBIN	W9127S24F007	W9127S24F007	165438_G_R22.rvt
SUBMITTED BY:	CONTRACT NO.:	CONTRACT NO.:	FILE NAME:
B. STREIBIN	W9127S24F007	W9127S24F007	165438_G_R22.rvt
ANSI:	CONTRACT NO.:	CONTRACT NO.:	FILE NAME:
165438	W9127S24F007	W9127S24F007	165438_G_R22.rvt

US ARMY CORPS OF ENGINEERS LITTLE ROCK DISTRICT LITTLE ROCK, ARKANSAS	BURNS AND McDONNELL LITTLE ROCK DISTRICT KANSAS CITY, MO 64114 165438
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F-35: SPECIAL ACCESS PROGRAM FACILITY EBBING AIR NATIONAL GUARD BASE (ANGB), FORT SMITH, ARKANSAS	SHEET INDEX VOLUME 1	SHEET ID G-002.2
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READY-TO-ADVERTISE (RTA) SUBMITTAL

LEGEND

EXTERIOR GLASS

REFERENCE SPECIFICATION 08 81 00 FOR SYSTEM TYPES

-  G1 INSULATED GLASS UNIT (TINTED - FRITTED)
-  G5 INSULATED GLASS UNIT (TINTED)

SHEET KEYNOTES

1.02	PVC MEMBRANE ROOFING, WHITE. SLOPE 1/2" PER 12" MIN.
1.04	PREFINISHED METAL COPING. COLOR: LIGHT GREY, RGB: 144/138/131.
1.08	MECHANICAL EQUIPMENT / MECHANICAL DUCT OR PIPING (RE: MECHANICAL).
1.11	ROOF ACCESS LADDER.
1.23	THROUGH WALL OVERFLOW SCUPPER.
1.25	CONTINUOUS HORIZONTAL FALL PROTECTION SYSTEM, FINAL LAYOUT TO BE DETERMINED BY FALL PROTECTION MANUFACTURER.
2.01	BRICK VENEER WITH 2" MINIMUM AIR SPACE. COLOR: FLYING RAZOR BACK BLEND - RUNNING BOND PATTERN.
2.02	BRICK VENEER CONTROL JOINT.
2.03	BRICK VENEER WITH 1" MINIMUM AIR SPACE. COLOR: FLYING RAZOR BACK BLEND - RUNNING BOND PATTERN.
2.05	RF SHIELDED INSULATED EXTERIOR PERSONNEL DOOR AND FRAMES, RE: DOOR SCHEDULE. COLOR: MEDIUM GREY, RGB: 120/115/110, REFER TO GJ SERIES OF DRAWINGS.
2.06	INSULATED EXTERIOR LOADING DOOR, RE: DOOR SCHEDULE. COLOR: LIGHT GREY, RGB: 144/138/131.
2.08	PREFINISHED ALUMINUM THERMALLY BROKEN DOOR AND FRAME SYSTEM. COLOR: ANODIZED ALUMINUM, CLEAR, NO. 14.
2.09	PREFINISHED ALUMINUM WINDOW SYSTEM. COLOR: ANODIZED ALUMINUM, CLEAR, NO. 14.
2.10	PREFINISHED METAL CONDUCTOR BOX AND DOWNSPOUT. COLOR: LIGHT GREY, RGB: 144/138/131.
2.12	PREFINISHED ALUMINUM AND GLASS CURTAIN WALL SYSTEM. COLOR: ANODIZED ALUMINUM, CLEAR, NO. 14.
2.14	PREFINISHED METAL GUTTER AND DOWNSPOUT. COLOR: LIGHT GREY, RGB: 144/138/131.
2.18	EXTERIOR LIGHT FIXTURE (RE: ELECTRICAL).
2.20	BRICK VENEER WITH 2" MINIMUM AIR SPACE. COLOR: FLYING RAZOR BACK BLEND - SOLDIER COURSE.
2.22	INSULATED METAL WALL PANEL (MP-1). COLOR: LIGHT GREY, RGB: 144/138/131.
2.43	PRE-ENGINEERED SHADE STRUCTURE.
2.44	HORIZONTAL BRICK VENEER CONTROL JOINT AT LINTEL TYPE L-1 (RE: STRUCTURAL).
3.31	INSULATED METAL PANEL FASCIA AND SOFFIT. COLOR: LIGHT GREY, RGB: 144/138/131.



US Army Corps of Engineers ©

MARK	DESCRIPTION	DATE
1	AM 0003 - ADDED OR REVISED DETAIL CALL OUTS	JAN 2026
0	READY TO ADVERTISE (RTA) SUBMITTAL	JUL 2026

DESIGNED BY: M. TOUBERT	ISSUE DATE: JUL 2025
DRAWN BY: R. NEDDO	SOLICITATION NO.: W9127S25RA001
CHECKED BY: B. MCKINNEY	CONTRACT NO.: W9127S24E007
SUBMITTED BY: B. STREIBIN	FILE NAME: 165438 ARCH - R22 - 1.rvt
ANSI D:	165438 ARCH - R22 - 1.rvt

US ARMY CORPS OF ENGINEERS
LITTLE ROCK DISTRICT
LITTLE ROCK, ARKANSAS


BURNS AND McDONNELL
KANSAS CITY, MO 64114
165438

F-35: SPECIAL ACCESS PROGRAM FACILITY
EBBING AIR NATIONAL GUARD BASE (ANGB), FORT SMITH, ARKANSAS



REGISTERED ARCHITECT
MILES W. TOUBERT
License Number 912611
STATE OF ARKANSAS
01/12/2026

EXTERIOR BUILDING ELEVATIONS


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A-203.1

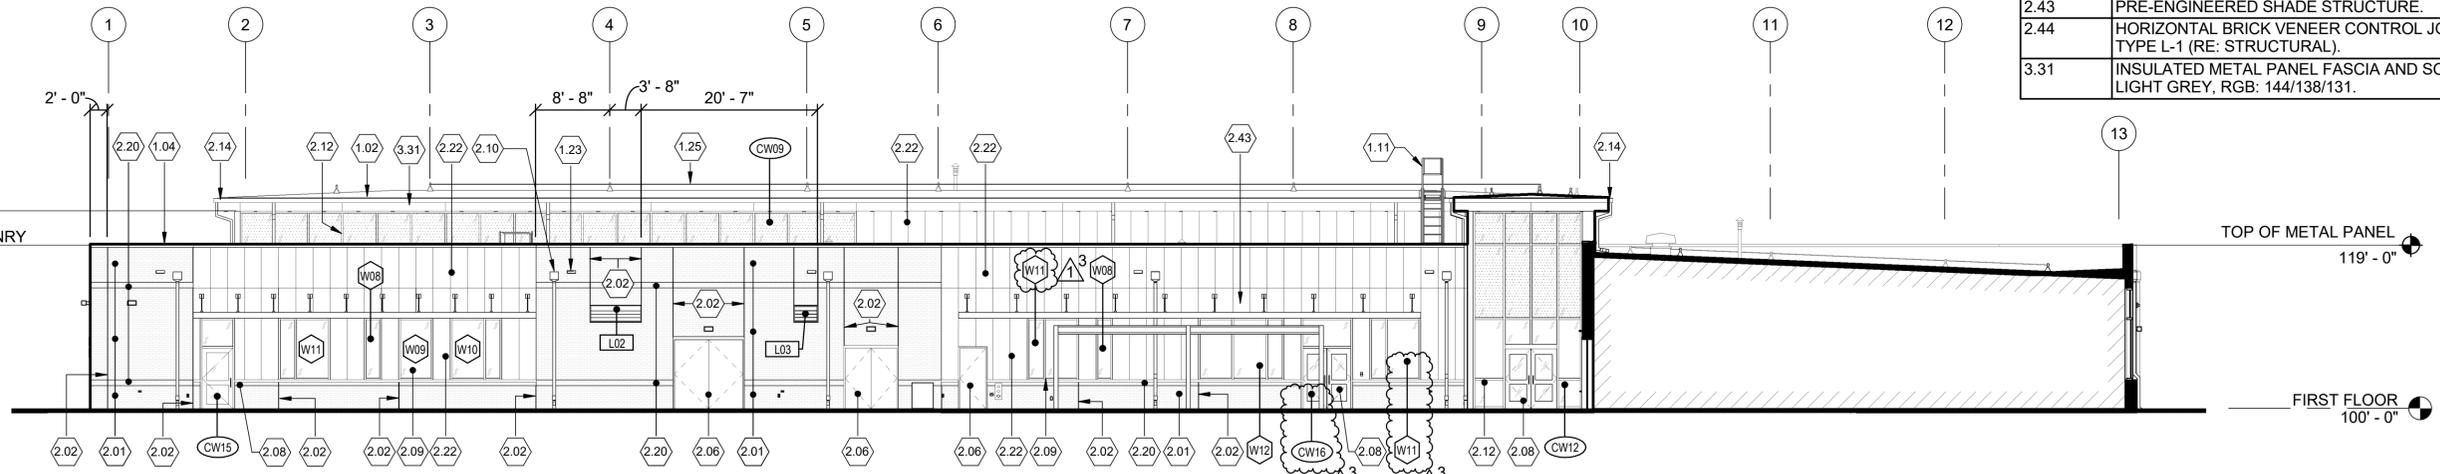


E1 EXTERIOR ELEVATION - SOUTH (AREA A)
SCALE: 3/32" = 1'-0"

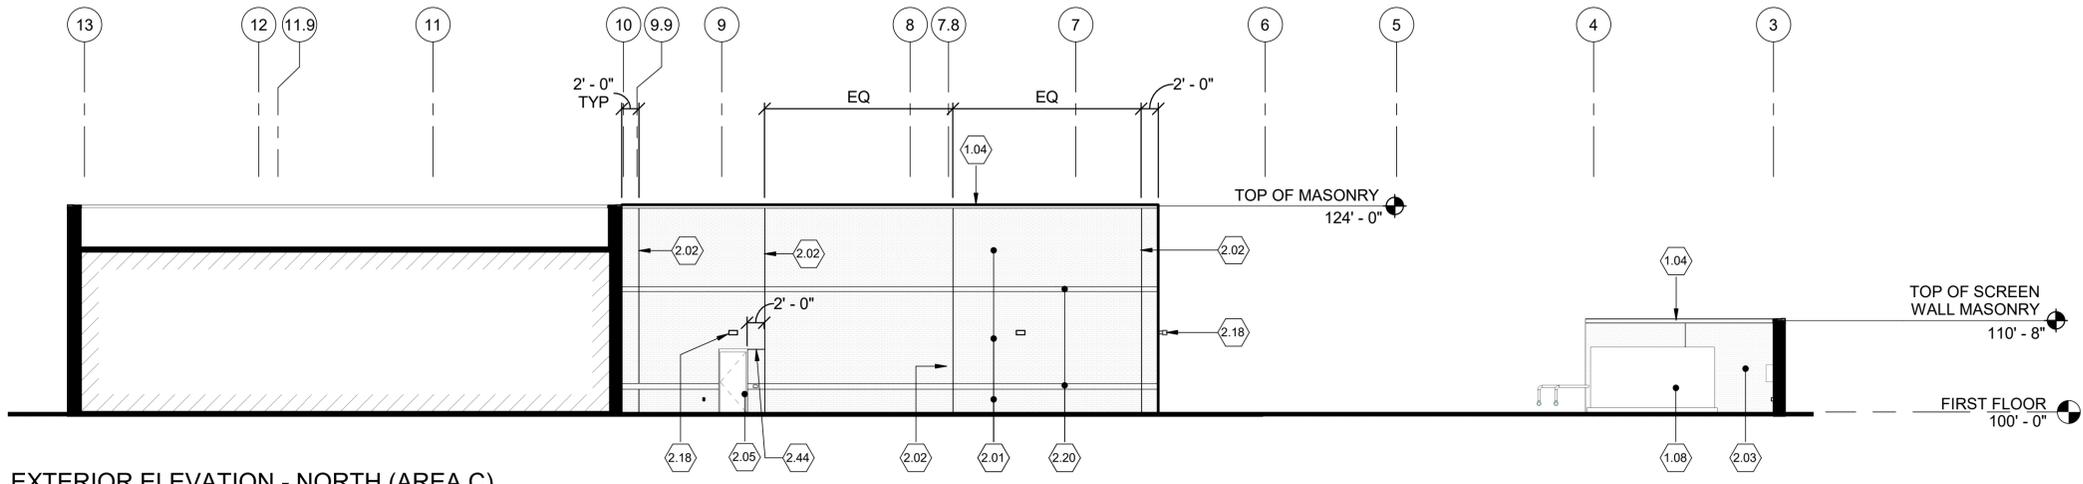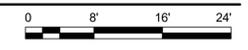


A3 EXTERIOR ELEVATION - NORTH (AREA C)
SCALE: 3/32" = 1'-0"

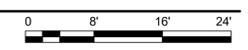


READY-TO-ADVERTISE (RTA) SUBMITTAL

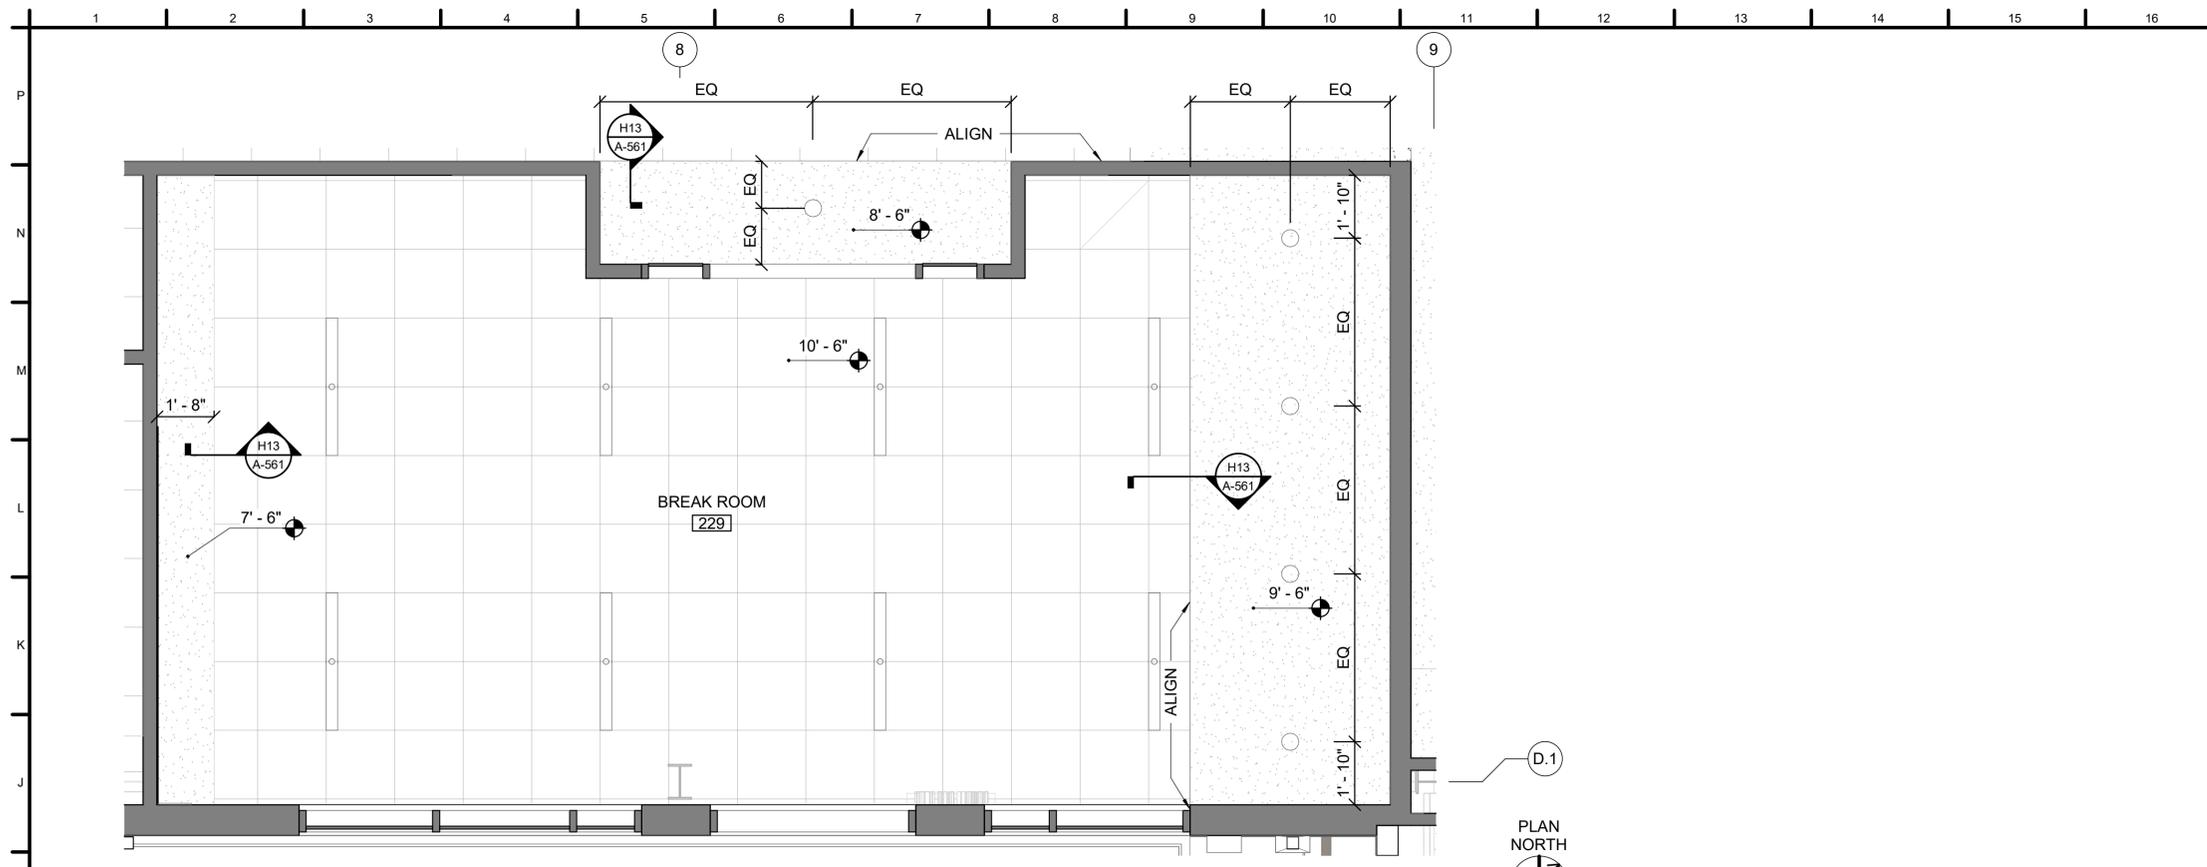

H1 ENLARGED REFLECTED CEILING PLAN - BREAKROOM 229
SCALE: 3/8" = 1'-0"

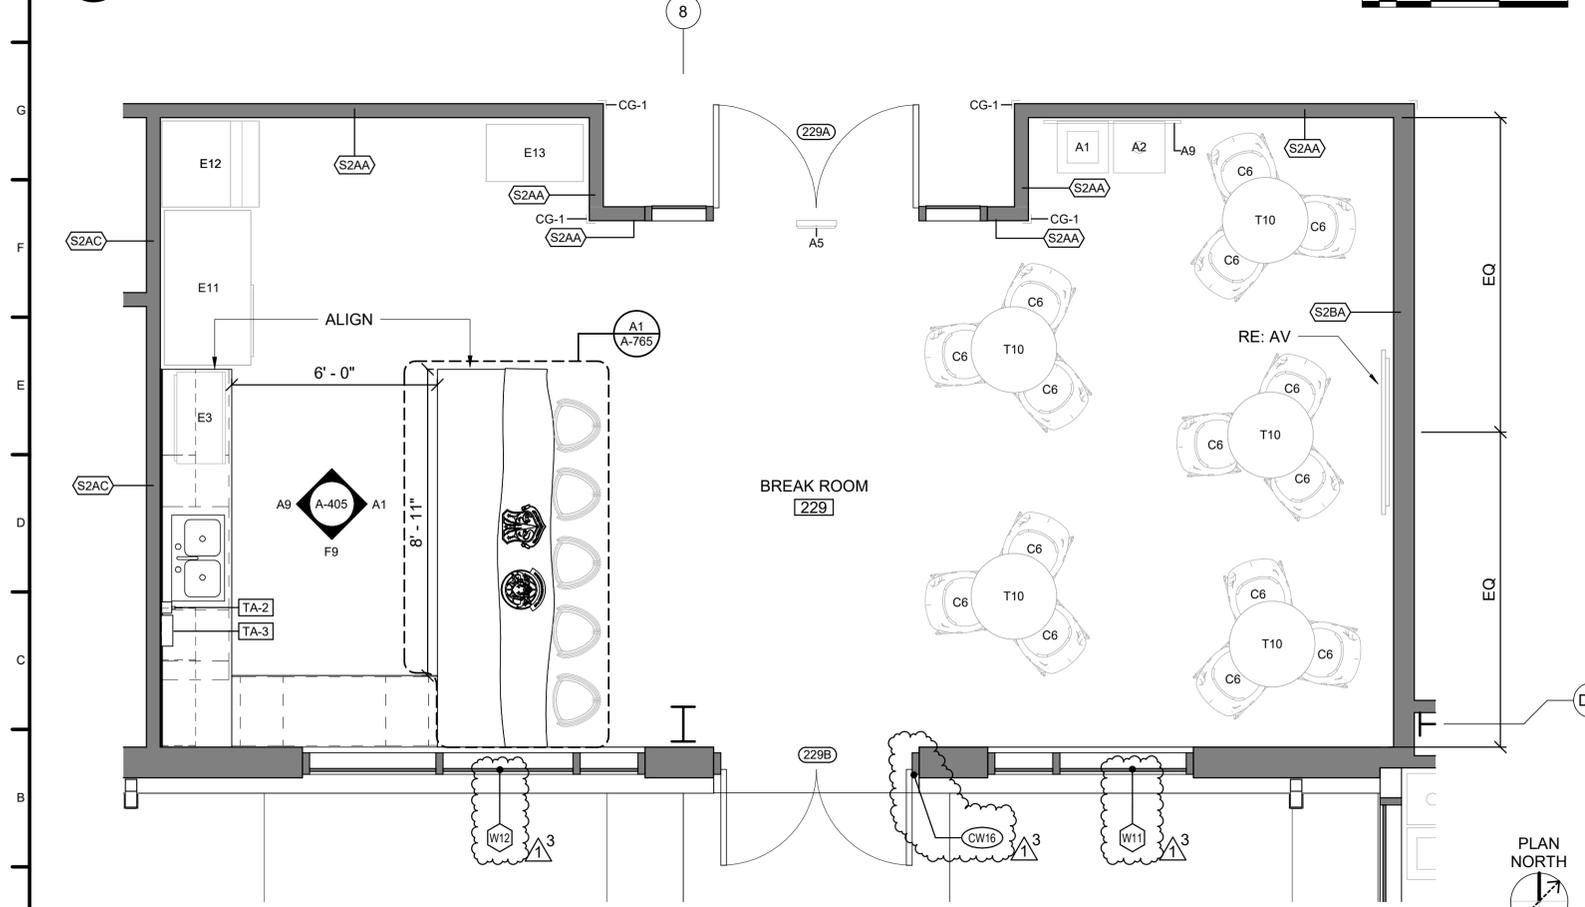

A1 ENLARGED FLOOR PLAN - BREAKROOM 229
SCALE: 3/8" = 1'-0"

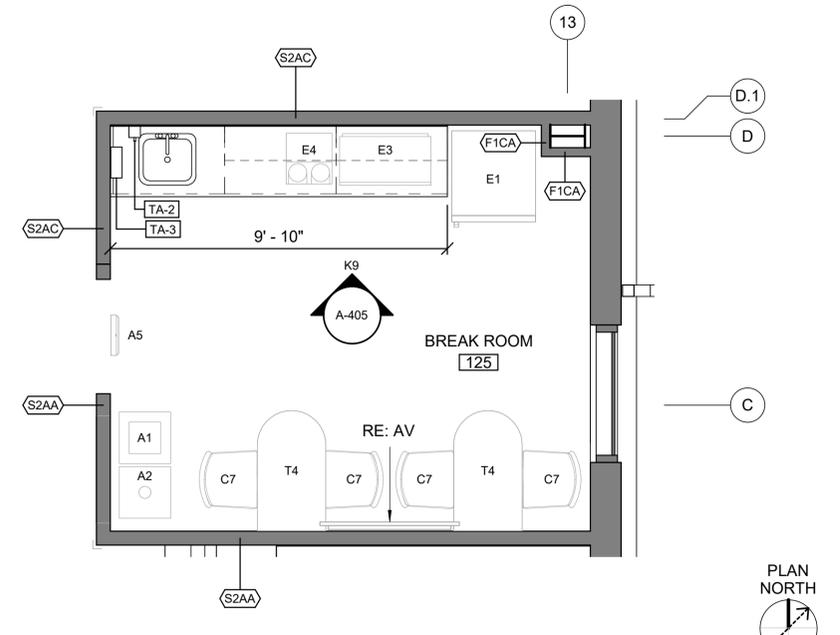

A12 ENLARGED FLOOR PLAN - BREAK ROOM 125
SCALE: 3/8" = 1'-0"

GENERAL SHEET NOTES

1. REFER TO ROOM FINISH SCHEDULE FOR GENERAL NOTES.
2. REFER TO ROOM FINISH SCHEDULE, FINISH PLANS AND FINISH LEGEND FOR ADDITIONAL INTERIOR FINISH PLACEMENTS.
3. REFER TO A-766 FOR WALL AND FLOOR TRANSITION DETAILS.
4. REFER TO FURNITURE PLANS, I-101 THROUGH I-103, FOR FURNITURE AND EQUIPMENT SHOWN.
5. REFER TO STRUCTURAL INTERIOR DESIGN BINDER FOR WC-1 GRAPHIC IMAGERY.
6. REFER TO OVERALL REFLECTED CEILING PLAN SHEETS FOR CEILING PLAN LEGEND AND GENERAL NOTES.
7. REFER TO SHEET A-003 FOR MOUNTING HEIGHTS AND ACCESSIBLE INFORMATION.
8. ALL AIRCRAFT IMAGERY SHOWN MUST BE CONFIRMED TO BE AN F-35A BY COR.
9. LAYOUTS OF VAULTS 1 AND 2 ARE IDENTICAL.

TOILET ACCESSORY LEGEND

MARK	DESCRIPTION
TA-1	MIRROR (LENGTH TO MATCH COUNTER)
TA-2	SOAP DISPENSER
TA-3	PAPER TOWEL DISPENSER
TA-4	COMBINATION PAPER TOWEL AND WASTE (RECESSED)
TA-5	TOILET SEAT COVER DISPENSER
TA-6	SANITARY NAPKIN DISPOSAL
TA-7	MULTI-ROLL TOILET TISSUE DISPENSER
TA-8	ABA GRAB BARS
TA-9	FULL LENGTH MIRROR
TA-10	MIRROR (33" x 56")
TA-11	ABA SHOWER GRAB BARS
TA-14	ROBE HOOK
TA-15	SHOWER CURTAIN, ROD AND RINGS
TA-16	UTILITY SHELF
TA-17	MIRROR (30" X 48")
TA-18	PAIR OF GRAB BARS 36" LONG AND 30" LONG




MARK	DESCRIPTION	DATE
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0	READY TO ADVERTISE (RTA) SUBMITTAL	JUL 2026

DESIGNED BY: S. KRISHAN	ISSUE DATE: JUL 2025
DRAWN BY: R. MANSELL	SOLICITATION NO.: W9127S25RA001
CHECKED BY: E. ALLEN	CONTRACT NO.: W9127S24F007
SUBMITTED BY: B. STREIBIN	FILE NAME: 165438 ARCH R22 1.rvt
ANSI D:	165438 ARCH R22 1.rvt

US ARMY CORPS OF ENGINEERS
LITTLE ROCK DISTRICT
LITTLE ROCK, ARKANSAS

BURNS AND McDONNELL
KANSAS CITY, MO 64114
165438

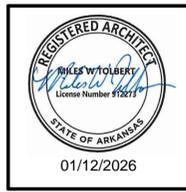


F-35: SPECIAL ACCESS PROGRAM FACILITY
EBBING AIR NATIONAL GUARD BASE (ANGB), FORT SMITH, ARKANSAS

ENLARGED BREAKROOM FLOOR PLANS


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READY-TO-ADVERTISE (RTA) SUBMITTAL

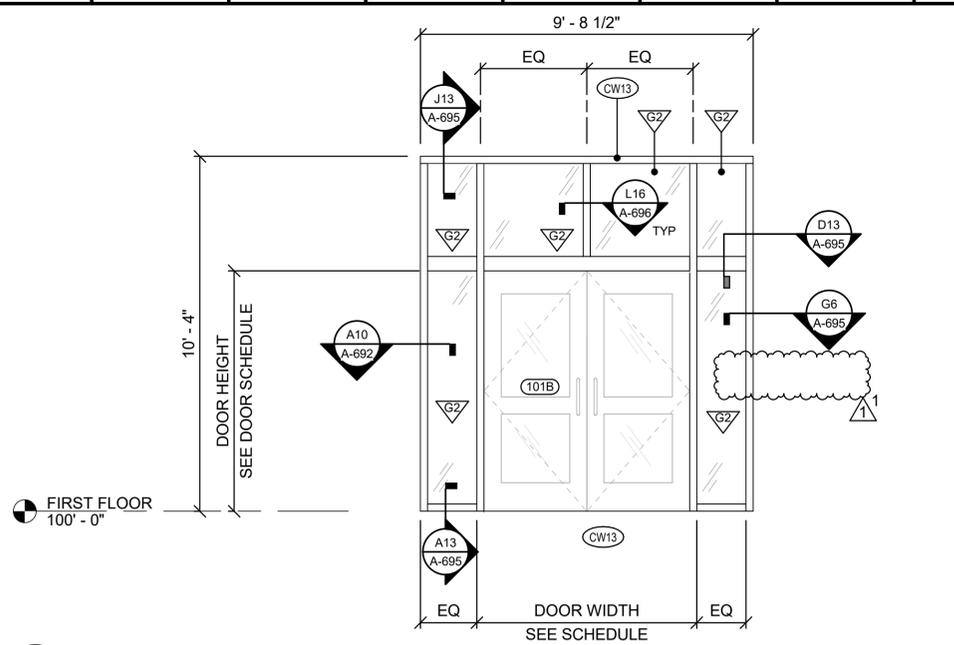



K2 CW13 ELEVATION

SCALE: 3/8" = 1'-0"

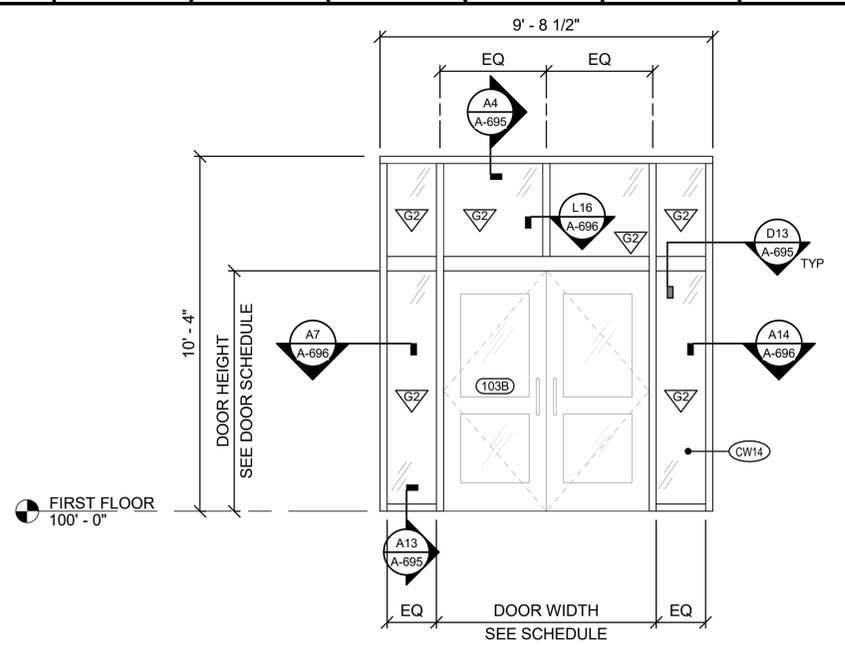


K10 CW14 ELEVATION

SCALE: 3/8" = 1'-0"

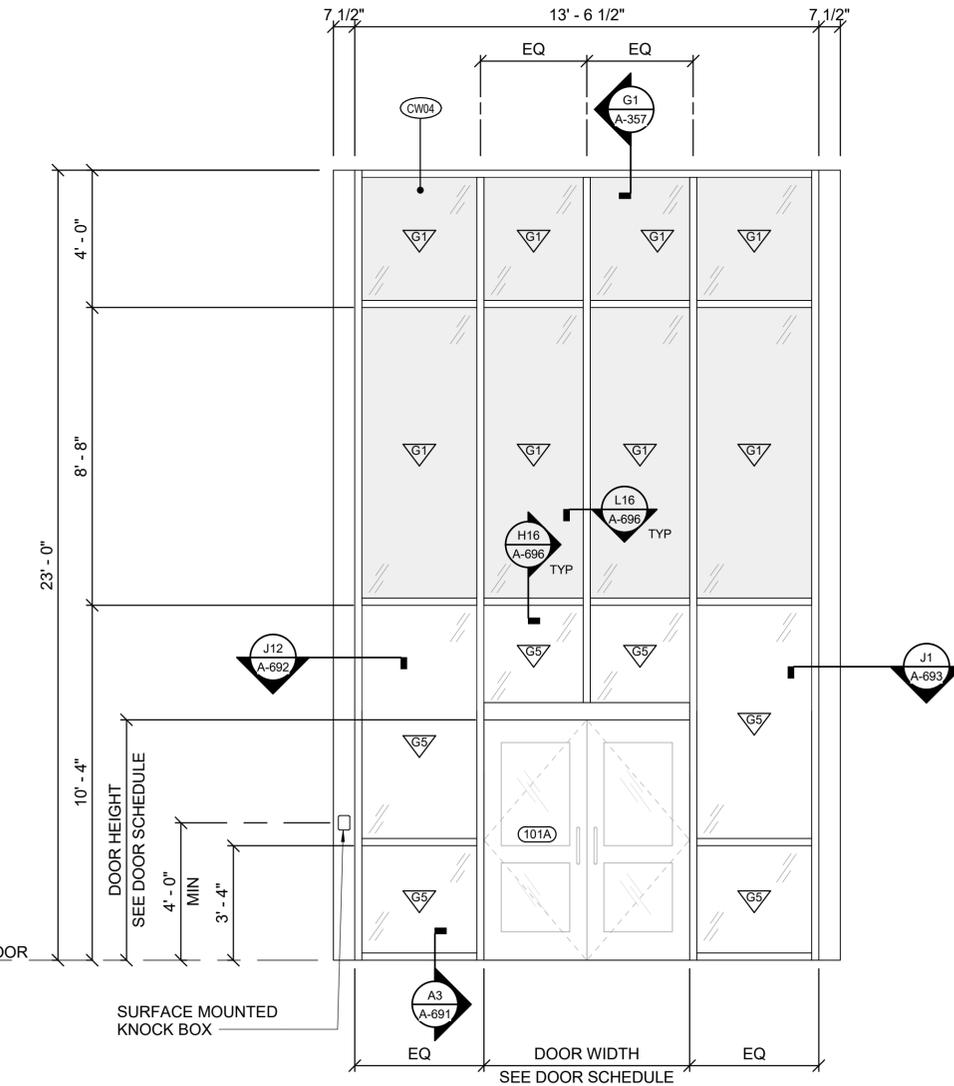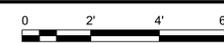


A1 CW04 ELEVATION

SCALE: 3/8" = 1'-0"

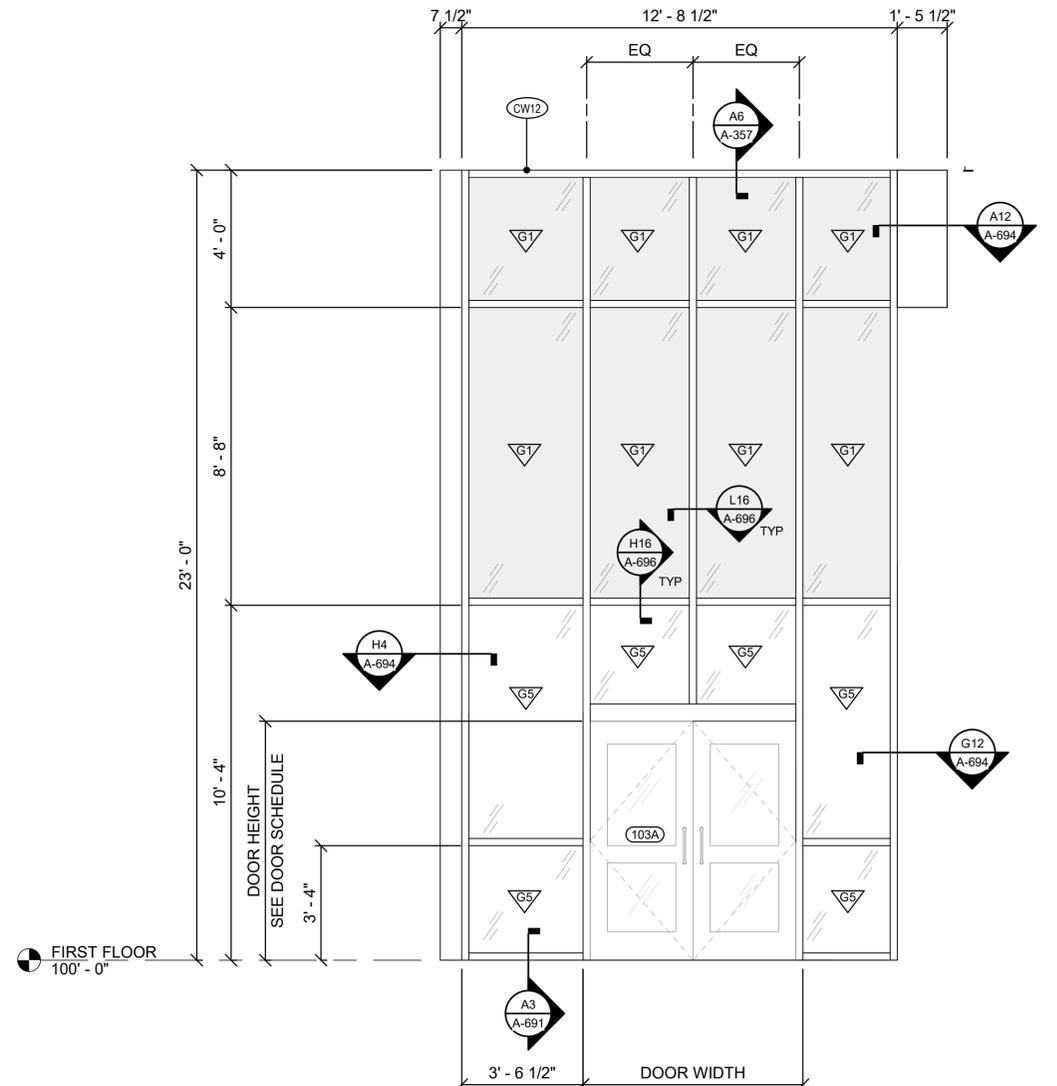

A10 CW12 ELEVATION

SCALE: 3/8" = 1'-0"

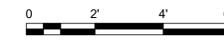

LEGEND

GLASS TYPES

REFERENCE SPECIFICATION 08 81 00 FOR SYSTEM TYPES

- G1 INSULATED GLASS UNIT (TINTED - FRITTED)
- G2 CLEAR INTERIOR GLASS
- G4 NOT USED
- G5 INSULATED GLASS UNIT (TINTED)



US Army Corps of Engineers

MARK	DESCRIPTION	DATE
1	AM 0003 - ADDED OR REVISED DETAIL CALL OUTS	JAN 2026
0	READY TO ADVERTISE (RTA) SUBMITTAL	JUL 2026

DESIGNED BY: M. LOBERT	ISSUE DATE: JUL 2025
DRAWN BY: R. NEDDO	SOLICITATION NO.: W9127S25RA001
CHECKED BY: B. MCKINNEY	CONTRACT NO.: W9127S24E007
SUBMITTED BY: B. STREIBIN	FILE NAME: 165438 ARCH - R22 - 1.rvt
ANSI D:	165438 ARCH - R22 - 1.rvt

US ARMY CORPS OF ENGINEERS
LITTLE ROCK DISTRICT
LITTLE ROCK, ARKANSAS

BURNS AND McDONNELL
KANSAS CITY, MO 64114
165438



F-35: SPECIAL ACCESS PROGRAM FACILITY
EBBING AIR NATIONAL GUARD BASE (ANGB), FORT SMITH, ARKANSAS

CURTAIN WALL ELEVATIONS

SHEET ID
A-683.1

READY-TO-ADVERTISE (RTA) SUBMITTAL

1 2 3 4 5 6 7 8 9 10 11 12 13 14 15 16 17 18 19 20

P
N
M
L
K
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C
B
A

LEGEND

- ▽ GLASS TYPES**
 REFERENCE SPECIFICATION 08 81 00 FOR SYSTEM TYPES
 G1 INSULATED GLASS UNIT (TINTED - FRITTED)
 G2 CLEAR INTERIOR GLASS
 G4 NOT USED
 G5 INSULATED GLASS UNIT (TINTED)



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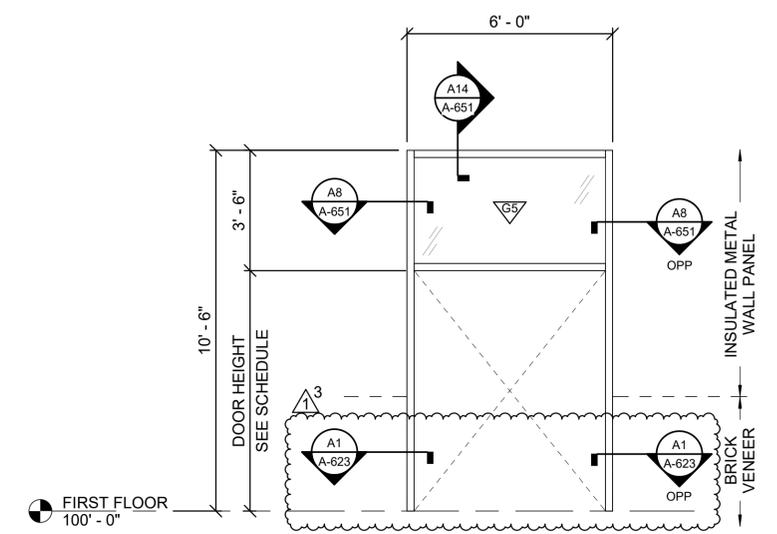
MARK	DESCRIPTION	DATE
1	AM 0003 - ADDED OR REVISED DETAIL CALL OUTS	JAN 2026
0	READY TO ADVERTISE (RTA) SUBMITTAL	JUL 2026

DESIGNED BY: M. TOUBERT	ISSUE DATE: JUL 2025
DRAWN BY: R. NEDDO	SOLICITATION NO.: W9127S25RA001
CHECKED BY: B. MCKINNEY	CONTRACT NO.: W9127S24F0007
SUBMITTED BY: B. STREIBIN	FILE NAME: 165438 ARCH - R22 - 1.rvt
ANSI D:	165438 ARCH - R22 - 1.rvt


US ARMY CORPS OF ENGINEERS LITTLE ROCK DISTRICT LITTLE ROCK, ARKANSAS	BURNS AND McDONNELL KANSAS CITY, MO 64114 165438
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F-35: SPECIAL ACCESS PROGRAM FACILITY EBBING AIR NATIONAL GUARD BASE (ANGB), FORT SMITH, ARKANSAS	CURTAIN WALL ELEVATIONS
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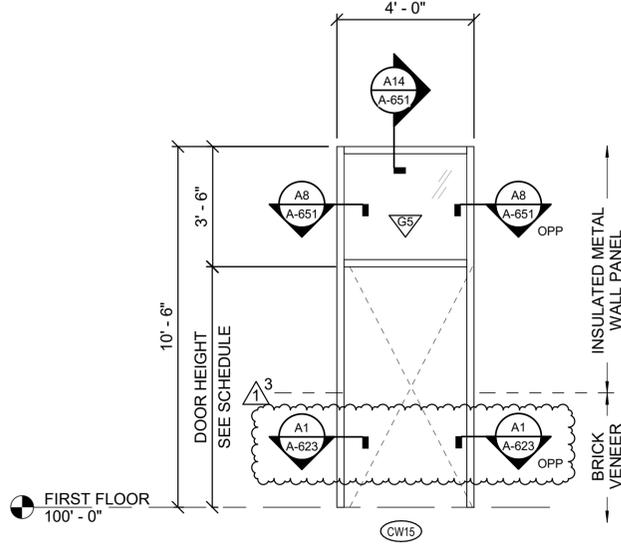
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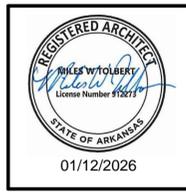
H14 CW16 - CURTAIN WALL ELEVATION
SCALE: 3/8" = 1'-0"




A8 CW17 - CURTAIN WALL ELEVATION
SCALE: 3/8" = 1'-0"



A15 CW15 - CURTAIN WALL ELEVATION
SCALE: 3/8" = 1'-0"

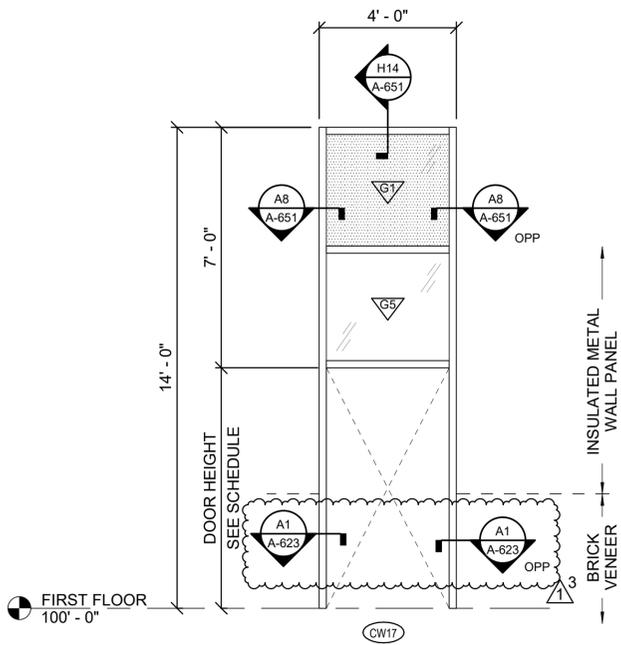

READY-TO-ADVERTISE (RTA) SUBMITTAL

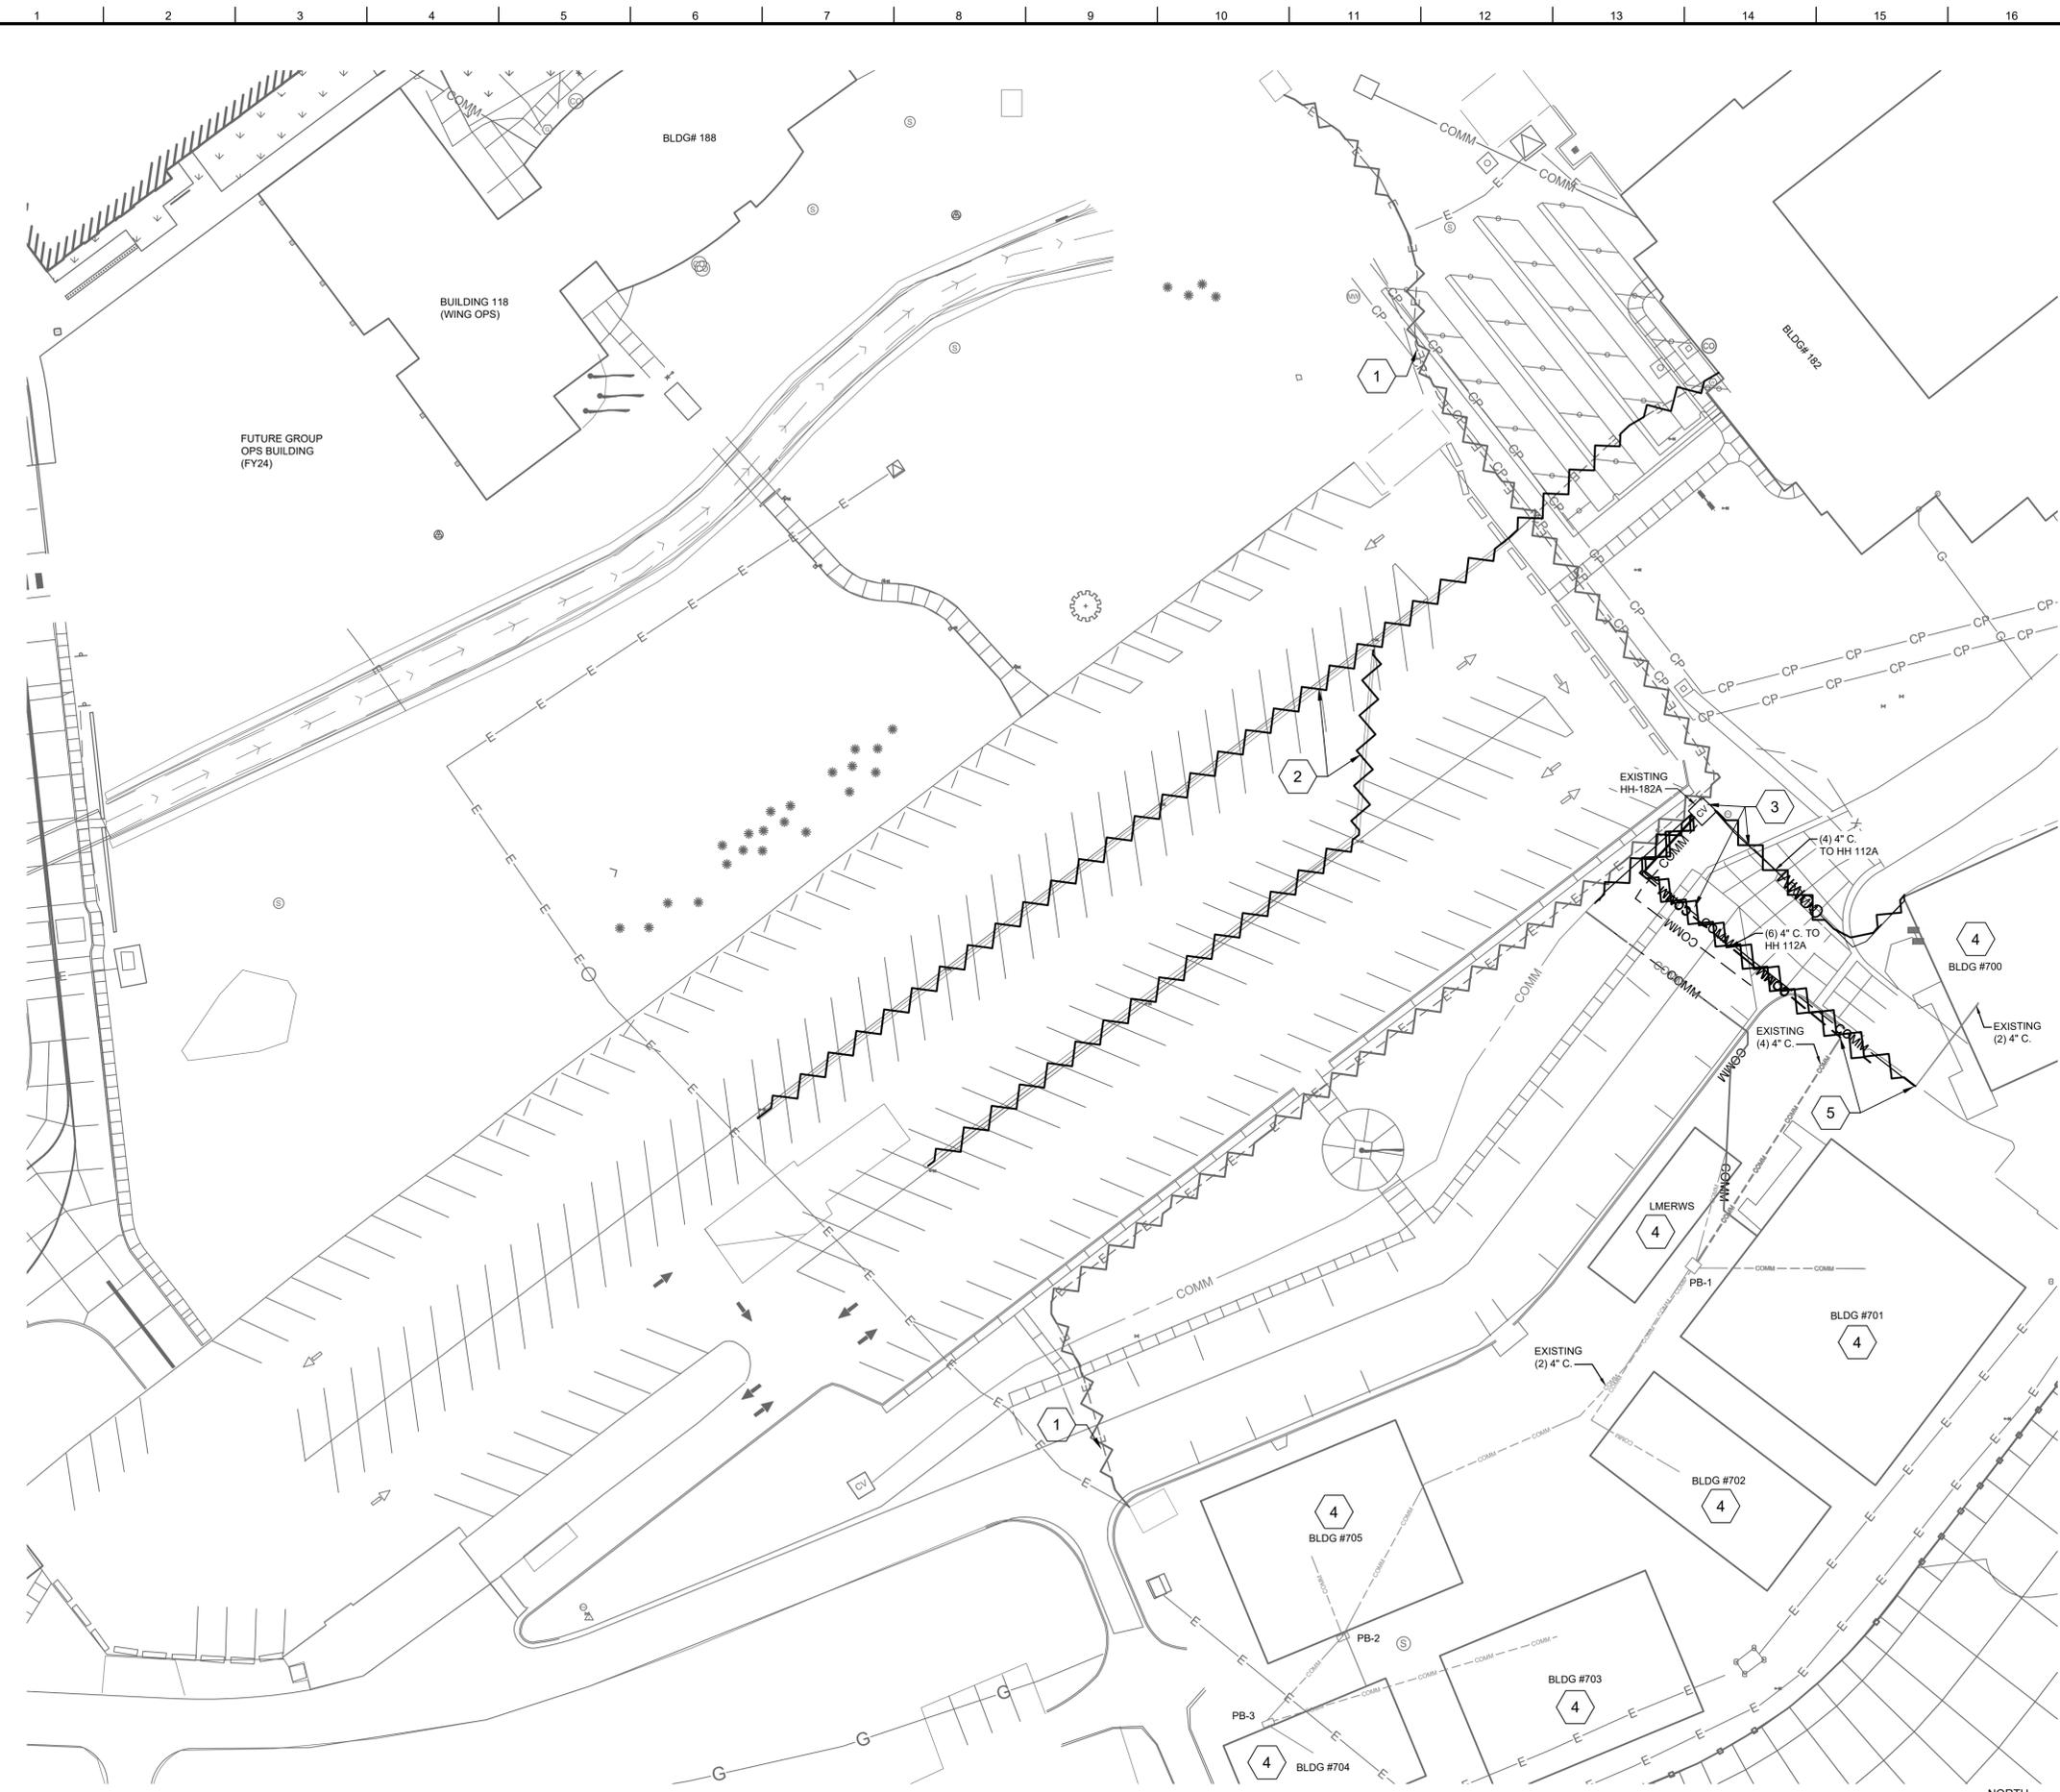

A1 ENLARGED ELECTRICAL DEMOLITION SITE PLAN - 1
SCALE: 1"=30'

GENERAL SHEET NOTES

1. REFER TO ES001 FOR ELECTRICAL GENERAL NOTES, LEGEND AND ABBREVIATIONS.
2. NOT ALL UTILITIES ARE LOCATED ON THE PLANS. LOCATE ALL UTILITIES PRIOR TO WORK.
3. THE CONTRACTING OFFICER MUST BE NOTIFIED PRIOR TO STARTING ANY DEMOLITION WORK.
4. ALL WORK MUST BE PERFORMED IN ACCORDANCE WITH CIVIL PHASING PLANS. SEE GC SERIES SHEETS.
5. REFER TO TN001 FOR TELECOMM OUTSIDE PLANT GENERAL NOTES.

SHEET KEYNOTES


1. UNDERGROUND PRIMARY DUCT BANK DEMOLITION BY OG&E.
2. DISCONNECT AND REMOVE EXISTING UNDERGROUND BRANCH CIRCUIT/FEEEDER. DEMOLISH BACK TO SOURCE. DEMOLISH LIGHT POLES ALONG DEMOLISHED BRANCH CIRCUIT REFER TO CIVIL DEMO DRAWINGS FOR LIGHT POLE LOCATIONS.
3. AFTER COMPLETION OF NEW WORK (REFER TO ES116); DEMOLISH EXISTING COMMUNICATION CONDUIT INFRASTRUCTURE AS REQUIRED INCLUDING EXISTING HH-182A TO EXTENTS INDICATED. REFER TO CIVIL DEMOLITION DRAWINGS FOR ADDITIONAL INFORMATION.
4. DEMO EXISTING FIBER OPTIC CABLES SERVING TEMPORARY FACILITIES 700, 701, 702, 703, 704, AND 705. EXISTING CONDUIT INFRASTRUCTURE TO REMAIN WHERE INDICATED. REFER TO ES116 FOR ADDITIONAL INFORMATION.
5. APPROXIMATE ROUTING OF TEMPORARY FACILITIES COMM. DUCTBANKS. CONTRACTOR SHALL FIELD VERIFY PRIOR TO COMMENCEMENT OF WORK.

LEGEND

- E---E--- EXISTING UNDERGROUND ELECTRICAL - PRIMARY FEED
- COMM --- EXISTING COMMUNICATIONS
- ES---ES--- EXISTING UNDERGROUND ELECTRICAL - SECONDARY FEED
- ~~~~~ EXISTING UNDERGROUND ELECTRICAL - PRIMARY FEED TO BE DEMOED
- ~~~~~ EXISTING COMMUNICATIONS TO BE DEMOED
- ~~~~~ EXISTING UNDERGROUND ELECTRICAL - SECONDARY FEED TO BE DEMOED

Professional Engineer
I hereby certify that this plan, specification, or report was prepared by me or under my direct supervision and that I am a duly Licensed Professional Engineer under the laws of the state of Minnesota.
Signature: *Dugan Bradley*
Typed or Printed Name: DUGAN BRADLEY
Date: 01/13/26 License Number: 618689

KEY PLAN

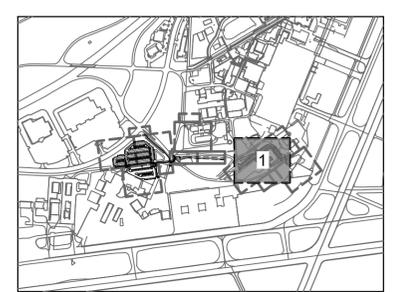

US Army Corps of Engineers

MARK	DESCRIPTION	DATE
1	AM0003 - COMM CONDUIT DEMO CLARIFICATION	JAN 2026
0	READY-TO-ADVISE (RTA) SUBMITTAL	JUL 2025

DESIGNED BY: D. BRADLEY	ISSUE DATE: JUL 2025
CHECKED BY: S. YUNKER	SOFT COPY DATE: W9127S24R400
SUBMITTED BY: B. STREIBIN	CONTRACT NO.:W9127S24F007
FILE NAME: 16543ED111.dwg	SIZE:

US ARMY CORPS OF ENGINEERS
LITTLE ROCK DISTRICT
LITTLE ROCK, ARKANSAS

BURNS AND McDONNELL
9400 WARD PARKWAY,
KANSAS CITY, MO, 64114
16543-06

F-35: SPECIAL ACCESS PROGRAM FACILITY
EBBING AIR NATIONAL GUARD BASE (ANGB), FORT SMITH, ARKANSAS

ENLARGED ELECTRICAL DEMOLITION SITE PLAN - 1

SHEET ID
ED111.1

READY-TO-ADVISE (RTA) SUBMITTAL