



Z:\20\2020043 ROGERS SOLIDS HANDLING IMPROVEMENTS, PH 2\DRAWINGS\CONSTRUCTION DRAWINGS\WIP\C-07.DWG, 8/26/2024 11:07 AM, MATT WEIR, LAYOUT1

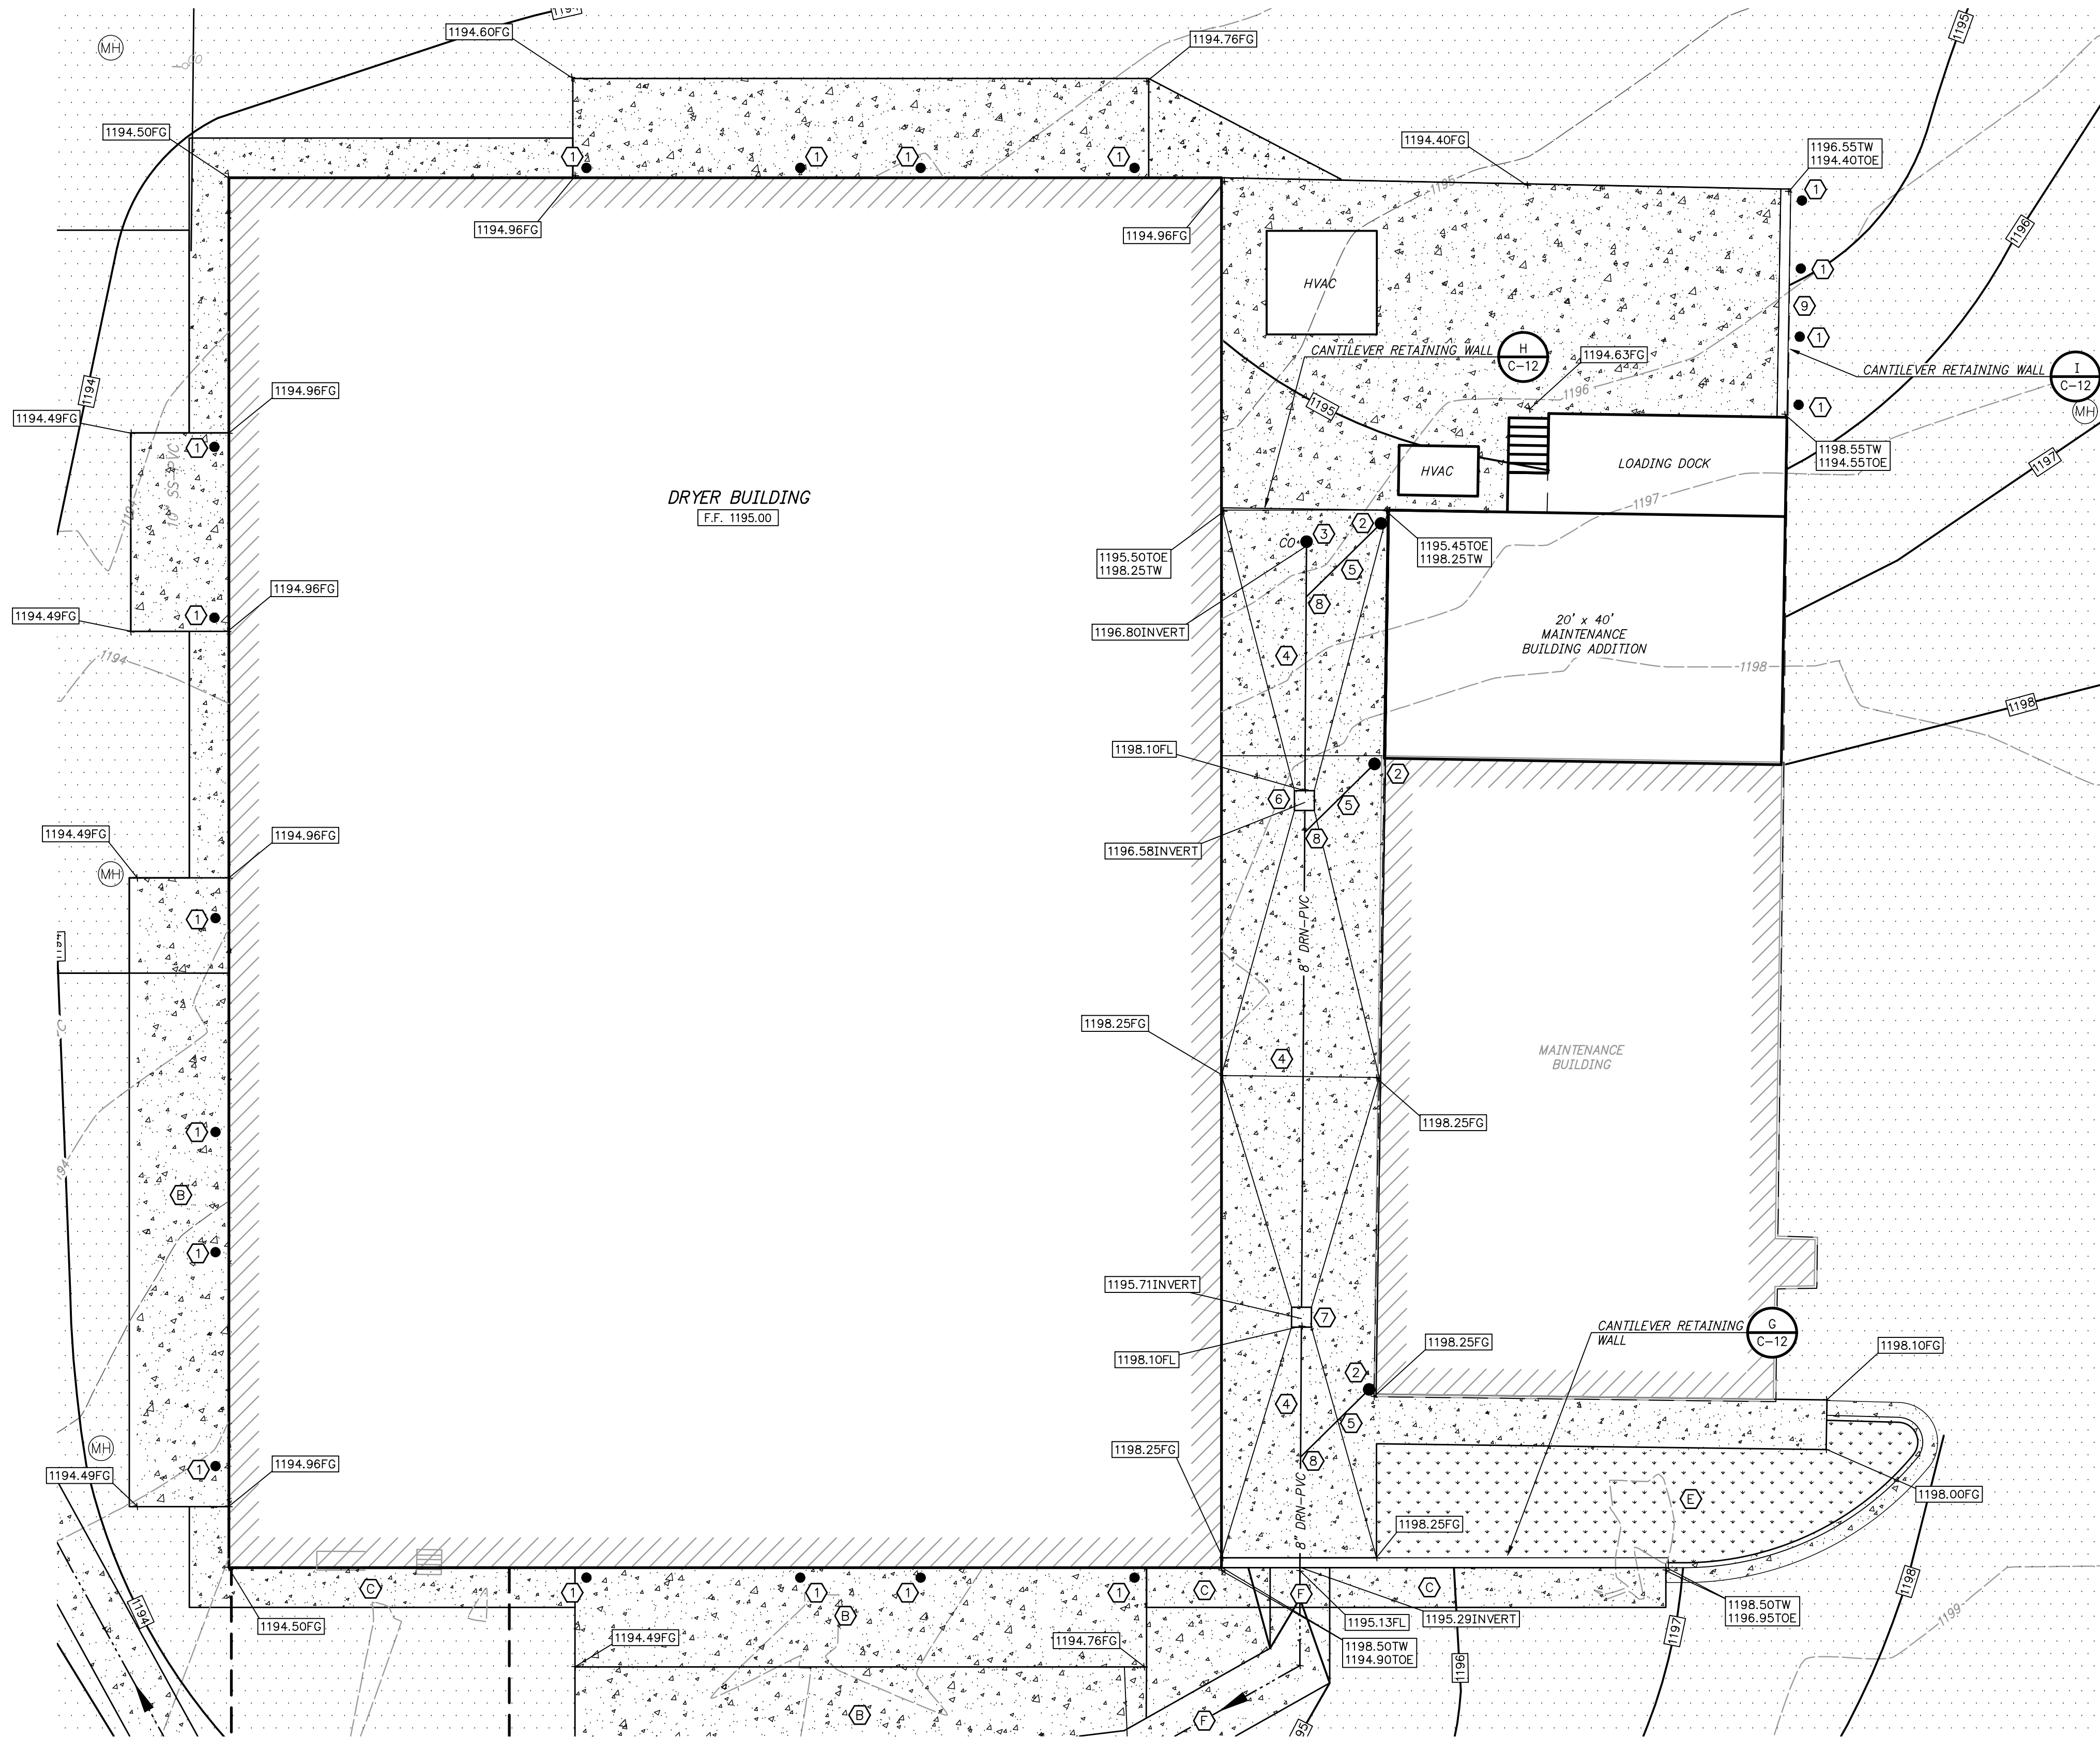

GRADING AND PAVING PLAN

DETAIL F
1"=10'

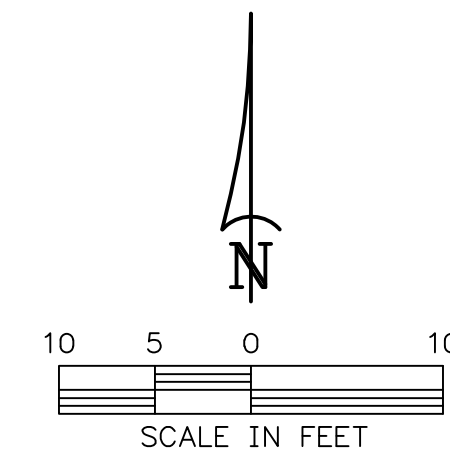

KEYED PAVEMENT AND SITE RESTORATION TYPES:

- (A) GRAVEL DRIVE C207
- (B) CONCRETE PAVEMENT C203
- (C) CONCRETE SIDEWALK C202, C206
- (D) ASPHALT PAVEMENT C210
- (E) SOLID SOD
- (F) CONCRETE SWALE C302

LEGEND:

- 1197--- EXISTING CONTOUR
- 1197--- PROPOSED FINISH CONTOUR

KEYED NOTES:

- 1 FURNISH AND INSTALL GUARD POST.
- 2 FURNISH AND INSTALL PVC DOWNSPOUT ADAPTER.
- 3 FURNISH AND INSTALL CLEANOUT.
- 4 FURNISH AND INSTALL 8" PVC DRAIN PIPE.
- 5 FURNISH AND INSTALL 4" PVC DRAIN PIPE ON 1.3% SLOPE.
- 6 FURNISH AND INSTALL 2' x 2' CATCH BASIN WITH CAST IRON GRATE.
- 7 FURNISH AND INSTALL 2' x 2' CATCH BASIN WITH CAST IRON GRATE WITH CATCH BASIN EXTENSION.
- 8 FURNISH AND INSTALL 8" x 4" SERVICE WYE.
- 9 THE EXPOSED SURFACE OF THE LOADING DOCK RETAINING WALL SHALL BE COATED WITH REFLECTIVE PAINT IN ACCORDANCE WITH THE SPECIFICATIONS.

1"
ONE INCH
AT FULL SIZE
IF NOT ONE INCH
SCALE ACCORDINGLY

DATE	REVISION



HW HAWKINS WEIR ENGINEERS, INC.
BLACK & VEATCH

ROGERS, ARKANSAS
ROGERS POLLUTION CONTROL FACILITY (PCF)
SOLIDS HANDLING IMPROVEMENTS, PHASE II
GRADING AND PAVING PLAN
FOR: ROGERS WATER UTILITIES

DATE: AUGUST 2024
SCALE: 1"=10'
DESIGNED BY: JDS
DRAWN BY: MAW
HWEI NO.: 2020043
FILENAME: C-07

SHEET NO.
C-7