
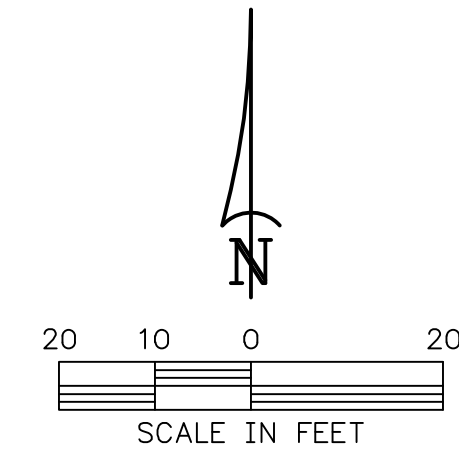


Z:\2020\2020043 ROGERS SOLIDS HANDLING IMPROVEMENTS, PH. 2\DRAWINGS\CONSTRUCTION DRAWINGS\WMP-C-03.DWG, 8/26/2024 11:06 AM, MATT WEIR, LAYOUT

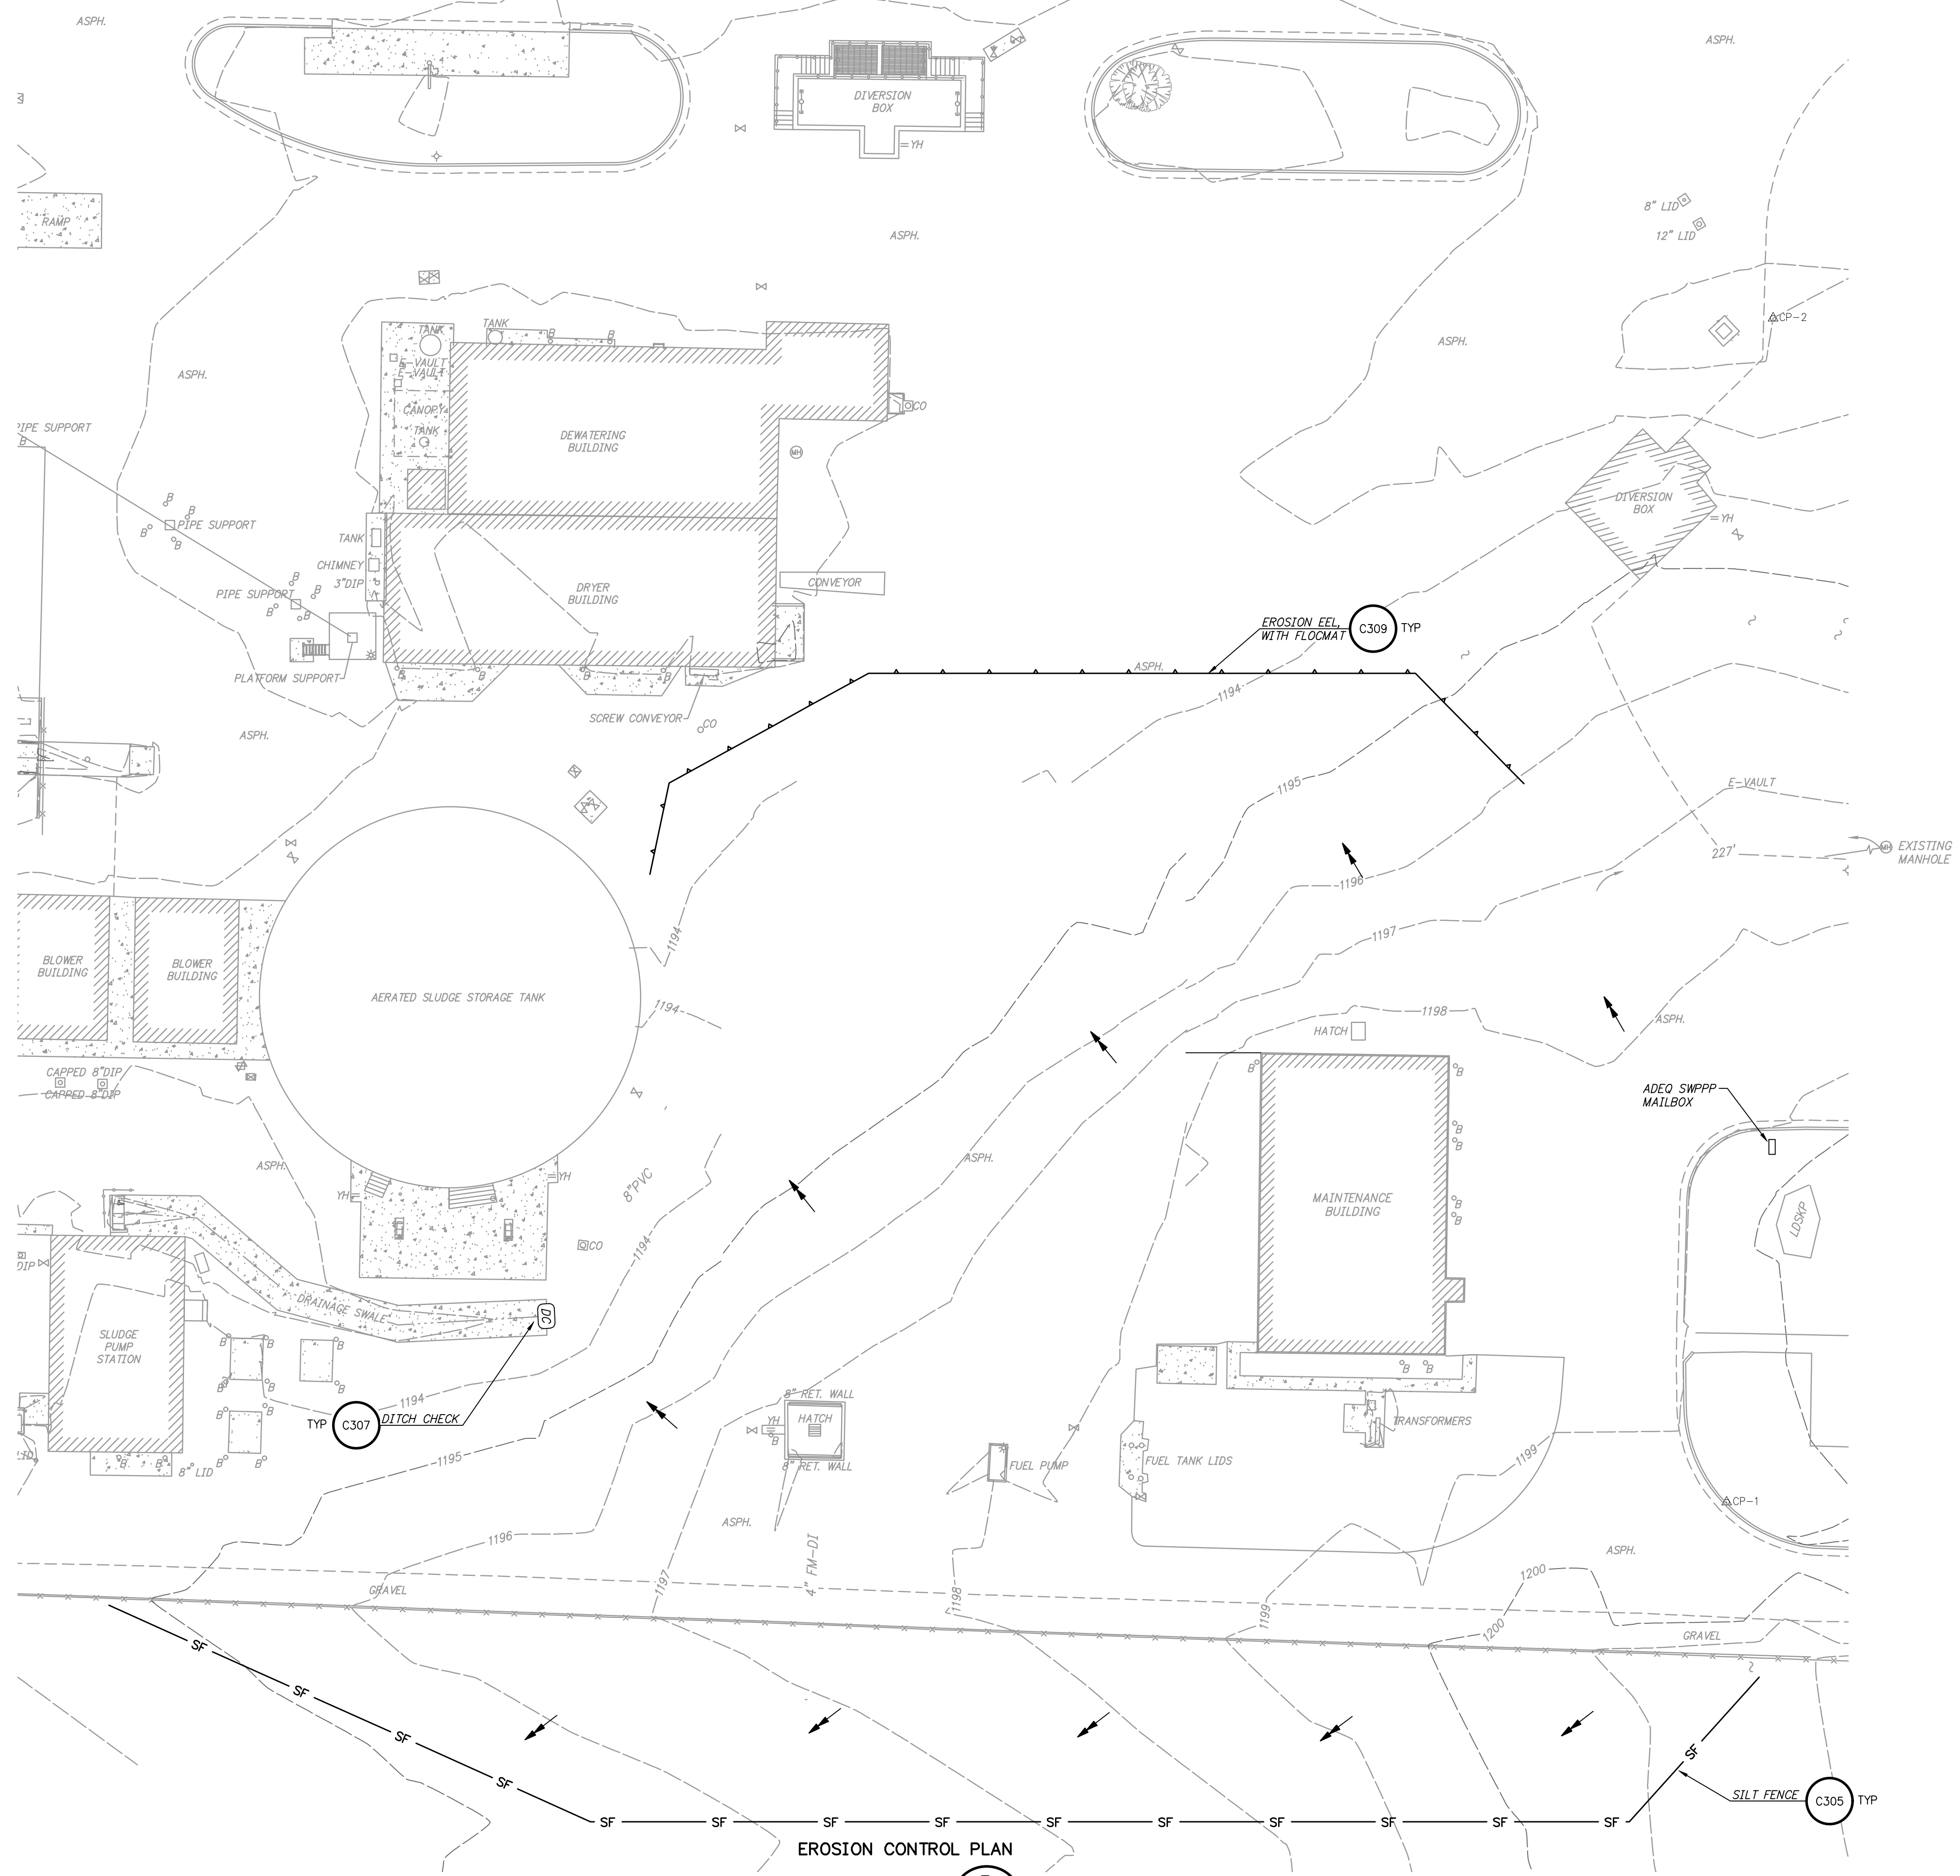

**LEGEND**

— W — W —	STRAW WATTLE	C308
— SF —	SILT FENCE	C305
→	DIRECTION OF STORMWATER FLOW	
(DC)	DITCH CHECK	C307
▲	TRIANGULAR SILT DIKE	C309
▨	STABILIZED CONSTRUCTION ENTRANCE	C306

- NOTES:**
1. INSTALL CONCRETE WASHOUT, LOCATION TO BE DETERMINED BY CONTRACTOR. (C310)
  2. INSTALL STABILIZED CONSTRUCTION ENTRANCE(S) AS NEEDED. LOCATION TO BE DETERMINED BY CONTRACTOR. (C306)
  3. THE CONTRACTOR SHALL BE RESPONSIBLE FOR EROSION CONTROL INSTALLATION AND MAINTENANCE.
  4. ADDITIONAL EROSION CONTROL MEASURES ARE INCLUDED ON SHEET CZ-3.

1" = 20'  
ONE INCH AT FULL SIZE IF NOT ONE INCH SCALE ACCORDINGLY

DATE	REVISION



**HAWKINS WEIR ENGINEERS, INC.**  
**BLACK & VEATCH**

ROGERS, ARKANSAS  
 ROGERS POLLUTION CONTROL FACILITY (PCF)  
 SOLIDS HANDLING IMPROVEMENTS, PHASE II  
**EROSION CONTROL PLAN AND DETAILS**  
 FOR: ROGERS WATER UTILITIES

DATE: AUGUST 2024  
 SCALE: 1"=20'  
 DESIGNED BY: JDS  
 DRAWN BY: MAW  
 HWEI NO.: 2020043  
 FILENAME: C-03

SHEET NO. **C-3**

**EROSION CONTROL PLAN**  
**DETAIL B**  
 1"=20'