



8/27/2024 11:14:55 AM / SJU / ELEVATIONS


Autodesk Docs: //406493 - Rogers PCF Solids Phase 2/406493-Maintenance Building-BVrvrt

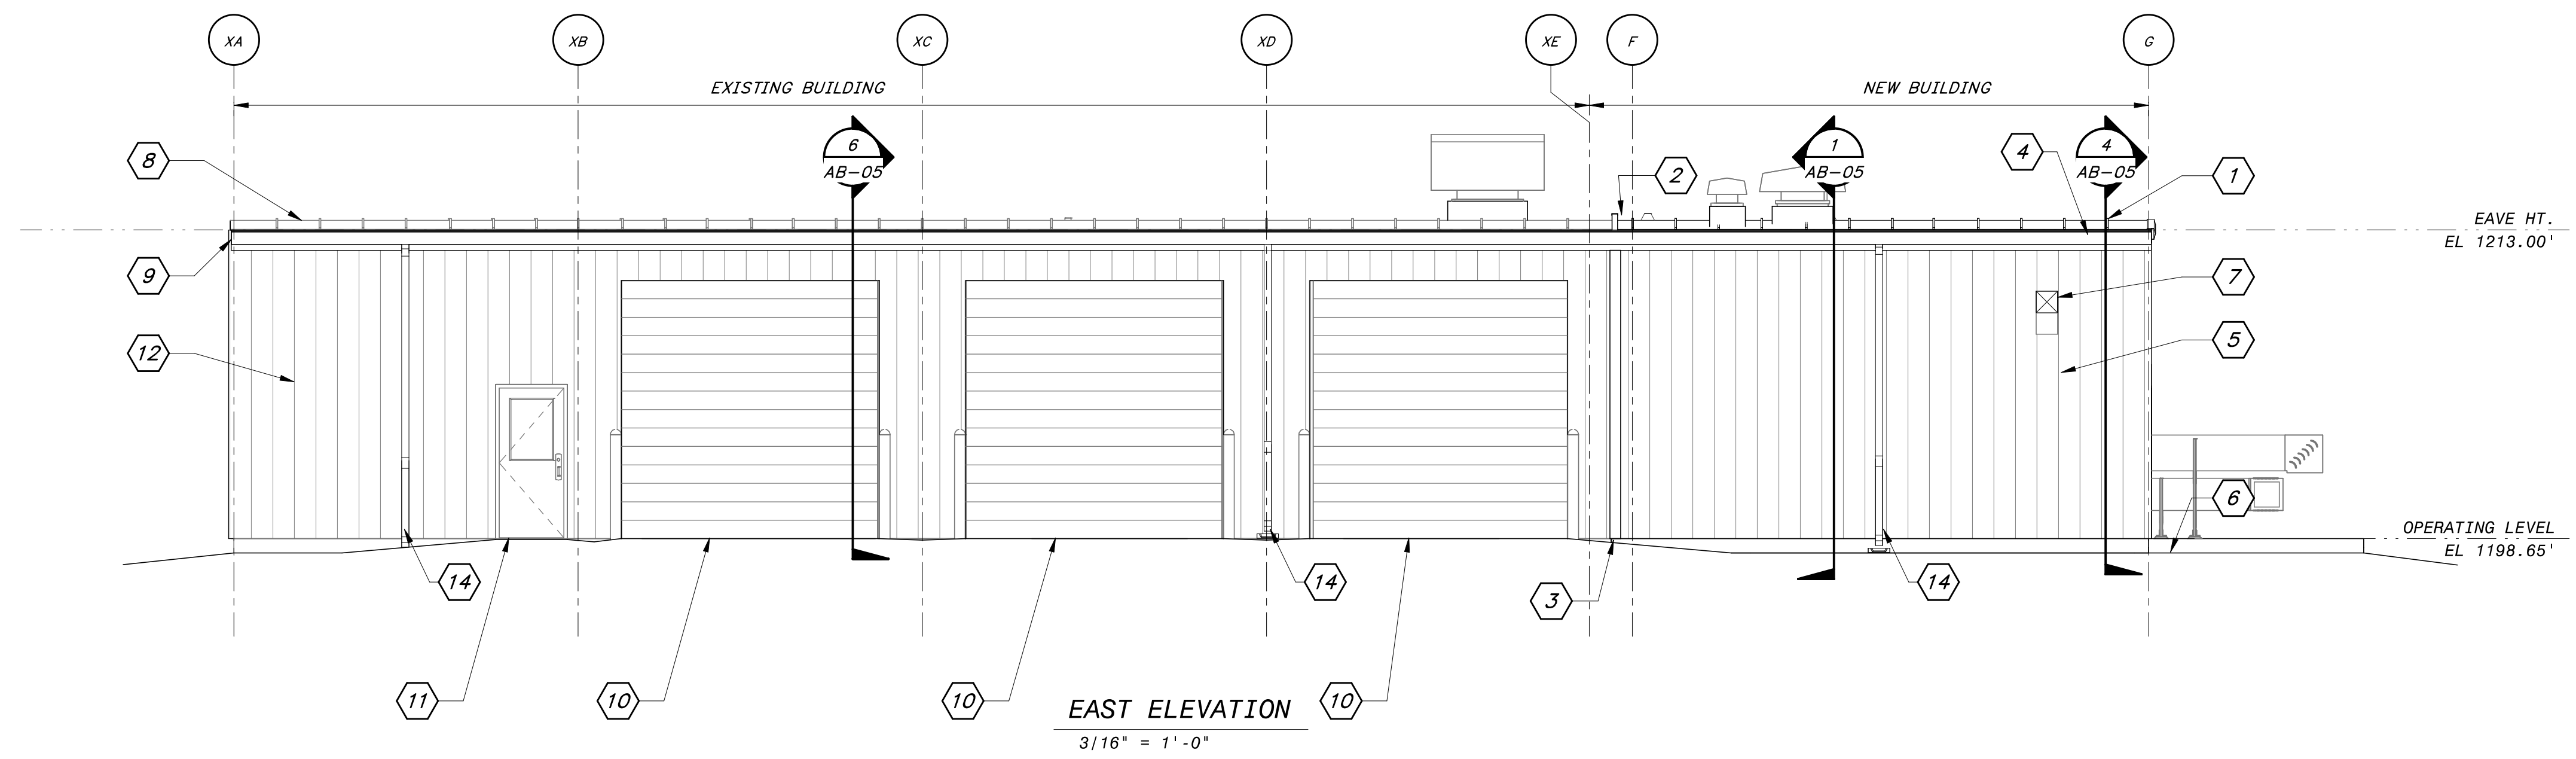


EAST ELEVATION
3/16" = 1'-0"

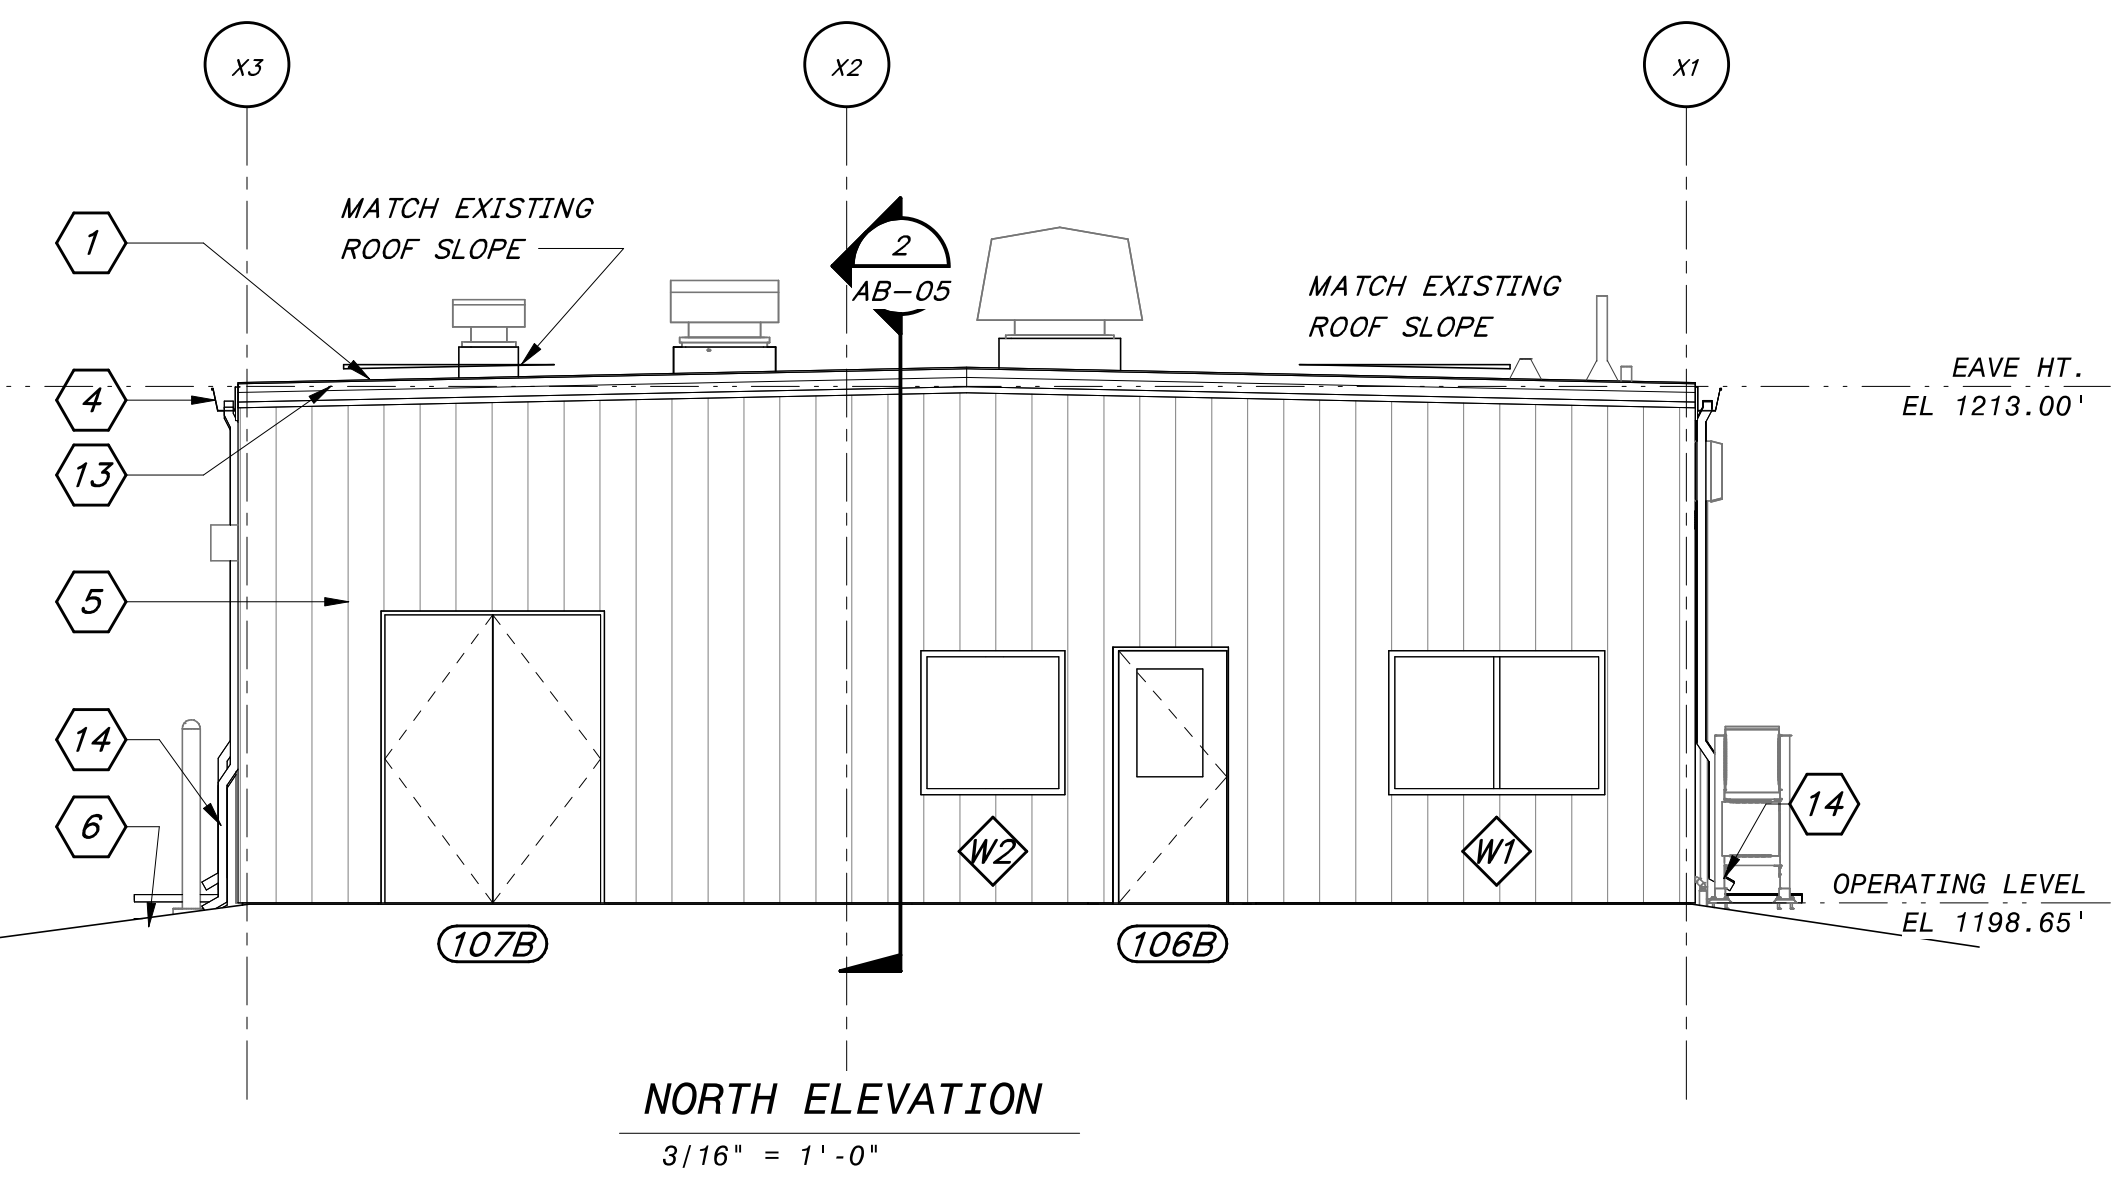

NORTH ELEVATION
3/16" = 1'-0"

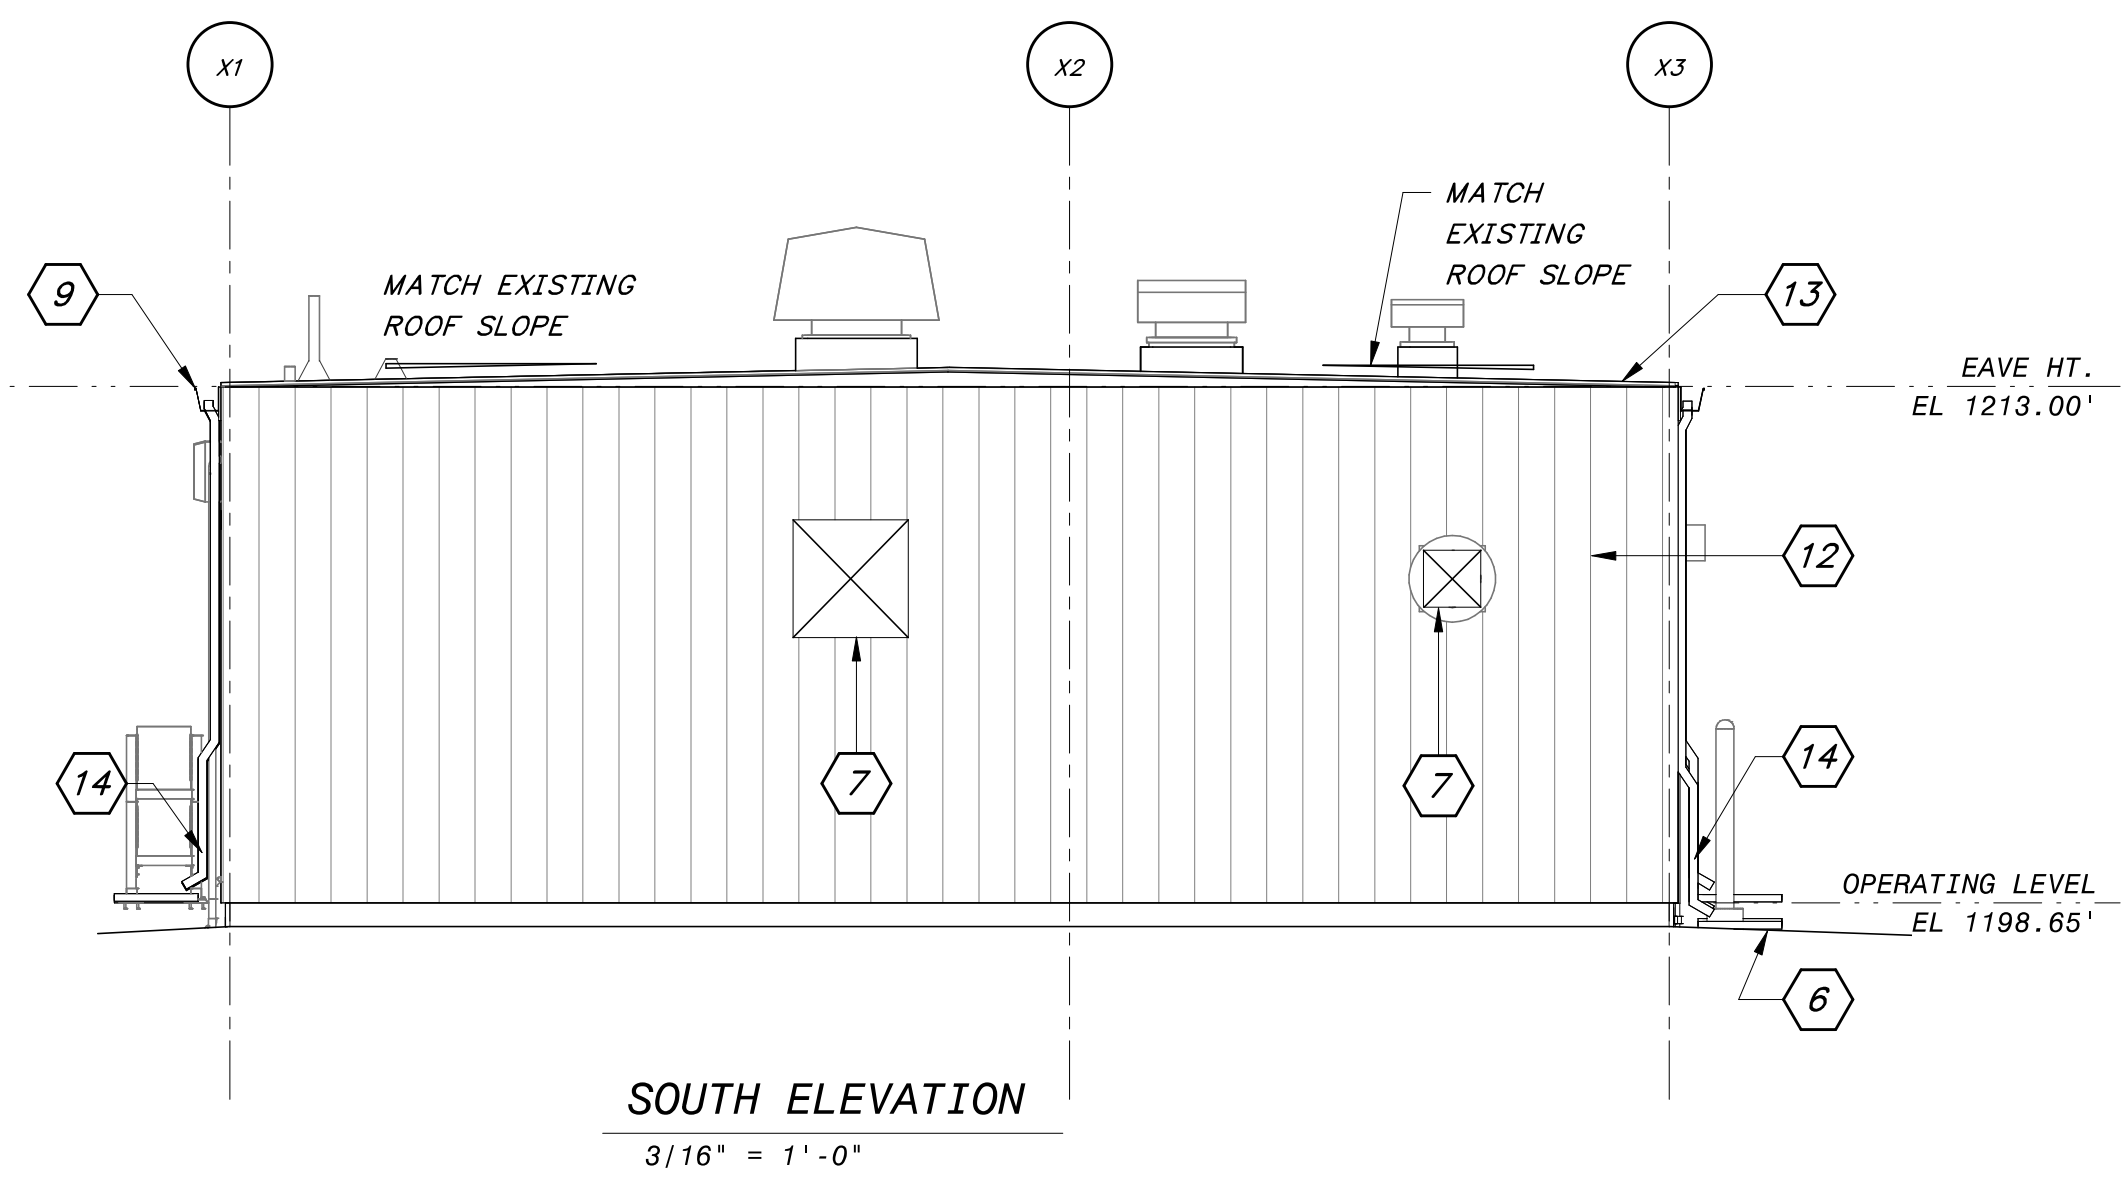


SOUTH ELEVATION
3/16" = 1'-0"

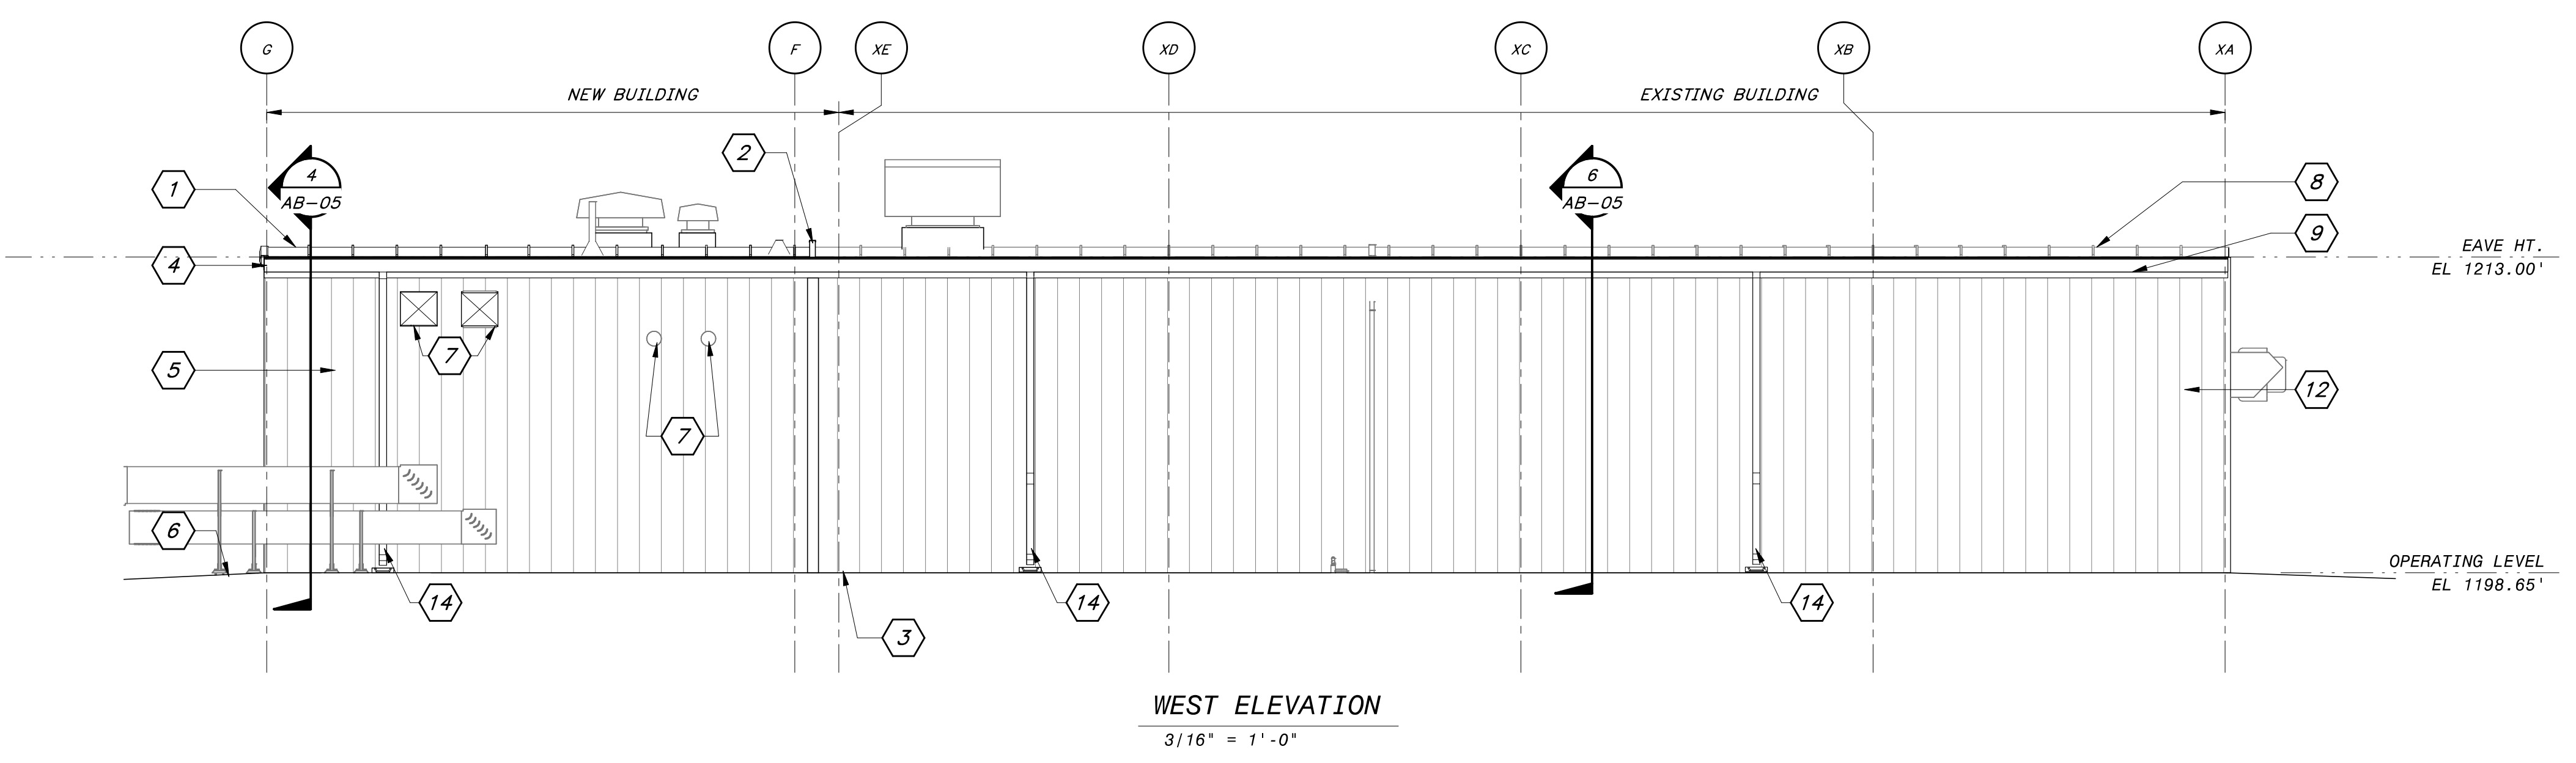


WEST ELEVATION
3/16" = 1'-0"

SHEET KEYNOTES	
1.	STANDING SEAM ROOFING BY PEMB FABRICATOR
2.	CURBED EXPANSION ROOF JOINT PER PEMB FABRICATOR, AT JOINT BETWEEN NEW AND EXISTING STRUCTURE.
3.	EXPANSION WALL JOINT PER PEMB FABRICATOR, AT JOINT BETWEEN NEW AND EXISTING STRUCTURE.
4.	SHEET METAL GUTTER
5.	METAL WALL PANELING BY PEMB FABRICATOR
6.	FINISH GRADING CONTOUR - SEE CIVIL DRAWINGS
7.	HVAC WALL PENETRATIONS - CONFIRM EXACT OPENING SIZE WITH PURCHASED EQUIPMENT SPECIFICATIONS, REFER TO SHEET AA-08, SEE HVAC DRAWINGS
8.	NEW STANDING SEAM ROOFING TO REPLACE EXISTING BY PEMB FABRICATOR
9.	NEW SHEET METAL GUTTER TO REPLACE EXISTING
10.	EXISTING OVERHEAD ROLLING DOOR TO REMAIN.
11.	EXISTING PERSONNEL DOOR TO REMAIN.
12.	NEW METAL WALL PANEL TO BE INSTALLED OVER EXISTING METAL WALL PANEL.
13.	SHEET METAL ROOF TRIM, BY PEMB FABRICATOR.
14.	SHEET METAL DOWNSPOUT AND SPLASH BLOCK AT GRADE.

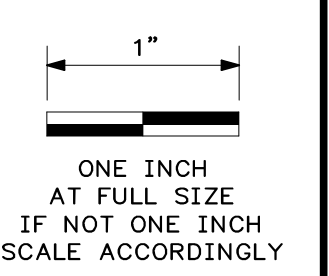


DATE	REVISION

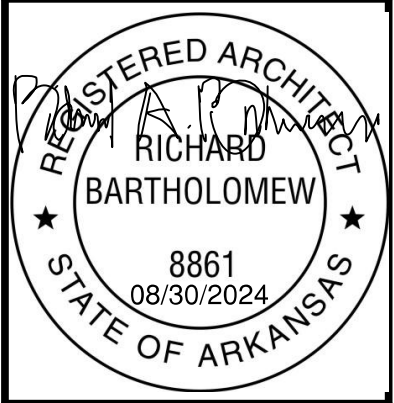

ARCHITECTURAL SYMBOL LEGEND

(101A)	DOOR
(W)	WINDOW

HAWKINS WEIR ENGINEERS, INC.
 BLACK & VEATCH
 REGISTERED ARCHITECT
 RICHARD BARTHOLOMEW
 8861
 08/30/2024
 STATE OF ARKANSAS
 Black & Veatch Architects Arkansas, PLLC
 Overland Park, Kansas
 COA: IL209

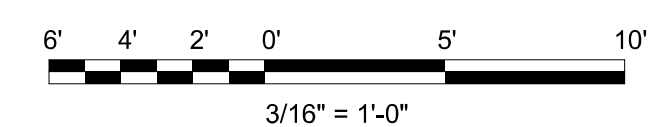

ROGERS, ARKANSAS
 ROGERS POLLUTION CONTROL FACILITY (PCF)
 SOLIDS HANDLING IMPROVEMENTS, PHASE II
 ELEVATIONS
 FOR: ROGERS WATER UTILITIES

DATE: AUGUST 2024
 SCALE: 3/16" = 1'-0"
 DESIGNED BY: CAA
 DRAWN BY: SJU
 HWEI NO.: 2020043
 FILENAME:
 SHEET NO.
AB-04