

8/27/2024 3:14:33 PM DRYER BUILDING - SCHEDULES AND DETAILS


Autodesk Docs: //406493 - Rogers PCF Solids Phase 2/406493-Solids Building-BV.rvt

ROOM FINISH SCHEDULE																			
ROOM No.	ROOM NAME	FLOOR		WALLS						CEILING			REMARKS						
		MATRL	FINISH	NORTH		EAST		SOUTH		WEST		MATRL		FINISH	HEIGHT				
				MATRL	FINISH	BASE	MATRL	FINISH	BASE	MATRL	FINISH	BASE	MATRL	FINISH	BASE	MATRL	FINISH	HEIGHT	
101	DRYER ROOM	CO	CS	LP/CO	FF/CS	NO	LP/CO	FF/CS	NO	LP/CO	FF/CS	NO	CB/LP/CS	PT/FF/CS	NO	EXP	NO		
102	BOILER ROOM	CO	CS	CB	PT	NO	CB	PT	NO	GYP	PT	RB	GYP	PT	RB	EXP	NO		
103	ELECTRICAL ROOM	CO	CS	GYP	PT	RB	GYP	PT	RB	GYP	PT	RB	GYP	PT	RB	EXP	NO		
104	RESTROOM	CO	CS	GYP	PT	RB	GYP	PT	RB	CT	FF	CT	GYP	PT	RB	GYP	PT	10'-0"	
105	OFFICE	CO	RF	GYP	PT	RB	GYP	PT	RB	GYP	PT	RB	GYP	PT	RB	ACP	FF	10'-0"	
201	EQUIPMENT MEZZANINE	CO	CS	NO	NO	NO	NO	NO	NO	LP	FF	NO	LP	FF	NO	EXP	NO		

GLAZING SCHEDULE (G)	
GLAZING TYPE (G)	DESCRIPTION
G1	CLEAR LAMINATED GLASS (REFER TO DOOR/WINDOW SCHEDULE FOR FIRE RATING)

GENERAL NOTES


1. FOR ALL PAINT SYSTEMS REFER TO THE PROTECTIVE COATINGS SPECIFICATION # 09940.

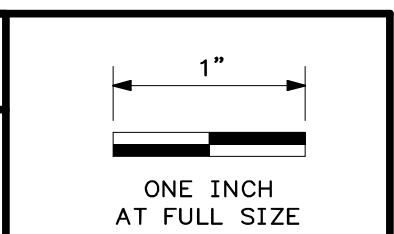

SCHEDULE LEGEND

ACP	ACOUSTICAL CEILING PANEL
ALUM	ALUMINUM
CB	CONCRETE BLOCK
CO	CONCRETE
CS	CONCRETE SEALER
CT	CERAMIC TILE
EXP	EXPOSED CONSTRUCTION
FF	FACTORY FINISH
HM	HOLLOW METAL
GYP	GYPSON WALL BOARD
LP	LINER PANEL
NO	NONE
PT	PAINT
RA	ROLLING ALUMINUM
RF	RESILIENT FLOORING
RB	RUBBER WALL BASE


DOOR SCHEDULE (D)															
DOOR No. (D)	PAI R	DOOR SIZE		TYPE (D)	MATERIAL	DOOR DETAILS			HDWR	RATING	MATERIAL	FRAME DIMENSIONS			REMARKS
		WIDTH	HEIGHT			HEAD	JAMB	SILL				HEAD	WIDTH	DEPTH	
101A		3'-0"	7'-10"	A	HM	4	5	3	#01	-	HM	2"	2"	5 3/4"	
101B		20'-4"	22'-0"	C	RA	7	8	9	-	-	-	-	-	0"	
101C		3'-0"	7'-10"	A	HM	4	5	3	#01	-	HM	2"	2"	5 3/4"	
101D		20'-4"	22'-0"	C	RA	7	8	9	-	-	-	-	-	0"	
101E		20'-4"	22'-0"	C	RA	7	8	9	-	-	-	-	-	0"	
101F		3'-0"	7'-10"	A	HM	4	5	3	#01	-	HM	2"	2"	5 3/4"	
101G		20'-4"	22'-0"	C	RA	7	8	9	-	-	-	-	-	0"	
101H		3'-0"	7'-10"	A	HM	4	5	3	#01	-	HM	2"	2"	5 3/4"	
101I		16'-8"	18'-0"	C	RA	7	8	9	-	-	-	-	-	0"	
102A		3'-0"	7'-10"	A	HM	4	5	3	#01	-	HM	2"	2"	5 3/4"	
102B		3'-0"	7'-10"	A	HM	13	14	15	#03	3 HOUR	HM	2"	2"	5 3/4"	
102C		3'-0"	7'-10"	A	HM	4	5	3	#01	-	HM	2"	2"	5 3/4"	
102D		12'-8"	12'-0"	C	RA	7	8	9	-	-	-	-	-	0"	
102E		12'-8"	12'-0"	C	RA	7	8	9	-	-	-	-	-	0"	
103A	PR	3'-0"	7'-10"	B	HM	4	5	3	#02	-	HM	2"	2"	5 3/4"	
103B		3'-0"	7'-10"	A	HM	1	2	3	#03	3 HOUR	HM	2"	2"	5 3/4"	
104A		3'-0"	7'-10"	A	HM	1	2	3	#04	3 HOUR	HM	2"	2"	5 3/4"	
105A		3'-0"	7'-10"	A	HM	1	2	3	#05	3 HOUR	HM	2"	2"	5 3/4"	

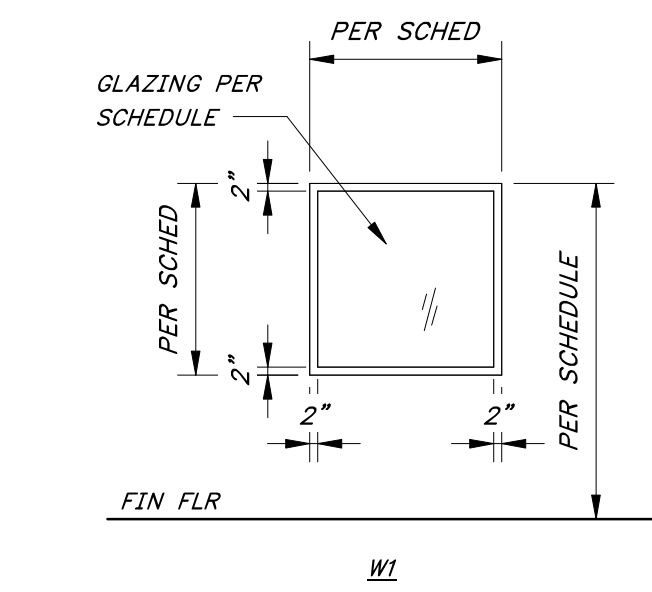


WINDOW TYPES
1/4" = 1'-0"

WINDOW SCHEDULE (W)												
LEVEL	QTY	TYPE (W)	OPENING		FRAME DEPTH	MATERIAL	WINDOW DETAILS			GLAZING TYPE (G)	TOP ELEV AFF	COMMENTS
			WIDTH	HEIGHT			HEAD	JAMB	SILL			
FINISHED FLOOR	3	W1	4'-0"	4'-0"	4 1/2"	HM	7	8	9	G1	8'-0"	FIRE RATED FOR 3 HOURS. REFER TO STEEL DOORS AND FRAMES SECTION #08110


LOUVER SCHEDULE						
LEVEL	LOUVER No.	LOUVER TYPE	LOUVER			REMARKS
			HEAD	JAMB	SILL	
FINISHED FLOOR	101A	STATIONARY	4	5	6	
FINISHED FLOOR	201A	STATIONARY	4	5	6	

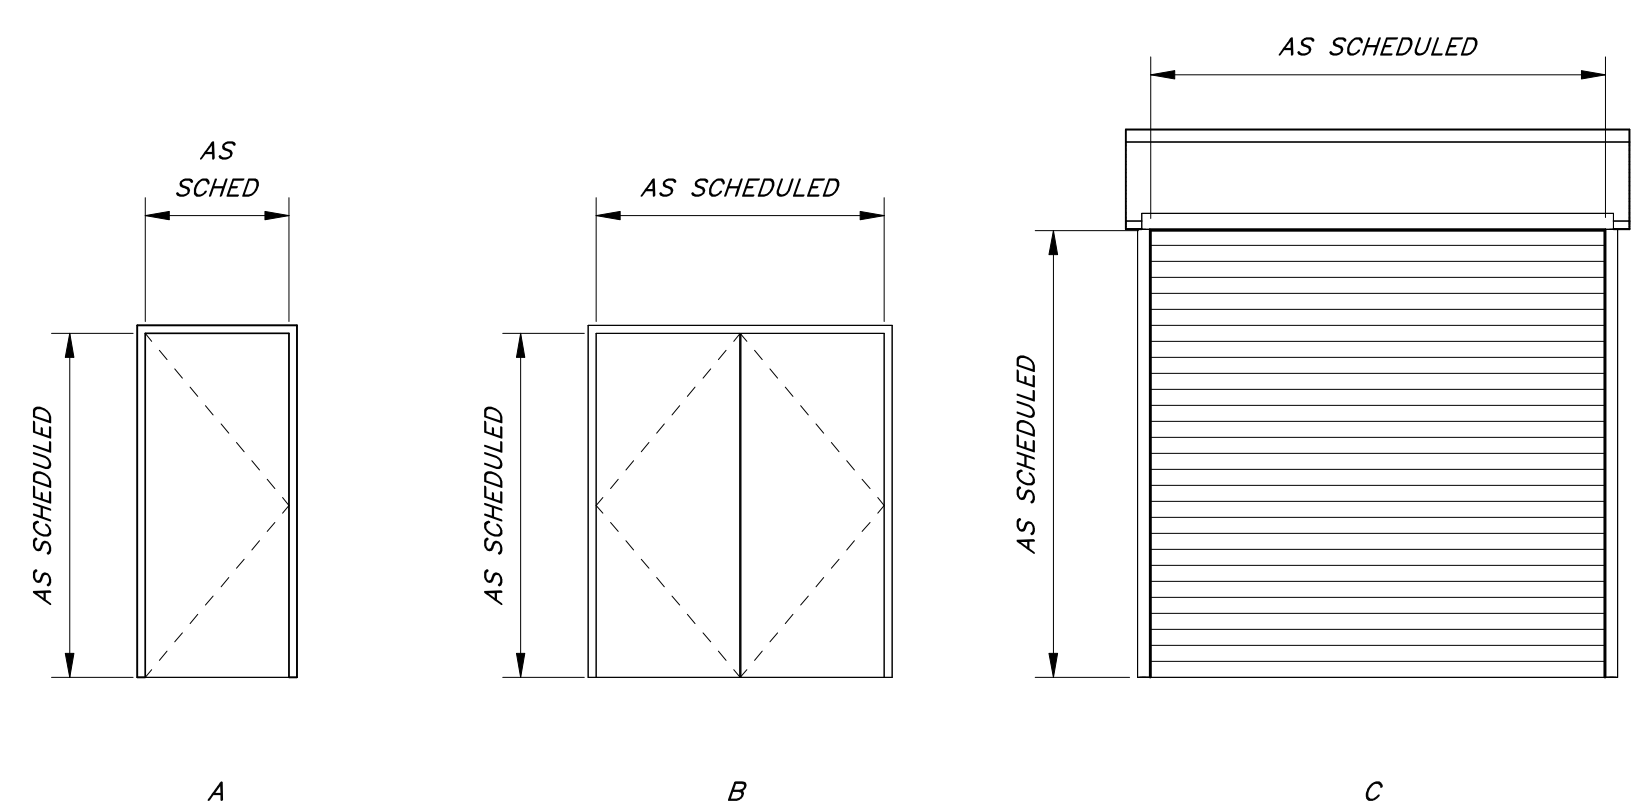

DOOR TYPES
1/4" = 1'-0"

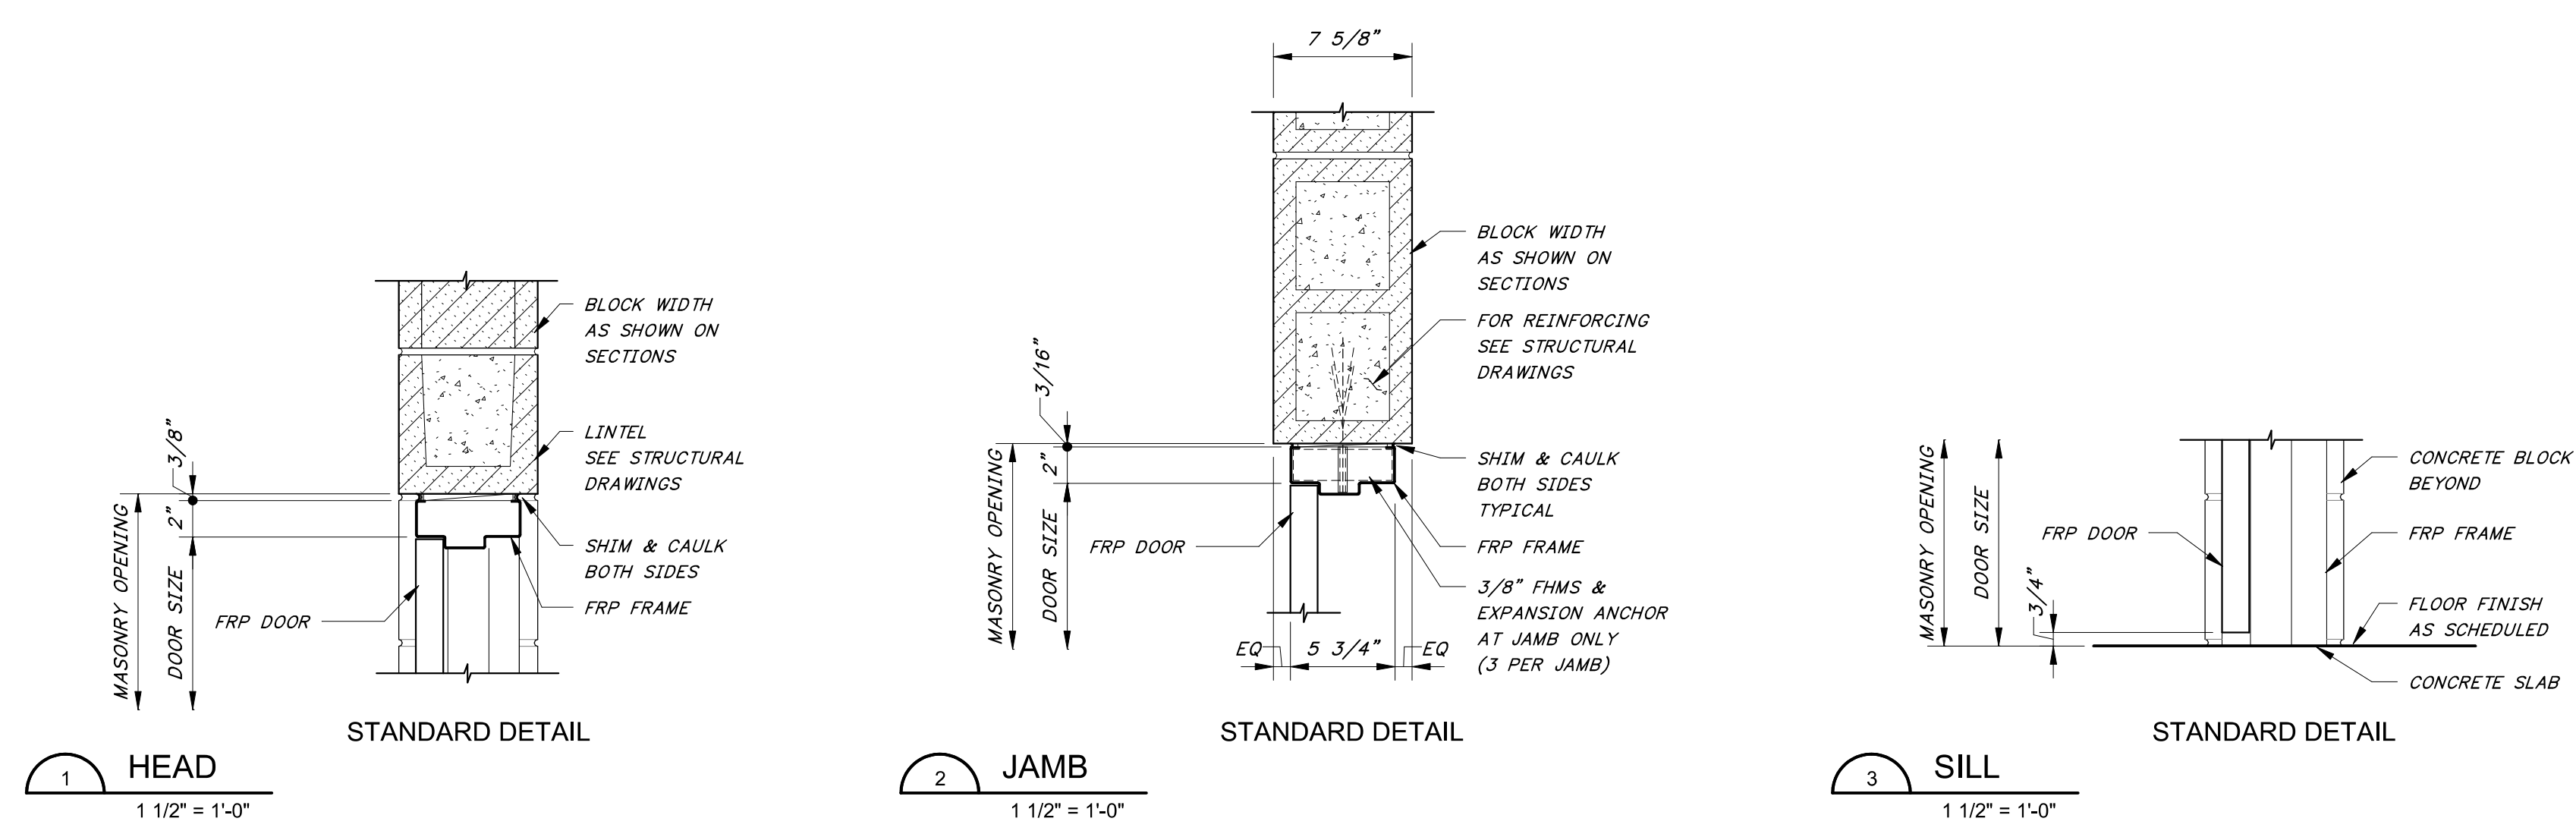

DATE	REVISION

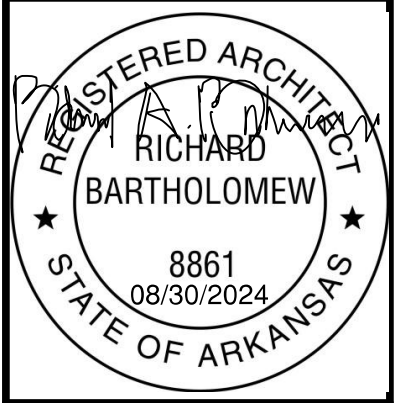

HAWKINS WEIR ENGINEERS, INC.
 Black & Veatch Architects Arkansas, PLLC
 Overland Park, Kansas
 COA: LL209
BLACK & VEATCH
 FOR: ROGERS WATER UTILITIES

ROGERS, ARKANSAS
 ROGERS POLLUTION CONTROL FACILITY (PCF)
 SOLIDS HANDLING IMPROVEMENTS, PHASE II
DRYER BUILDING - SCHEDULES AND DETAILS
 DATE: AUGUST 2024
 SCALE: As indicated
 DESIGNED BY:
 DRAWN BY:
 HWET NO.: 2020043
 FILENAME: