




5 BRICK WAINSCOT PLAN DETAIL_01
AA-02 3/4" = 1'-0"

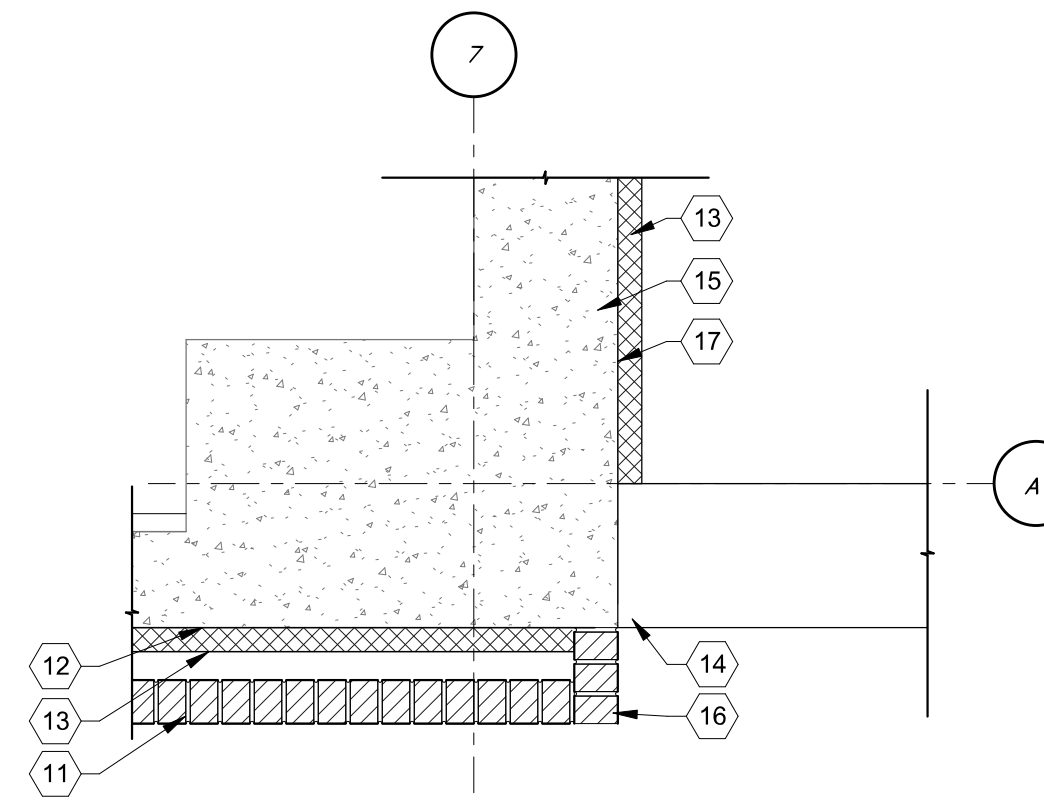


6 BRICK WAINSCOT PLAN DETAIL_02
AA-02 3/4" = 1'-0"

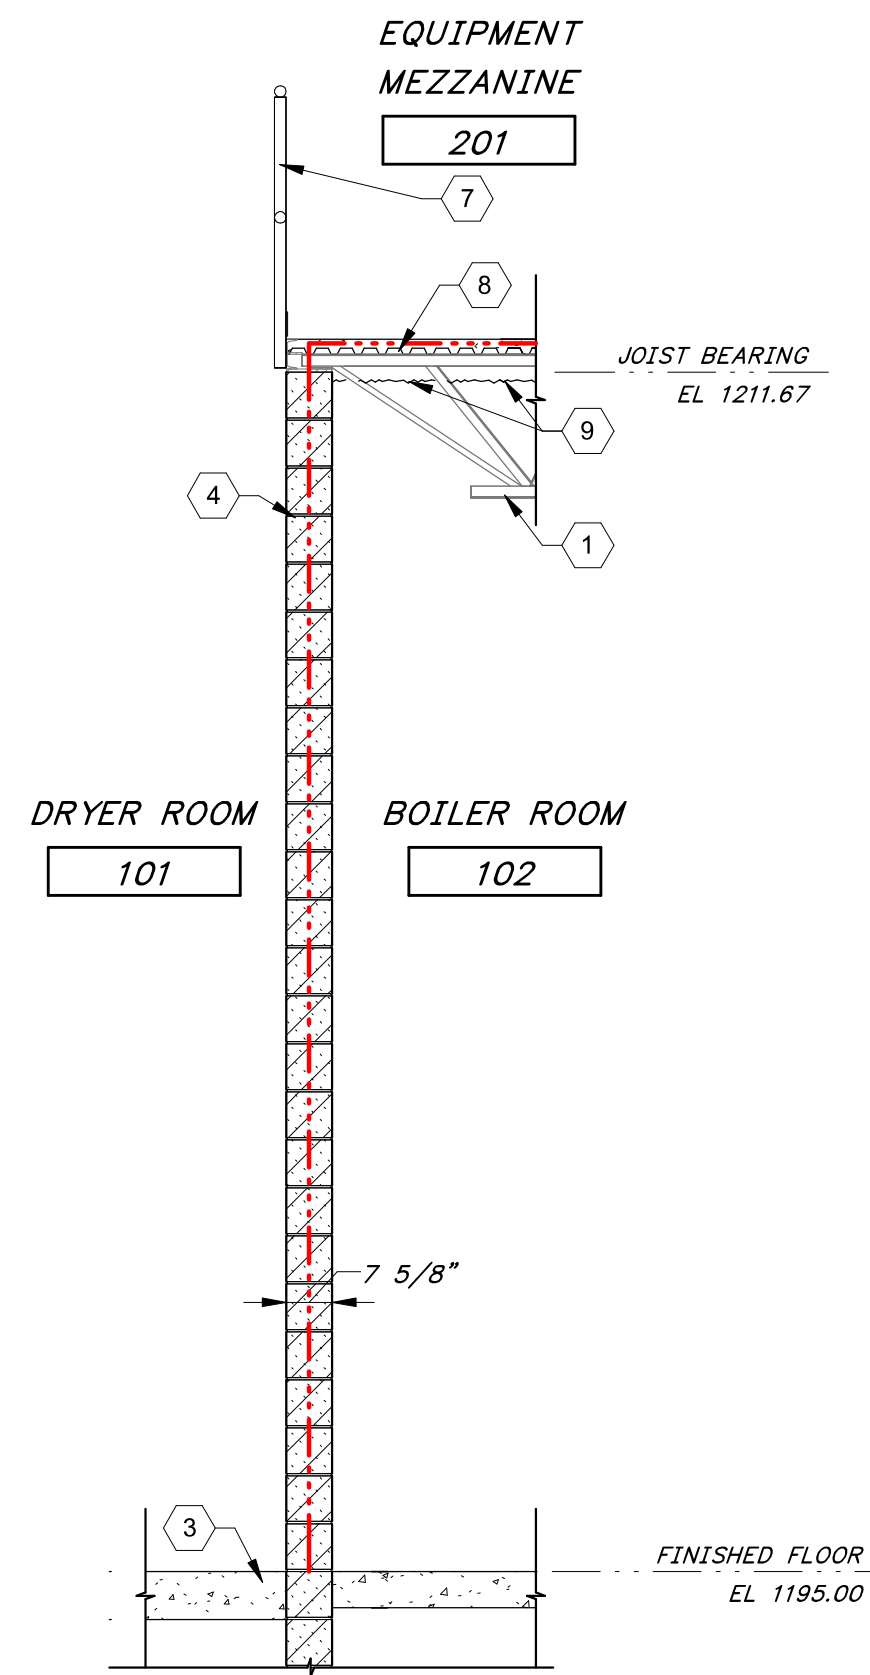


1 WALL SECTION
AA-02 3/8" = 1'-0"

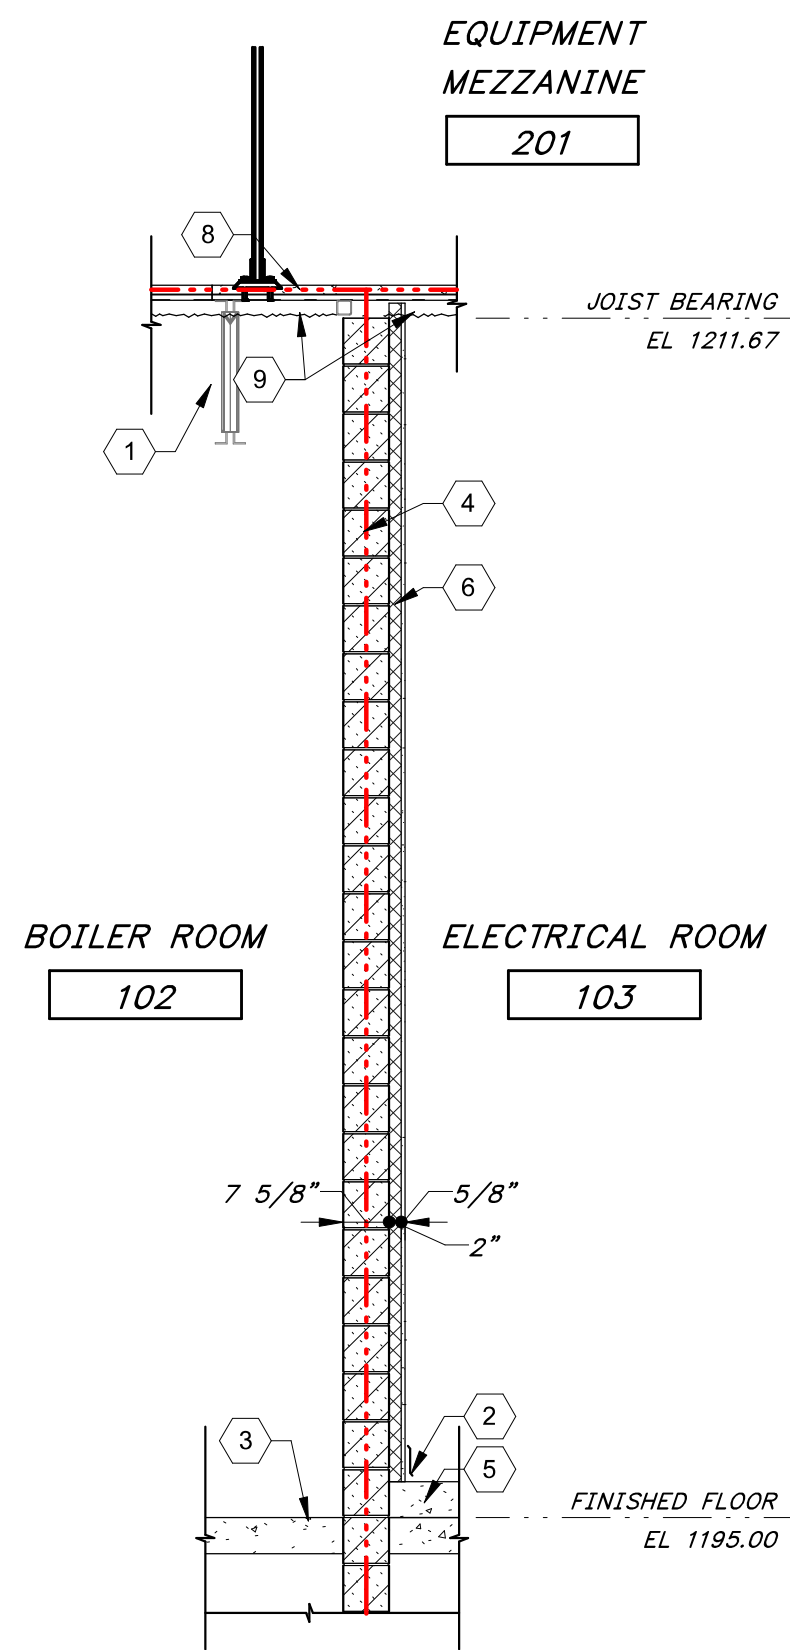

2 WALL SECTION
AA-02 3/8" = 1'-0"

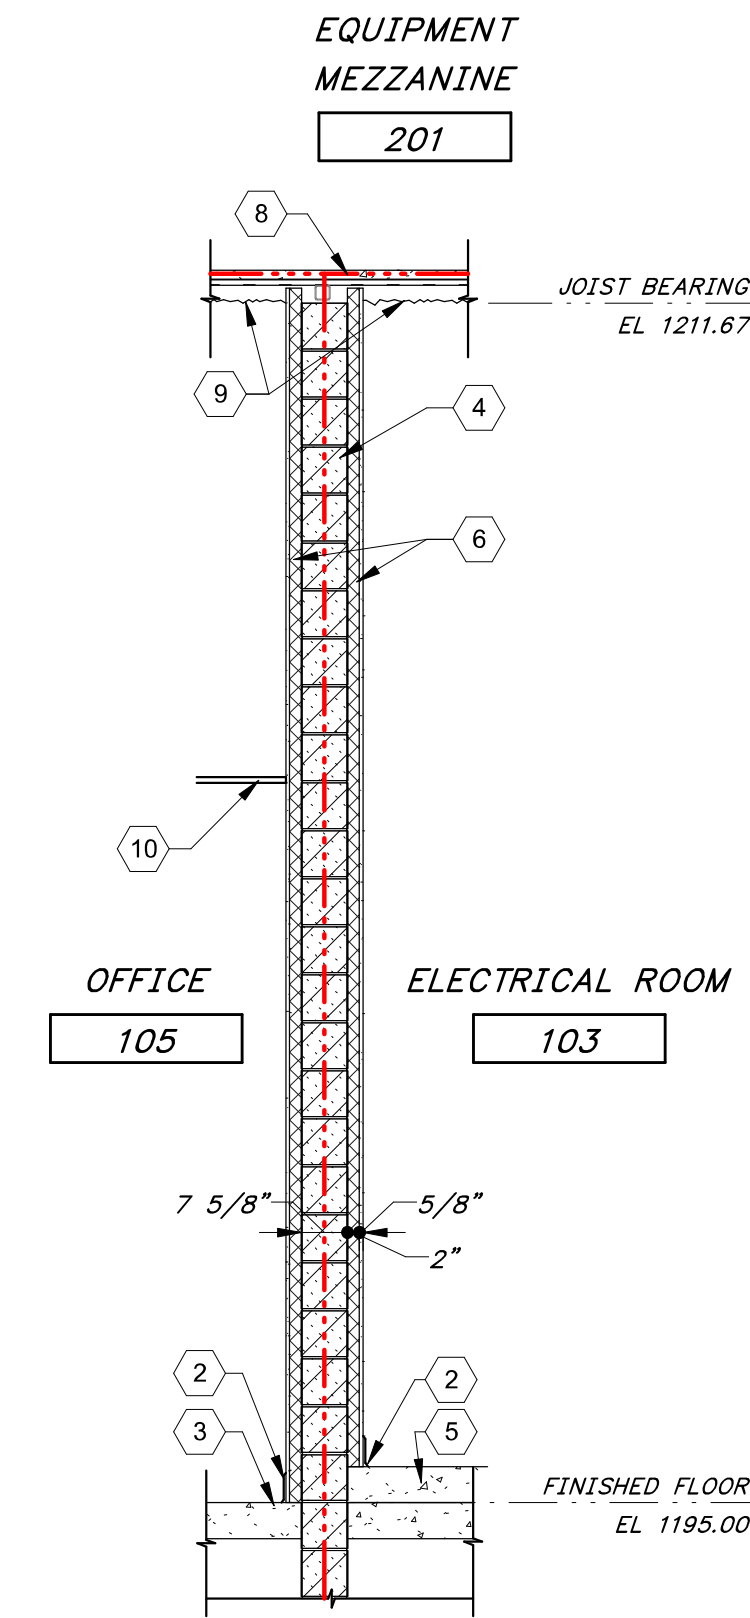

3 WALL SECTION
AA-02 3/8" = 1'-0"

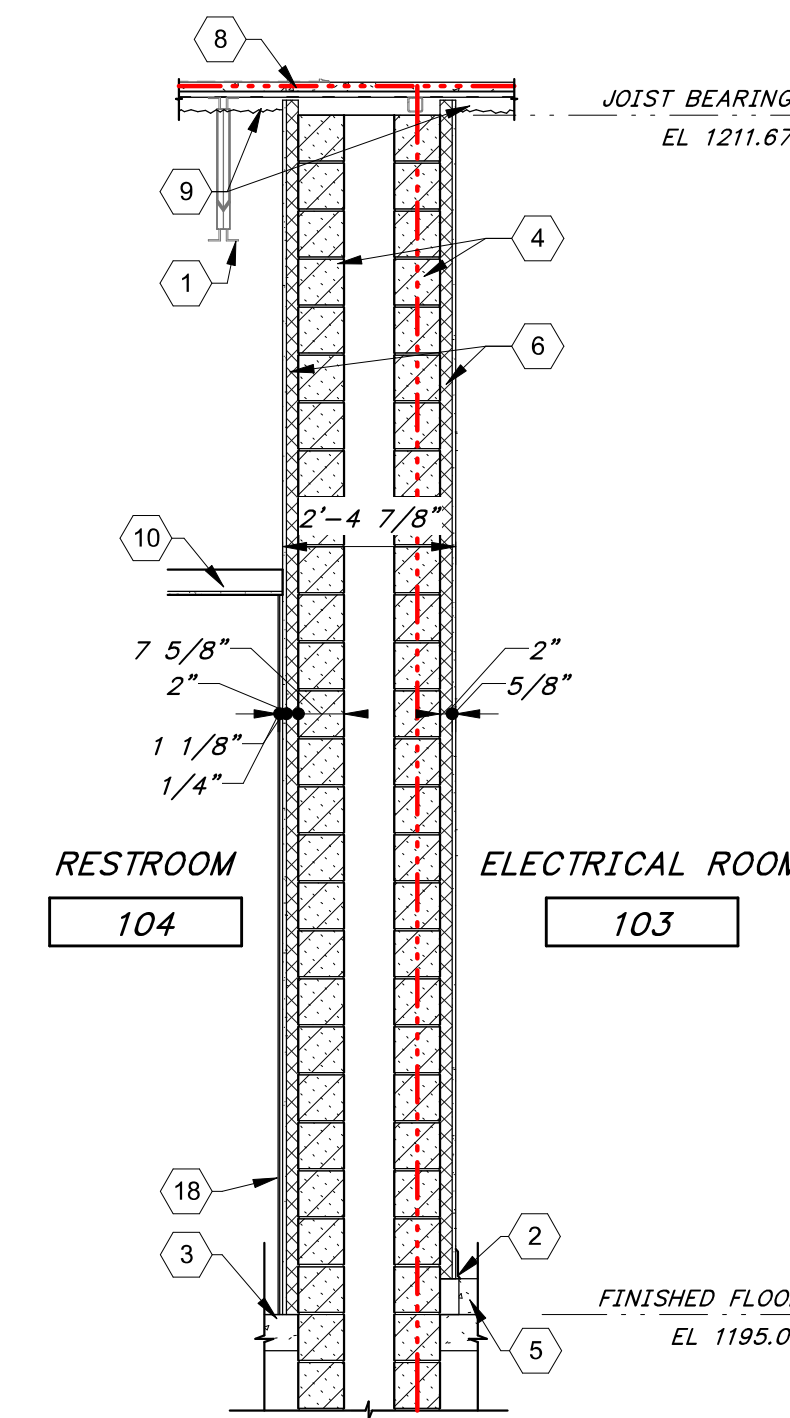

4 WALL SECTION
AA-02 3/8" = 1'-0"


GENERAL SHEET NOTES

SHEET KEYNOTES

1. STEEL FRAMING PER PEMB FABRICATOR
2. RESILIENT WALL BASE.
3. CONCRETE SLAB - SEE STRUCTURAL DRAWINGS.
4. CMU WALL - SEE STRUCTURAL DRAWINGS.
5. CONCRETE CURB, SEE STRUCTURAL DRAWINGS.
6. INSULATION FURRING, 2" RIGID INSULATION (R-10 MIN) MOUNTED ON STEEL FURRING Z-CHANNELS, WITH WALLBOARD FINISH (FRP-FACED PLYWOOD @ BOILER ROOM AND ELECTRICAL ROOM, MOISTURE-RESISTANT GYP BOARD @ RESTROOM)
7. GUARDRAILING, SEE STRUCTURAL DRAWINGS.
8. CONCRETE TOPPING OVER CORRUGATED METAL DECKING, OVER STEEL BEAM FRAMING.
9. SPRAY FOAM INSULATION WITH THERMAL AND IGNITION BARRIER APPLIED TO UNDERSIDE OF METAL DECKING STRUCTURE.
10. SUSPENDED CEILING.
11. ANCHORED BRICK VENEER WITH MASONRY WATER REPELLENT.
12. FLUID APPLIED MEMBRANE AIR BARRIER.
13. RIGID INSULATION (R-10 MINIMUM)
14. RERAINING WALL, SEE STRUCTURAL.
15. CAST-IN-PLACE CONCRETE WALL/ COLUMN PEDESTAL.
16. BRICK RETURN.
17. DAMPROOFING.
18. CERAMIC WALL TILE.

ARCHITECTURAL SYMBOL LEGEND

--- 3 HOUR FIRE BARRIER

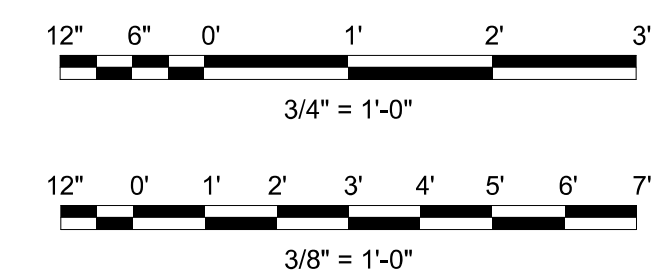

1" ONE INCH AT FULL SIZE IF NOT ONE INCH SCALE ACCORDINGLY

DATE	REVISION



HAWKINS WEIR ENGINEERS, INC.
Black & Veatch Architects Arkansas, PLLC
Overland Park, Kansas
COA: LL209



ROGERS, ARKANSAS
ROGERS POLLUTION CONTROL FACILITY (PCF) SOLIDS HANDLING IMPROVEMENTS, PHASE II
DRYER BUILDING - SECTIONS
FOR: ROGERS WATER UTILITIES

DATE: AUGUST 2024
SCALE: As indicated
DESIGNED BY: CAA
DRAWN BY: KMF
HWEI NO.: 2020043
FILENAME:

SHEET NO.
AA-06