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CENTER**

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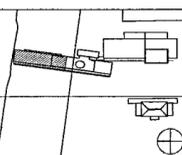
Curtainwall Consultant

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126 Fifth Avenue, 9th Floor
New York, New York 10011
212 652-2906

Seal



100% Construction Documents	08/27/02
90% Progress Printing	08/29/02
100% Design Development	03/01/02
Issue	Date



Job No POLSHEK & PARTNERS ARCH 0608
CROMWELL AE 99-114

Scale 1/8" = 1'-0"

Date SEPTEMBER 27 2002

Title **MUSEUM
LOWER LEVEL
MECHANICAL
PARTIAL PLAN**

Sheet No


M303a



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GENERAL NOTES:

- BEFORE INSTALLATION OF ANY DUCTWORK, THE CONTRACTOR SHALL COORDINATE ALL PLUMBING, FIRE PROTECTION, AND DUCTWORK ROUTING
- REFER TO THE ARCHITECTURAL REFLECTED CEILING PLANS AND ELEVATIONS FOR EXACT LOCATION OF AIR DEVICES AND LOUVERS
- ALL SUPPLY AND RETURN BRANCHES TO AND FROM AIR DEVICES IN AREAS WITH LAY-IN CEILING SHALL BE PROVIDED WITH A VOLUME DAMPER AT THE MAIN DUCT
- PROVIDE 5'-0" MAXIMUM FLEX DUCT AT AIR DEVICES
- VERIFY ROOM SENSOR (THERMOSTAT) LOCATIONS WITH THE CONSTRUCTION MANAGER.
- COORDINATE LOCATION OF CONDUITS IN BLOCK WALLS FOR ROOM SENSORS WITH CONSTRUCTION MANAGER. SURFACE MOUNTED CONDUIT IS NOT ALLOWED
- PROVIDE DYNAMIC FIRE DAMPERS OF PROPER RATING AT ALL DUCT PENETRATIONS THROUGH RATED WALLS
- PROVIDE ACCESS DOORS IN DRYWALL CEILINGS AS REQUIRED TO PROVIDE ACCESS FOR MAINTENANCE TO VALVES, DAMPERS FIRE DAMPERS ETC

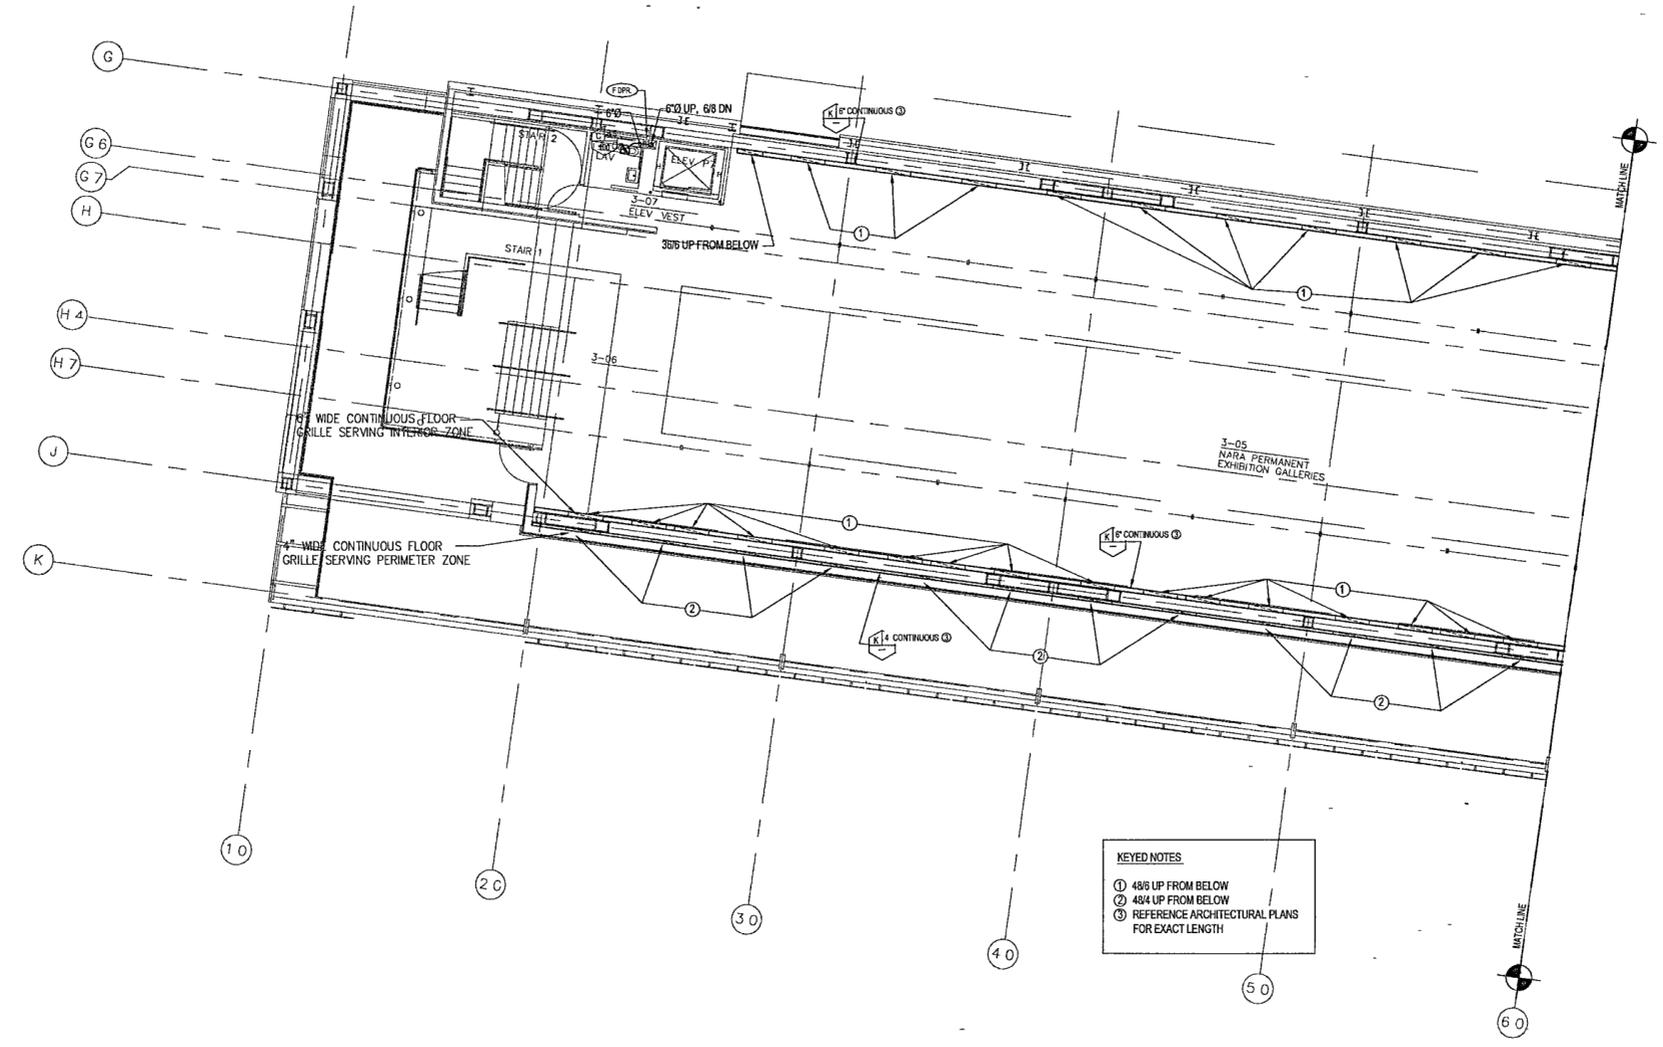

KEYED NOTES
 ① 48" UP FROM BELOW
 ② 48" UP FROM BELOW
 ③ REFERENCE ARCHITECTURAL PLANS FOR EXACT LENGTH

1 MUSEUM - LOWER LEVEL MECHANICAL PLAN
 M303a | M303a 1/8" = 1'-0" NORTH