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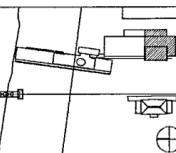
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Issue	Date
100% Construction Documents	09/27/02
90% Progress Printing	08/29/02
100% Design Development	03/16/02



Job No. POLSHEK & PARTNERS ARCH. 9908  
CROMWELL AE 99-114


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Date: SEPTEMBER 27, 2002


Title: ARCHIVES  
ROOF/SECOND LEVEL  
MECHANICAL  
PARTIAL PLAN

Sheet No.

**M302d**

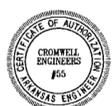

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- GENERAL NOTES**
- BEFORE INSTALLATION OF ANY DUCTWORK, THE CONTRACTOR SHALL COORDINATE ALL PLUMBING, FIRE PROTECTION, AND DUCTWORK ROUTING
  - REFER TO THE ARCHITECTURAL REFLECTED CEILING PLANS AND ELEVATIONS FOR EXACT LOCATION OF AIR DEVICES AND LOUVERS
  - ALL SUPPLY AND RETURN BRANCHES TO AND FROM AIR DEVICES IN AREAS WITH LAY-IN CEILING SHALL BE PROVIDED WITH A VOLUME DAMPER AT THE MAIN DUCT
  - PROVIDE 5'-0" MAXIMUM FLEX DUCT AT AIR DEVICES
  - VERIFY ROOM SENSOR (THERMOSTAT) LOCATIONS WITH THE CONSTRUCTION MANAGER
  - COORDINATE LOCATION OF CONDUITS IN BLOCK WALLS FOR ROOM SENSORS WITH CONSTRUCTION MANAGER. SURFACE MOUNTED CONDUIT IS NOT ALLOWED
  - PROVIDE DYNAMIC FIRE DAMPERS OF PROPER RATING AT ALL DUCT PENETRATIONS THROUGH RATED WALLS
  - PROVIDE ACCESS DOORS IN DRYWALL CEILINGS AS REQUIRED TO PROVIDE ACCESS FOR MAINTENANCE TO VALVES, DAMPERS, FIRE DAMPERS, ETC

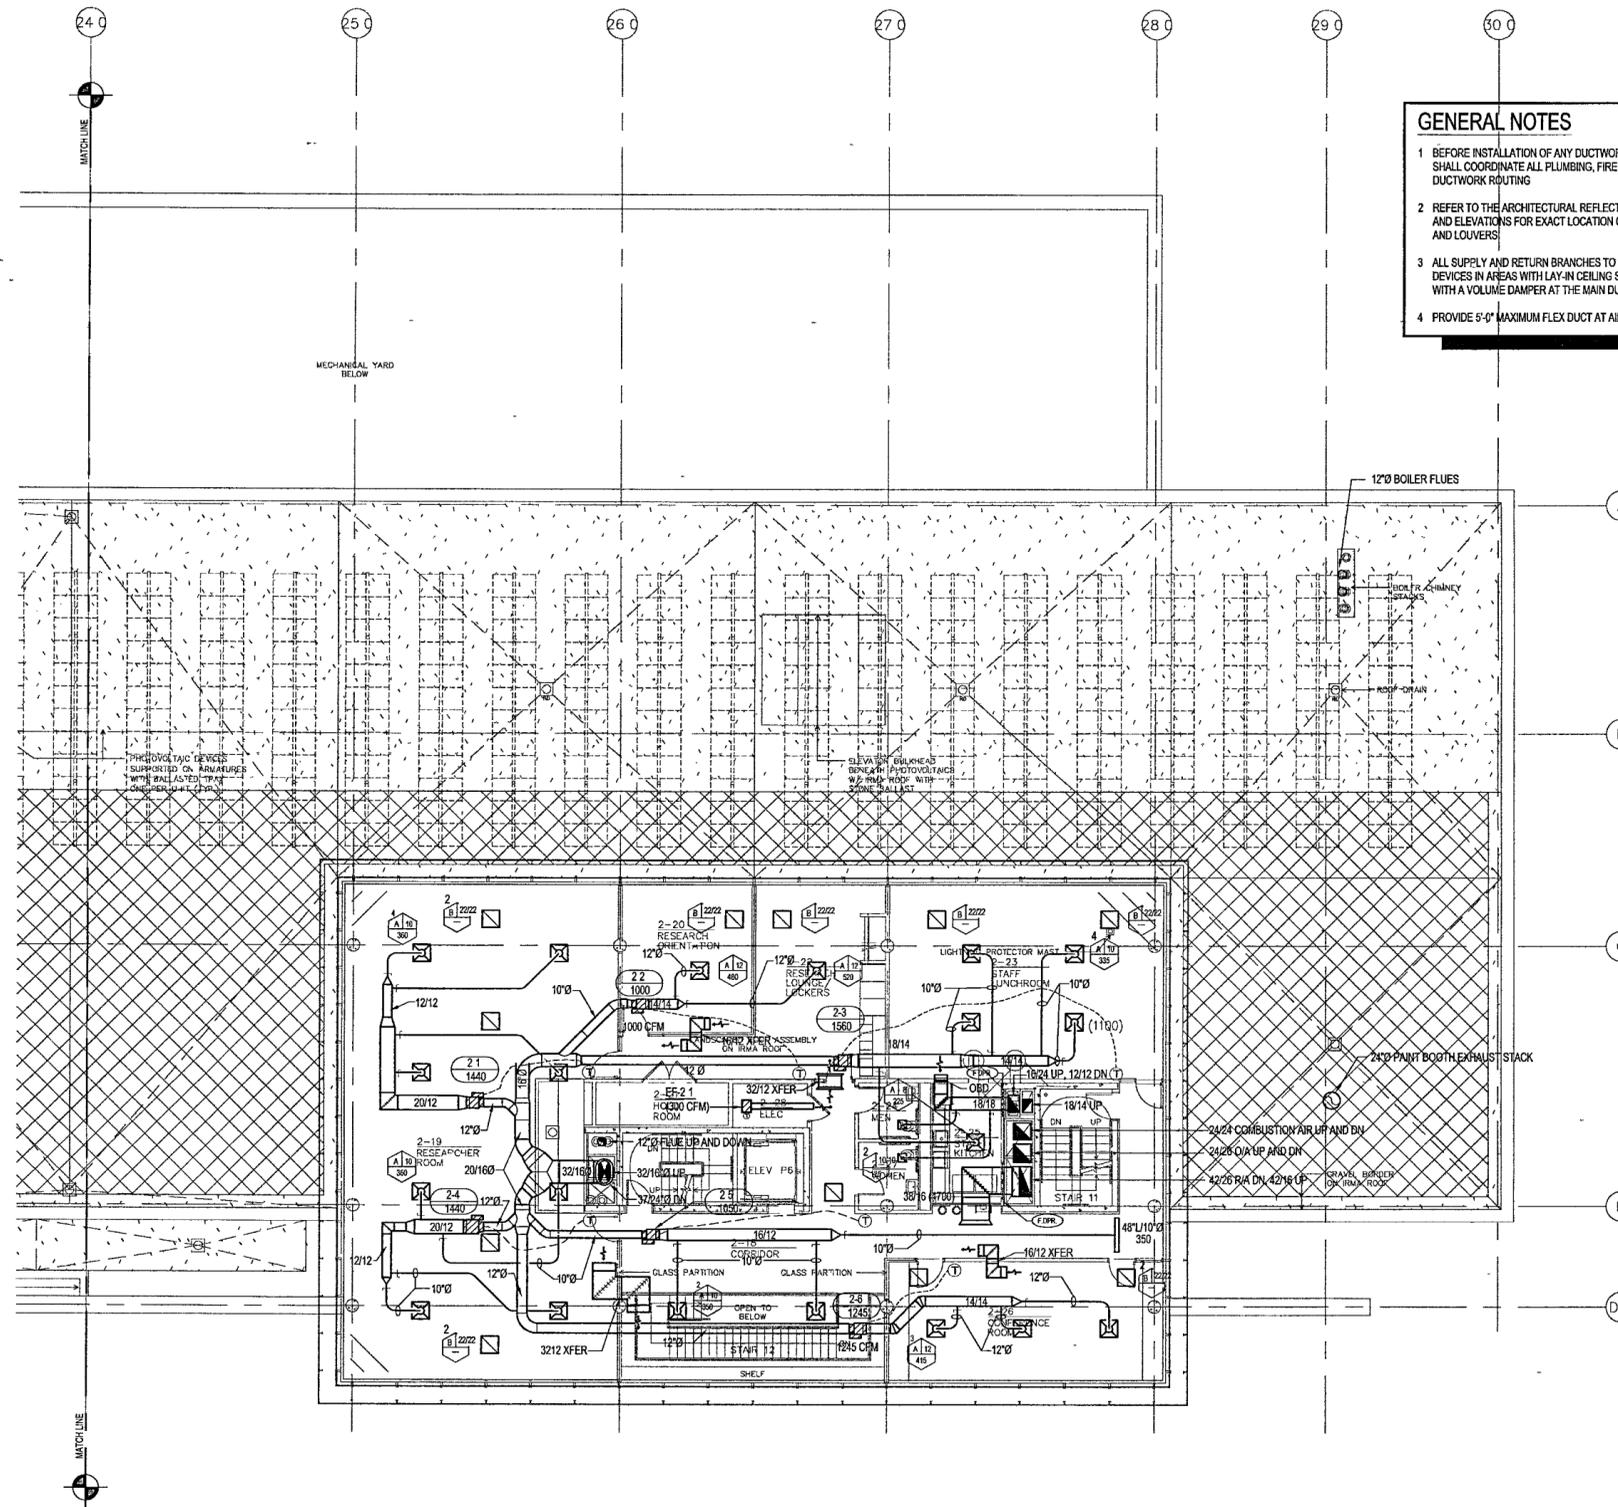**1 ARCHIVES - ROOF/SECOND LEVEL MECHANICAL PLAN**  
M302d | M302d 1/8" = 1'-0" NORTH