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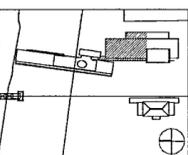
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Issue	Date
100% Construction Documents	09/27/02
90% Progress Printing	09/30/02
100% Design Development	03/01/02



Job No. POLSHEK & PARTNERS ARCH 0908
CROMWELL AE 99-114

Scale 1/8" = 1'-0"

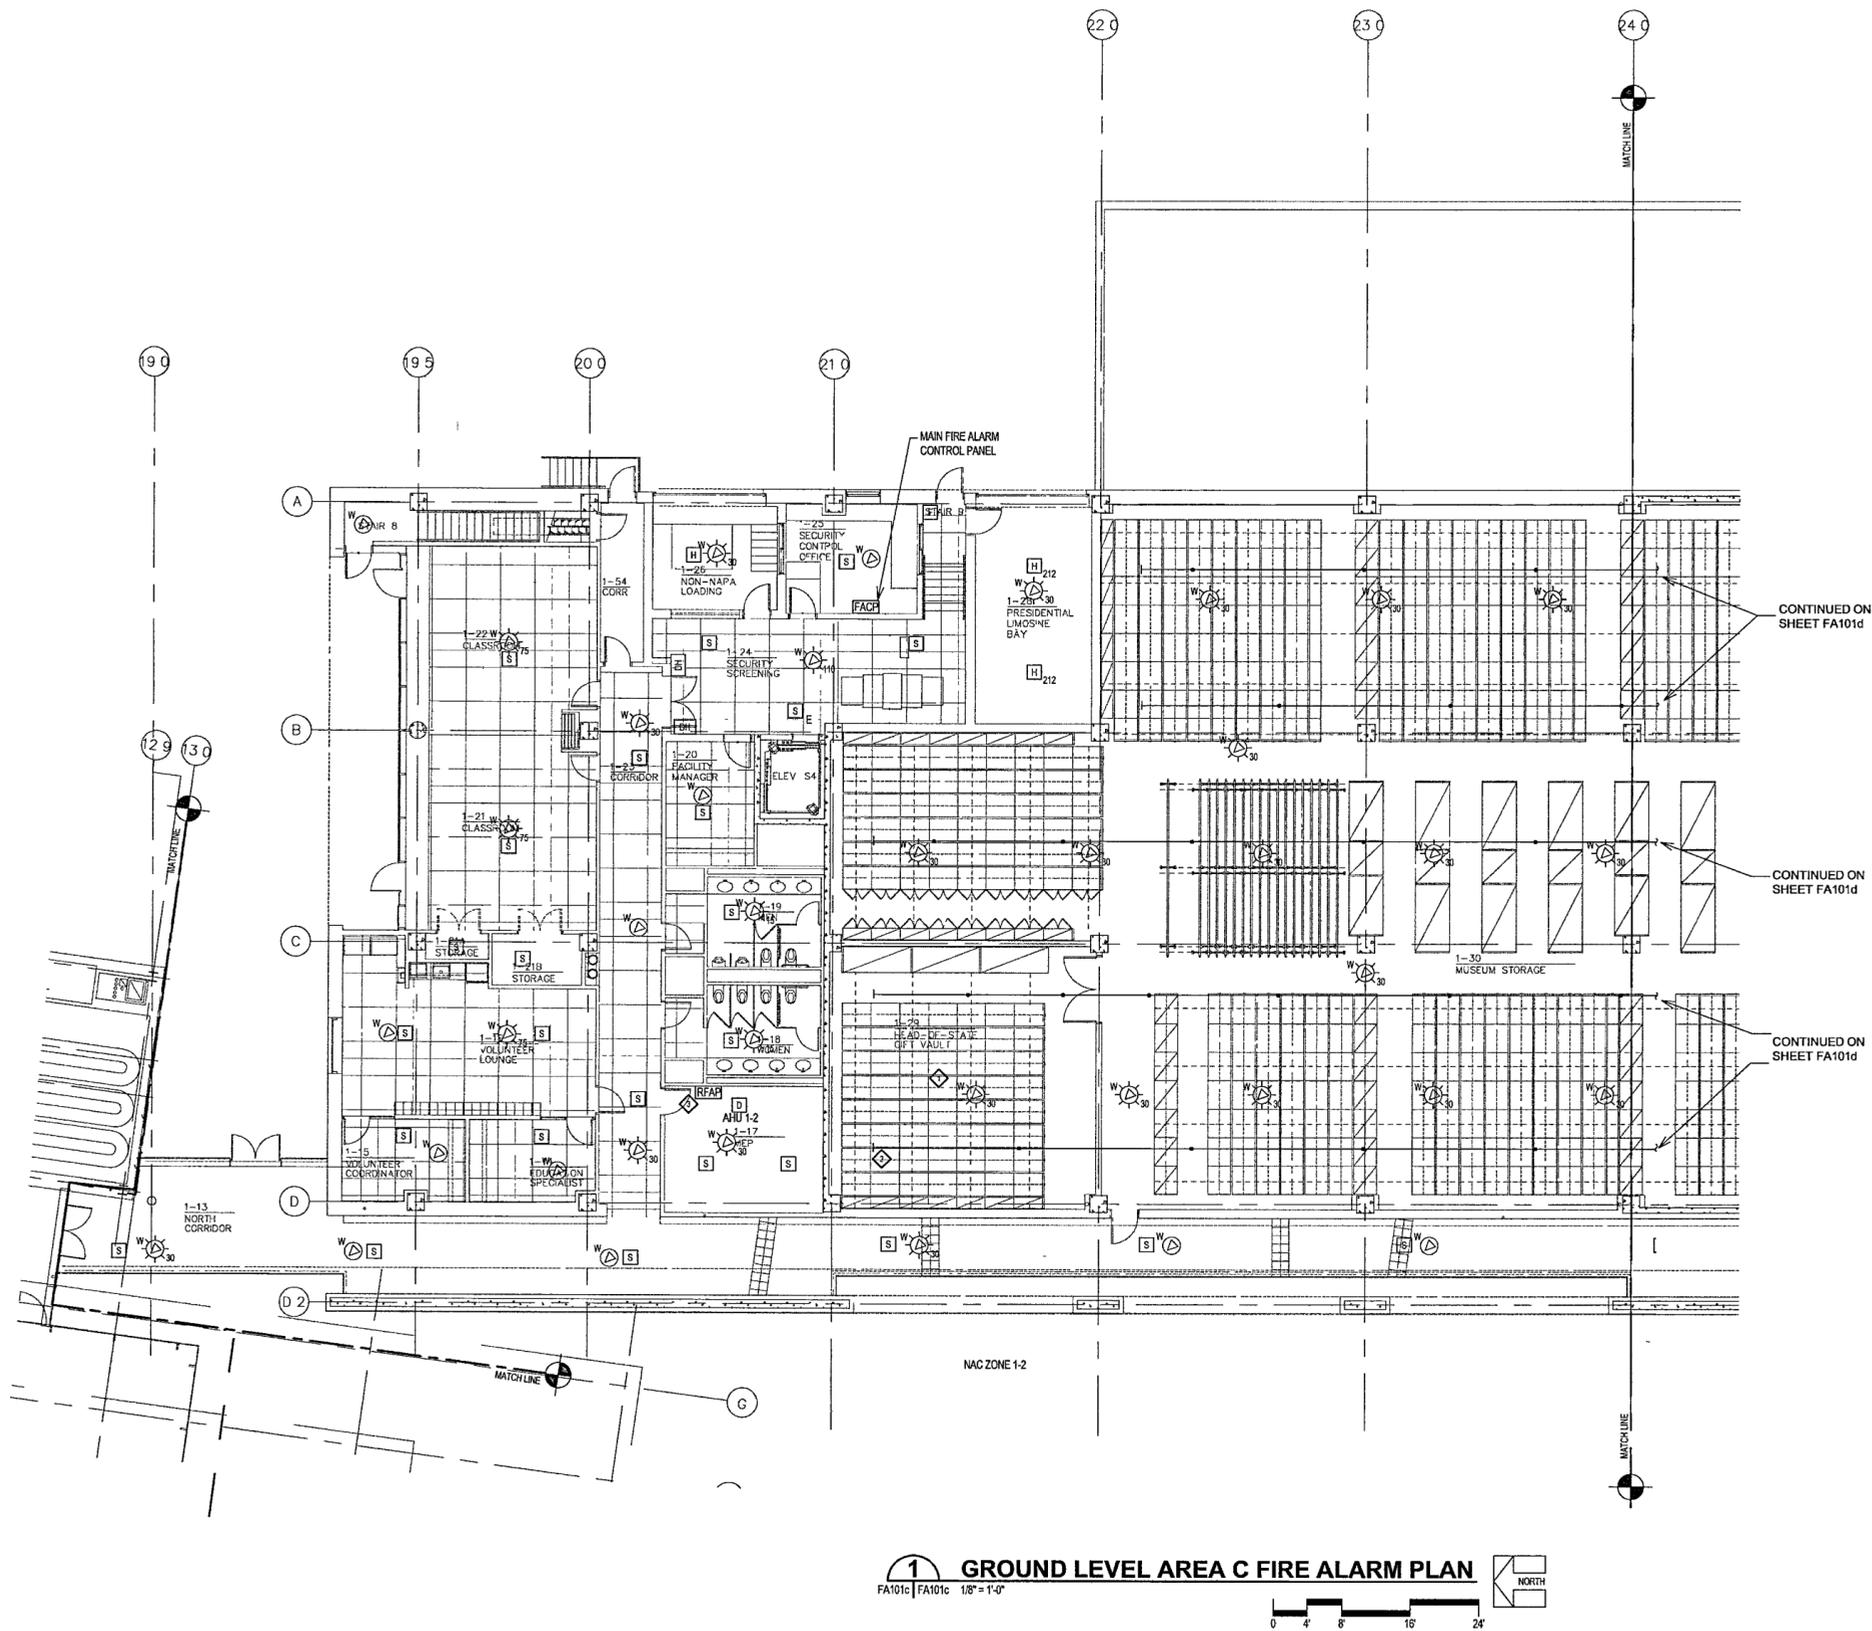
Date SEPTEMBER 27, 2002

Title **GROUND LEVEL
AREA C FIRE ALARM
PLAN**

Sheet No. **FA101c**



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- KEYED NOTES**
- ◆ SPEAKER/STROBES IN ARCHIVE ROOMS SHALL BE MOUNTED ON BOTTOM OF BEAMS
 - ◆ CPVC PIPE FOR ULTRA HIGH SENSITIVE SMOKE DETECTION SYSTEM (VESDA) SHALL BE RUN UNDER BEAMS WITH HOLES DRILLED INTO BOTTOM OF PIPE & SIZED PER CALCULATIONS
 - ◆ REMOTE FIRE ALARM PANEL (BOOSTER) TO BE INSTALLED AS NEEDED BY CONTRACTOR
 - ◆ ARCHIVE STORAGE AREAS UTILIZE A VESDA DETECTION SYSTEM WITH REDUCED SPACING AND GREATER SENSITIVITY OVER CONVENTIONAL SPOT DETECTORS TO ACCOUNT FOR POCKETS OF WAFFLE CEILING CONFIGURATION
- SEE SHEET FA501 FOR ADDITIONAL VESDA SYSTEM INFORMATION

1 GROUND LEVEL AREA C FIRE ALARM PLAN
FA101c | FA101c 1/8" = 1'-0"
NORTH

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