


NOTE

1. THESE DRAWINGS SUPPLEMENT INFORMATION ON THE M.E.P./E.P. AND SECURITY DRAWINGS AND ARE TO BE USED FOR DIMENSIONAL LOCATION OF ALL M.E.P./E.P. AND SECURITY SYSTEMS. ALL M.E.P./E.P. AND SECURITY SYSTEMS SCOPE AND CONTENTS SHALL BE PER M.E.P. AND SECURITY DRAWINGS.
2. SEE M.E.P. AND SECURITY DRAWINGS FOR ELECTRICAL, MECHANICAL, FIRE PROTECTION AND SECURITY DEVICE LOCATIONS IN THE FOLLOWING ROOMS: JANITORS' CLOSETS, ELECTRICAL CLOSETS, TELEPHONE AND DATA CLOSETS, AV STORAGE CLOSETS, KITCHENS AND GENERAL STORAGE ROOMS.
3. NOTIFY THE ARCHITECT IN THE EVENT OF ANY DISCREPANCIES BETWEEN THE MECHANICAL, ELECTRICAL, PLUMBING, FIRE PROTECTION AND SECURITY DRAWINGS AND THE REFLECTED CEILING PLANS. THE ARCHITECTURAL CEILING PLANS SHALL COVER ALL LOCATIONS AND DIMENSIONS OF ALL EXPOSED TO-VIEW ITEMS. DO NOT PROCEED UNTIL DISCREPANCIES HAVE BEEN RESOLVED.
4. FOR CEILING TYPE AND LOCATION OF FINISH REFER TO FINISH SCHEDULE.
5. FOR CEILING HEIGHTS IN STAIRS, SEE STAIR DETAILS.
6. START POINT OF CEILING GRID SHALL BE CENTER OF TILE AT CENTER OF ROOM U.O.M.
7. WHEN ACoustical CEILING TILE EXCEEDS 2' X 2', PROVIDE 2' X 4' ACoustical CEILING TILE TO BE FIELD CUT.
8. ALL CEILING MOUNTED DEVICES (INCLUDING EXIT SIGNS NOT ADJACENT TO DOORS, SMOKE DETECTORS, LIGHT FIXTURES) SHALL BE CENTERED ON CEILING TILE U.O.M.
9. ALL FIRE STROGES SHALL BE LOCATED 6 1/2" FROM THE ADJACENT DOOR FRAME TO THE CENTERLINE OF THE STROGE U.O.M. ON EITHER THE REFLECTED CEILING PLANS OR THE INTERIOR ELEVATIONS.
10. STEM AND PENDANT MOUNTED FIXTURES SHALL BE INSTALLED AT HEIGHT (BOTTOM OF FIXTURE AFF) INDICATED IN THE SPECIFICATIONS.

KEY		RCP DEVICE KEY	
[Symbol]	EXPOSED AND SEALED SLAB	[Symbol]	FLOOR/CEILING OUTLET
[Symbol]	PTD GWD	[Symbol]	SPEAKER/STROBE
[Symbol]	PERFORATED WOOD ACoustical PANEL W/ BATT INSULATION	[Symbol]	GLASS BREAK DETECTOR
[Symbol]	PAINTED ALUMINUM PANEL SYSTEM	[Symbol]	CEL. MTD MOTION DETECTOR
[Symbol]	EXPOSED AND SEALED WAFFLE SLAB	[Symbol]	WALL MTD MOTION DETECTOR
[Symbol]	ORNAMENTAL GLASS AND METAL CANOPY	[Symbol]	CEL. MTD SECURITY SPEAKER
[Symbol]	STAINLESS STEEL FINISH	[Symbol]	WALL MTD SECURITY SPEAKER
[Symbol]		[Symbol]	CEL. MTD AV SPEAKER
[Symbol]		[Symbol]	WALL MTD AV SPEAKER
[Symbol]		[Symbol]	SECURITY CAMERA
[Symbol]		[Symbol]	CLG. MTD SMOKE/HEAT DETECTOR
[Symbol]		[Symbol]	CLG. MTD EXIT
[Symbol]		[Symbol]	WALL MTD EXIT
[Symbol]		[Symbol]	CLG. MTD SPRINKLER HEAD
[Symbol]		[Symbol]	WALL MTD SPRINKLER HEAD
[Symbol]		[Symbol]	RETURN OUTLET CLG. DIFFUSER
[Symbol]		[Symbol]	SUPPLY OUTLET CLG. DIFFUSER
[Symbol]		[Symbol]	LINEAR SUPPLY DIFFUSER
[Symbol]		[Symbol]	WIRELESS ALARM ANTENNA/TRANSMITTER
[Symbol]		[Symbol]	TELEVISION OUTLET

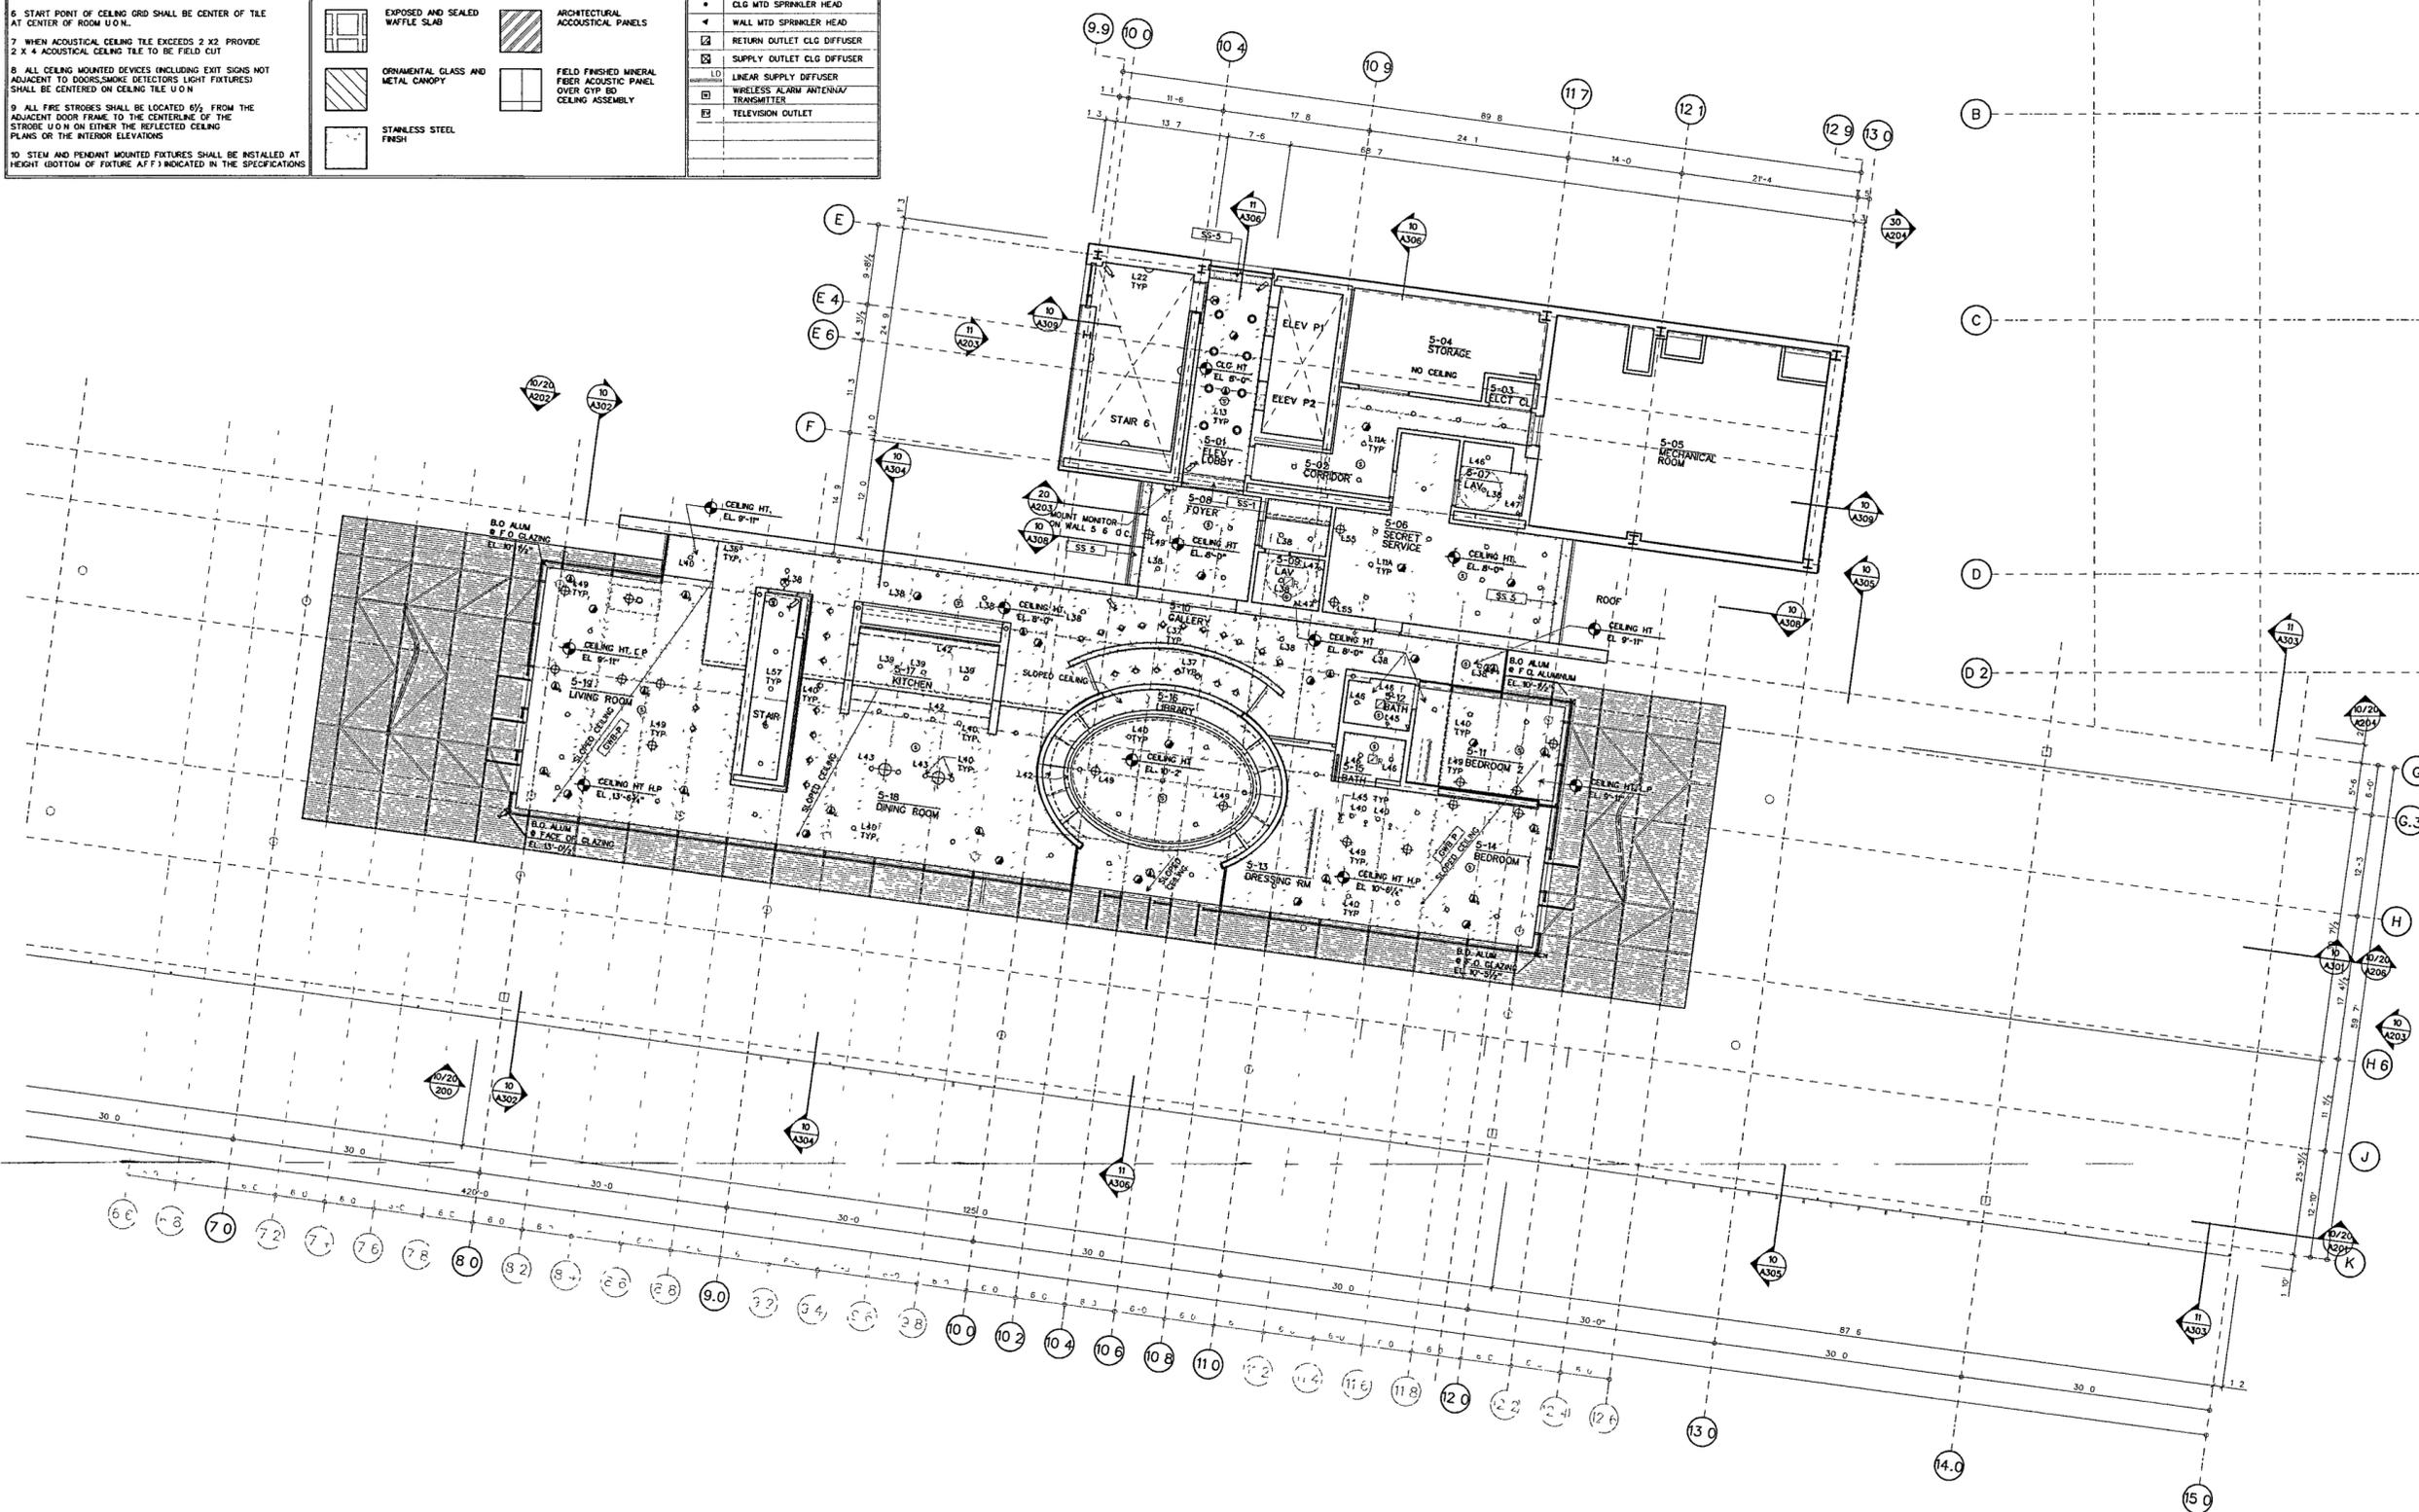

EXECUTIVE LEVEL REFLECTED CEILING PLAN
SCALE 1/4" = 1'-0"

**WILLIAM J CLINTON
PRESIDENTIAL
CENTER**

LITTLE ROCK, ARKANSAS

Architect
POLSHEK PARTNERSHIP LLP
320 West 13th Street
New York, New York 10014
212.807.7171

Coordinating Architects
POLK STANLEY YEARY ARCHITECTS Ltd
700 South Schiller Street
Little Rock, Arkansas 72201
501.378.0878

WITSELL EVANS RASCO
901 West Third Street
Little Rock, Arkansas 72201
501.374.5300

WOODS CARADINE ARCHITECTS
2200 South Main Street
Little Rock, Arkansas 72206
501.374.4060

Landscape Architects
HARGREAVES ASSOCIATES
118 Magazine Street
Cambridge, Massachusetts 02139
617.651.0070

LANDSCAPE ARCHITECTURE, Inc.
2300 Cottondale Lane Suite 202
Little Rock, Arkansas 72202
501.374.9510

Structural Engineer
LESLIE E. ROBERTSON ASSOC., RLLP
30 Broad Street, 47th Floor
New York, New York 10004
212.750.9000


MEP Engineers
FLACK + KURTZ Inc.
475 Fifth Avenue
New York, New York 10017
212.532.9600

CROWMELL ARCHITECTS ENGINEERS
101 South Spring Street
Little Rock, Arkansas 72201
501.372.2900

Curtainwall Consultant
R. A. HEINTGES ARCHITECTS
128 Fifth Avenue, 8th Floor
New York, New York 10011
212.652.2960



Issue	Date
100% Construction Documents	09/27/02
90% Progress Printing	08/30/02
100% Struct./CD Progress	07/01/02
100% Steel & Concrete CD	05/15/02
8 Architectural CD Progress	
100% Design Development	03/01/02

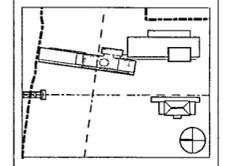

Job No: 9908
Scale: 1/8" = 1'-0"
Date: September 27, 2002
Title: EXECUTIVE LEVEL REFLECTED CEILING PLAN

Sheet No: **A605b**