


NOTE	KEY	RCP DEVICE KEY																																		
1. THESE DRAWINGS SUPPLEMENT INFORMATION ON THE M.E.P. AND SECURITY DRAWINGS AND ARE TO BE USED FOR DIMENSIONAL LOCATION OF ALL M.E.P. AND SECURITY SYSTEMS. ALL M.E.P. AND SECURITY SYSTEMS SCOPE AND CONTENTS SHALL BE PER M.E.P. AND SECURITY DRAWINGS.	<table border="1"> <tr> <td>EXPOSED AND SEALED SLAB</td> <td>PLASTER FINISH</td> </tr> <tr> <td>PTD CWB</td> <td>2 X 2 CLG TILES NOTE WASHABLE SURFACE IN ALL KITCHEN/PANTRY AREAS</td> </tr> <tr> <td>PERFORATED WOOD ACOUSTICAL PANEL W/ BATT INSULATION</td> <td>PERFORATED METAL ACOUSTICAL PANEL OR AIR REGISTER WHERE NOTED</td> </tr> <tr> <td>PAINTED ALUMINUM PANEL SYSTEM</td> <td>RIBBED WOOD ACOUSTICAL PANEL</td> </tr> <tr> <td>EXPOSED AND SEALED WAFFLE SLAB</td> <td>ARCHITECTURAL ACOUSTICAL PANELS</td> </tr> <tr> <td>ORNAMENTAL GLASS AND METAL CANOPY</td> <td>FIELD FINISHED MINERAL FIBER ACOUSTICAL PANEL OVER GYP SO CEILING ASSEMBLY</td> </tr> <tr> <td>STAINLESS STEEL FINISH</td> <td></td> </tr> </table>	EXPOSED AND SEALED SLAB	PLASTER FINISH	PTD CWB	2 X 2 CLG TILES NOTE WASHABLE SURFACE IN ALL KITCHEN/PANTRY AREAS	PERFORATED WOOD ACOUSTICAL PANEL W/ BATT INSULATION	PERFORATED METAL ACOUSTICAL PANEL OR AIR REGISTER WHERE NOTED	PAINTED ALUMINUM PANEL SYSTEM	RIBBED WOOD ACOUSTICAL PANEL	EXPOSED AND SEALED WAFFLE SLAB	ARCHITECTURAL ACOUSTICAL PANELS	ORNAMENTAL GLASS AND METAL CANOPY	FIELD FINISHED MINERAL FIBER ACOUSTICAL PANEL OVER GYP SO CEILING ASSEMBLY	STAINLESS STEEL FINISH		<table border="1"> <tr> <td>FLOOR/CEILING OUTLET</td> </tr> <tr> <td>SPEAKER/STROBE</td> </tr> <tr> <td>GLASS BREAK DETECTOR</td> </tr> <tr> <td>CEL. MTD MOTION DETECTOR</td> </tr> <tr> <td>WALL MTD MOTION DETECTOR</td> </tr> <tr> <td>CEL. MTD SECURITY SPEAKER</td> </tr> <tr> <td>WALL MTD SECURITY SPEAKER</td> </tr> <tr> <td>CEL. MTD AV SPEAKER</td> </tr> <tr> <td>WALL MTD AV SPEAKER</td> </tr> <tr> <td>SECURITY CAMERA</td> </tr> <tr> <td>CLG MTD SMOKE/HEAT DETECTOR</td> </tr> <tr> <td>CLG MTD EXT</td> </tr> <tr> <td>WALL MTD EXT</td> </tr> <tr> <td>CLG MTD SPRINKLER HEAD</td> </tr> <tr> <td>WALL MTD SPRINKLER HEAD</td> </tr> <tr> <td>RETURN OUTLET CLG DIFFUSER</td> </tr> <tr> <td>SUPPLY OUTLET CLG DIFFUSER</td> </tr> <tr> <td>LINEAR SUPPLY DIFFUSER</td> </tr> <tr> <td>WIRELESS ALARM ANTENNA/ TRANSMITTER</td> </tr> <tr> <td>TELEVISION OUTLET</td> </tr> </table>	FLOOR/CEILING OUTLET	SPEAKER/STROBE	GLASS BREAK DETECTOR	CEL. MTD MOTION DETECTOR	WALL MTD MOTION DETECTOR	CEL. MTD SECURITY SPEAKER	WALL MTD SECURITY SPEAKER	CEL. MTD AV SPEAKER	WALL MTD AV SPEAKER	SECURITY CAMERA	CLG MTD SMOKE/HEAT DETECTOR	CLG MTD EXT	WALL MTD EXT	CLG MTD SPRINKLER HEAD	WALL MTD SPRINKLER HEAD	RETURN OUTLET CLG DIFFUSER	SUPPLY OUTLET CLG DIFFUSER	LINEAR SUPPLY DIFFUSER	WIRELESS ALARM ANTENNA/ TRANSMITTER	TELEVISION OUTLET
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2. SEE M.E.P. AND SECURITY DRAWINGS FOR ELECTRICAL, MECHANICAL, FIRE PROTECTION AND SECURITY DEVICE LOCATIONS IN THE FOLLOWING ROOMS: JANITORS, CLOSETS, ELECTRICAL CLOSETS, TELEPHONE AND DATA CLOSETS, AV STORAGE CLOSETS, KITCHENS AND GENERAL STORAGE ROOMS.																																				
3. NOTIFY THE ARCHITECT IN THE EVENT OF ANY DISCREPANCIES BETWEEN THE MECHANICAL, ELECTRICAL, PLUMBING, FIRE PROTECTION, AND SECURITY DRAWINGS AND THE REFLECTED CEILING PLANS. THE ARCHITECTURAL CEILING PLANS SHALL GOVERN ALL LOCATIONS AND DIMENSIONS OF ALL EXPOSED-TO-VIEW ITEMS. DO NOT PROCEED UNTIL DISCREPANCIES HAVE BEEN RESOLVED.																																				
4. FOR CEILING TYPE AND LOCATION OF FINISH REFER TO FINISH SCHEDULE.																																				
5. FOR CEILING HEIGHTS IN STAIRS SEE STAIR DETAILS.																																				
6. START POINT OF CEILING GRID SHALL BE CENTER OF TILE AT CENTER OF ROOM U.O.N.																																				
7. WHEN ACOUSTICAL CEILING TILE EXCEEDS 2 X 2 PROVIDE 2 X 4 ACOUSTICAL CEILING TILE TO BE FIELD CUT.																																				
8. ALL CEILING MOUNTED DEVICES INCLUDING EXIT SIGNS-NOT ADJACENT TO DOORS-SMOKE DETECTORS LIGHT FIXTURES SHALL BE CENTERED ON CEILING TILE U.O.N.																																				
9. ALL FIRE STROBES SHALL BE LOCATED 6 1/2" FROM THE STROBE U.O.N. ON EITHER THE REFLECTED CEILING PLANS OR THE INTERIOR ELEVATIONS.																																				
10. STEM AND PENDANT MOUNTED FIXTURES SHALL BE INSTALLED AT HEIGHT (BOTTOM OF FIXTURE AFF.) INDICATED IN THE SPECIFICATIONS.																																				

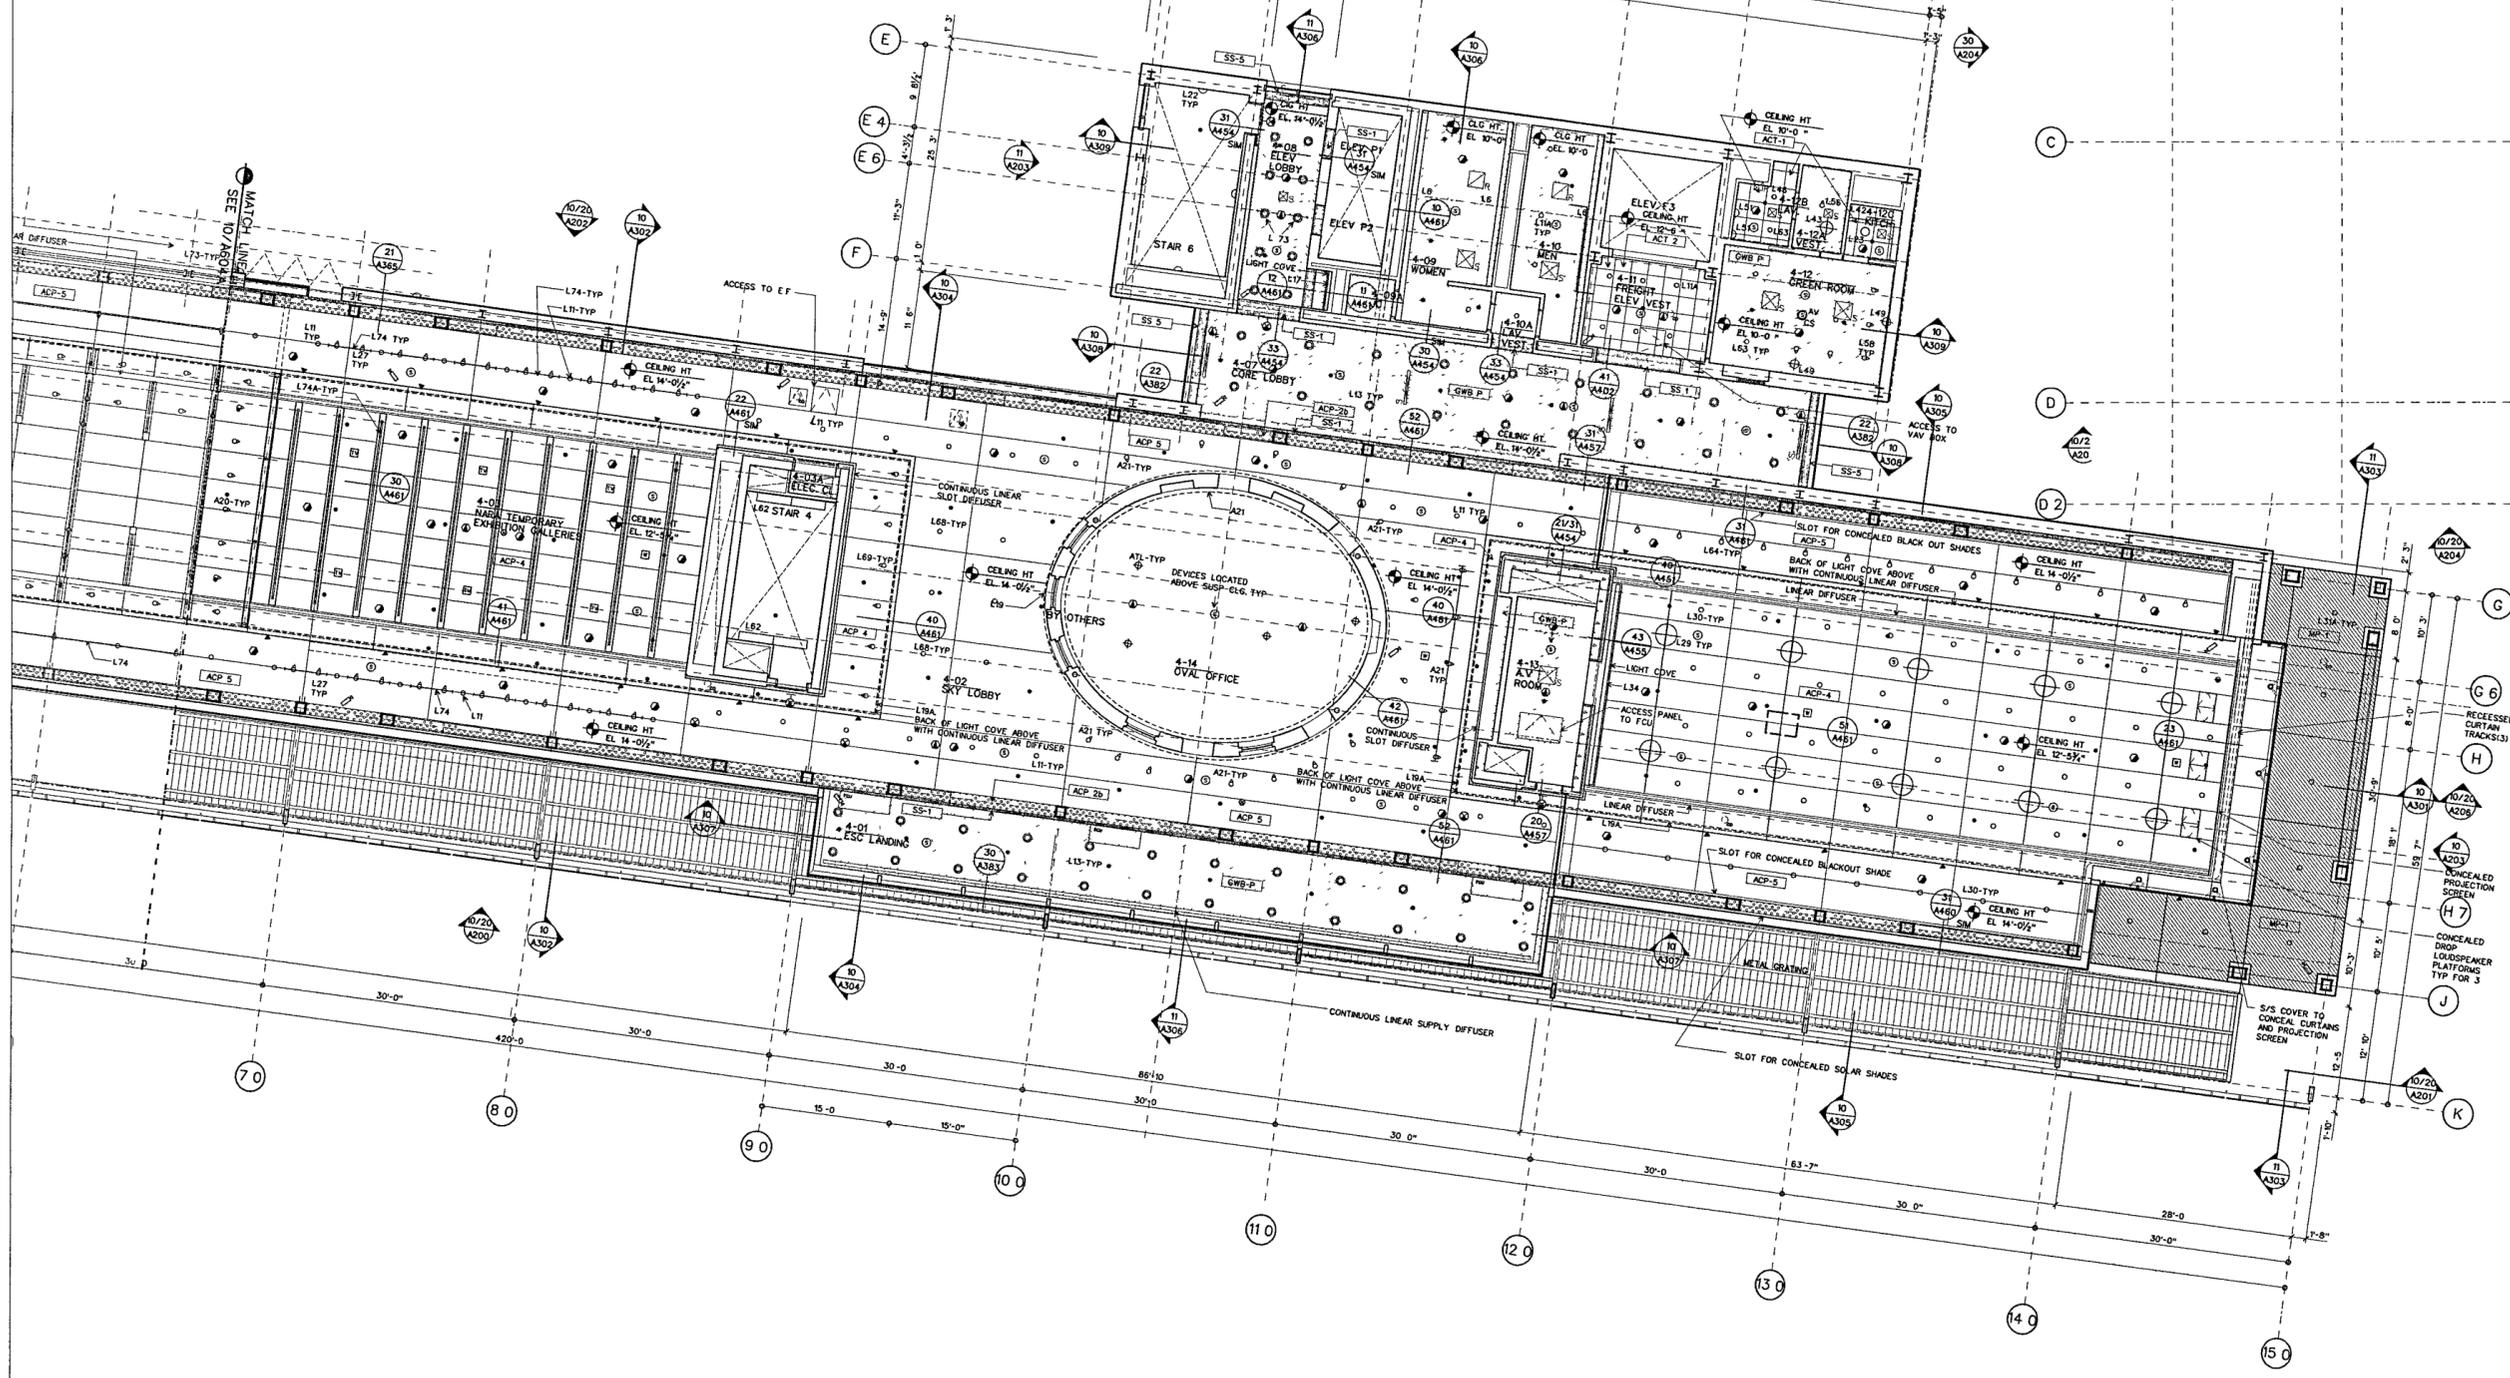

UPPER MUSEUM LEVEL REFLECTED CEILING PLAN B  
SCALE 1/8" = 1'-0"

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CENTER**

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Issue	Date
100% Construction Documents	09/27/02
90% Progress Printing	08/30/02
100% Struct/CD Progress	07/01/02
100% Steel & Concrete CD	05/15/02
& Architectural CD Progress	
100% Design Development	03/01/02

Job No. 9908  
Scale 1/8" = 1'-0"  
Date September 27, 2002  
Title MUSEUM UPPER LEVEL PARTIAL REFLECTED CEILING PLAN  
Sheet No. A604b

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