

**WILLIAM J CLINTON
PRESIDENTIAL
CENTER**

LITTLE ROCK, ARKANSAS

Architect

POLSHEK PARTNERSHIP LLP
320 West 13th Street
New York, New York 10014
212.607.7171

Coordinating Architects

POLK STANLEY YEARY ARCHITECTS LTD
700 South Schiller Street
Little Rock, Arkansas 72201
501.378.0878

WITSELL EVANS RASCO
2200 South Main Street
Little Rock, Arkansas 72201
501.374.5300

WOODS CARADINE ARCHITECTS
2200 South Main Street
Little Rock, Arkansas 72206
501.374.4060

Landscape Architects

HARGREAVES ASSOCIATES
118 Magazine Street
Cambridge Massachusetts 02139
617.661.0070

LANDSCAPE ARCHITECTURE, Inc.
2300 Cottontail Lane Suite 202
Little Rock, Arkansas 72202
501.374.5810

Structural Engineer

LESLIE E. ROBERTSON ASSOC., RLLP
30 Broad Street, 47th Floor
New York, New York 10004
212.750.9000

MEP Engineers

FLACK + KURTZ Inc.
475 Fifth Avenue
New York, New York 10017
212.532.9600

CROMWELL ARCHITECTS ENGINEERS
101 South Spring Street
Little Rock, Arkansas 72201
501.372.2800


Curtilwall Consultant

R. A. HEINTGES ARCHITECTS
126 Fifth Avenue 9th Floor
New York, New York 10011
212.652-2968

Seal



100% Construction Documents	06/27/02
90% Progress Printing	06/30/02
100% Struct./ CD Progress	07/01/02
100% Steel & Concrete CD	05/15/02
& Architectural CD Progress	
100% Design Development	03/01/02
Issue	Date

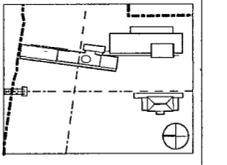


Job No 9908
Scale 1/8" = 1'-0"
Date September 27, 2002
Title

**SECOND LEVEL
PARTIAL REFLECTED
CEILING PLAN**

Sheet No
A602a

NOTE	KEY	RCP DEVICE KEY
1 THESE DRAWINGS SUPPLEMENT INFORMATION ON THE M.E.P./P. AND SECURITY DRAWINGS AND ARE TO BE USED FOR DIMENSIONAL LOCATION OF ALL M.E.P./P. AND SECURITY SYSTEMS. ALL M.E.P./P. AND SECURITY SYSTEMS SCOPE AND CONTENTS SHALL BE PER M.E.P. AND SECURITY DRAWINGS.	EXPOSED AND SEALED SLAB	FLOOR/CEILING OUTLET
2 SEE M.E.P. AND SECURITY DRAWINGS FOR ELECTRICAL, MECHANICAL, FIRE PROTECTION AND SECURITY DEVICE LOCATIONS IN THE FOLLOWING ROOMS: JANITOR'S CLOSETS, ELECTRICAL CLOSETS, TELEPHONE, AND DATA CLOSETS, AV STORAGE CLOSETS, KITCHENS AND GENERAL STORAGE ROOMS.	PTD GWB	SPEAKER/STROBE
3 NOTIFY THE ARCHITECT IN THE EVENT OF ANY DISCREPANCIES BETWEEN THE MECHANICAL, ELECTRICAL, PLUMBING, FIRE PROTECTION AND SECURITY DRAWINGS AND THE REFLECTED CEILING PLANS. THE ARCHITECTURAL, CEILING PLANS SHALL GOVERN ALL LOCATIONS AND DIMENSIONS OF ALL EXPOSED-TO-VIEW ITEMS. DO NOT PROCEED UNTIL DISCREPANCIES HAVE BEEN RESOLVED.	PERFORATED WOOD ACOUSTICAL PANEL W/ BATT INSULATION	GLASS BREAK DETECTOR
4 FOR CEILING TYPE AND LOCATION OF FINISH REFER TO FINISH SCHEDULE.	PAINTED ALUMINUM PANEL SYSTEM	CEL. MTD MOTION DETECTOR
5 FOR CEILING HEIGHTS IN STAIRS SEE STAIR DETAILS.	EXPOSED AND SEALED WAFFLE SLAB	CEL. MTD MOTION DETECTOR
6 START POINT OF CEILING GRID SHALL BE CENTER OF TILE AT CENTER OF ROOM U.O.N.	ORNAMENTAL GLASS AND METAL CANOPY	CEL. MTD SECURITY SPEAKER
7 WHEN ACOUSTICAL CEILING TILE EXCEEDS 2 X 2 PROVIDE 2 X 4 ACOUSTICAL CEILING TILE TO BE FIELD CUT.	STAINLESS STEEL FINISH	WALL MTD SECURITY SPEAKER
8 ALL CEILING MOUNTED DEVICES (INCLUDING EXIT SIGNS-NOT ADJACENT TO DOORS, SMOKE DETECTORS, LIGHT FIXTURES) SHALL BE CENTERED ON CEILING TILE U.O.N.		CEL. MTD AV SPEAKER
9 ALL FIRE STROBES SHALL BE LOCATED 6 1/4" FROM THE ADJACENT DOOR FRAME TO THE CENTERLINE OF THE STROBE U.O.N. ON EITHER THE REFLECTED CEILING PLANS OR THE INTERIOR ELEVATIONS.		WALL MTD AV SPEAKER
10 STEM AND PENDANT MOUNTED FIXTURES SHALL BE INSTALLED AT HEIGHT (BOTTOM OF FIXTURE AFF.) INDICATED IN THE SPECIFICATIONS.		SECURITY CAMERA
		CEL. MTD SMOKE/HEAT DETECTOR
		CEL. MTD EXIT
		WALL MTD EXIT
		CEL. MTD SPRINKLER HEAD
		WALL MTD SPRINKLER HEAD
		RETURN OUTLET CLG DIFFUSER
		SUPPLY OUTLET CLG DIFFUSER
		LINEAR SUPPLY DIFFUSER
		WIRELESS ALARM ANTENNA/TRANSMITTER
		TELEVISION OUTLET

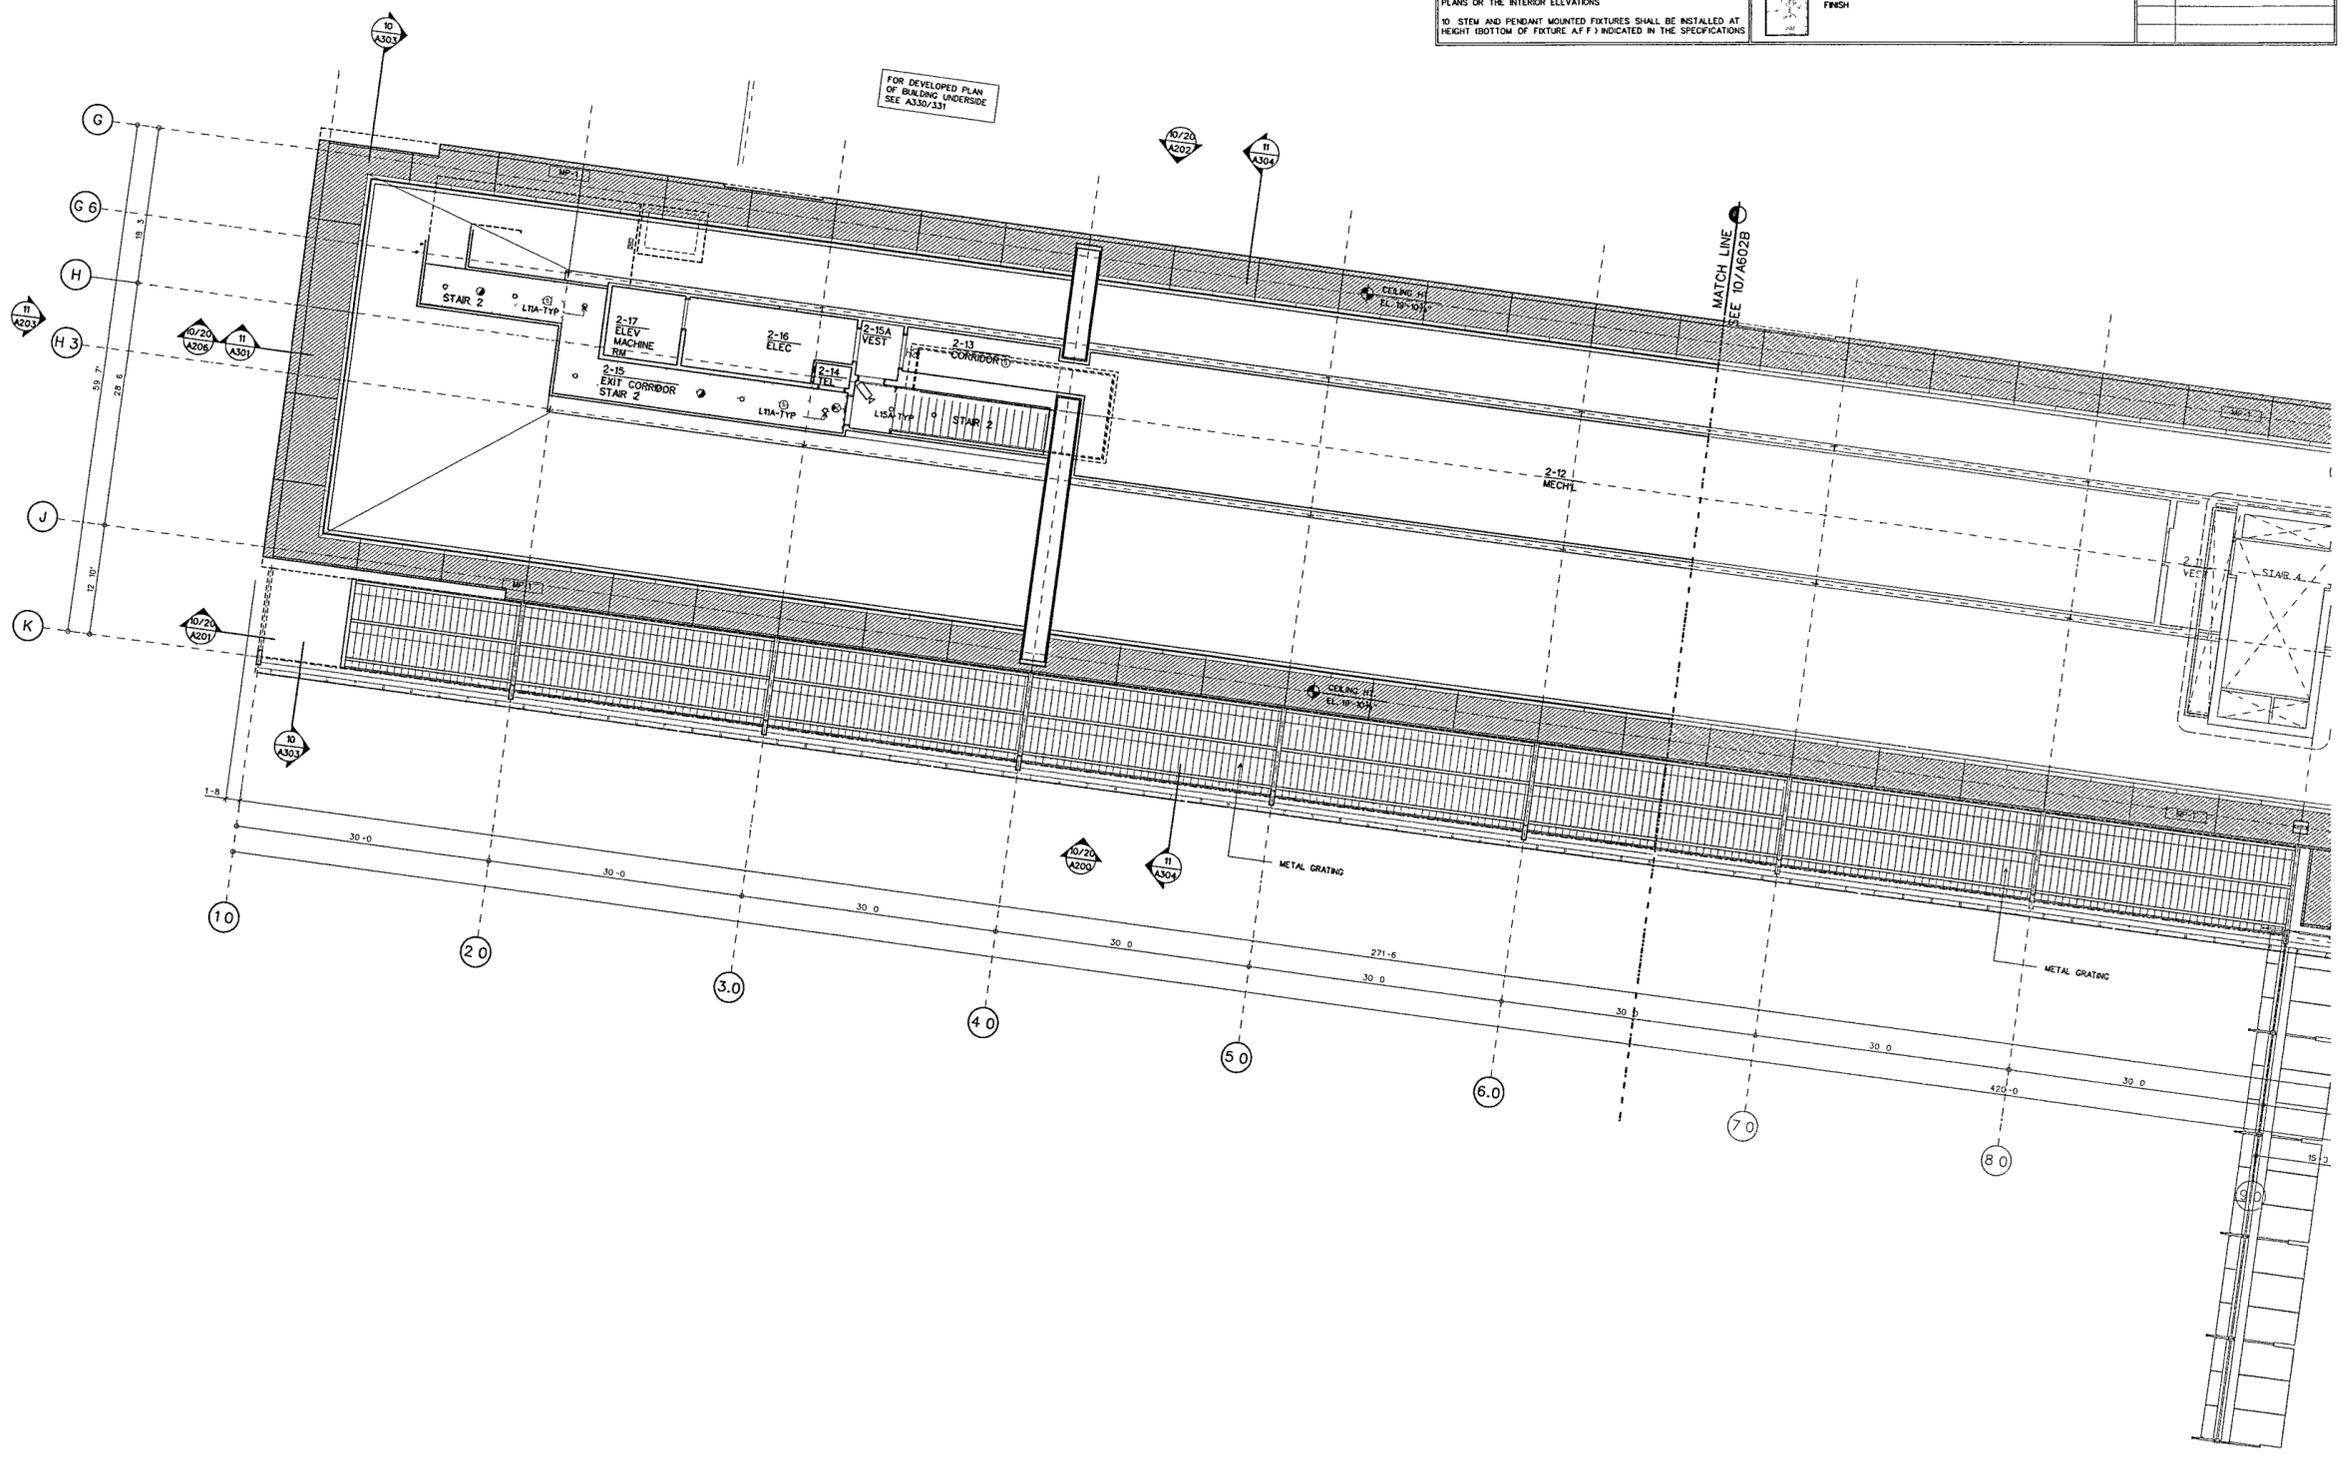

SECOND LEVEL REFLECTED CEILING PLAN A
SCALE 1/8" = 1'-0"

RCP-02 DGN 10

FOR OFFICIAL USE ONLY