

NOTE


1. THESE DRAWINGS SUPPLEMENT INFORMATION ON THE M.E.P./P. AND SECURITY DRAWINGS AND ARE TO BE USED FOR DIMENSIONAL LOCATION OF ALL M.E.P./P. AND SECURITY SYSTEMS SHALL BE PER M.E.P. AND SECURITY DRAWINGS.
2. SEE M.E.P. AND SECURITY DRAWINGS FOR ELECTRICAL, MECHANICAL, FIRE PROTECTION AND SECURITY DEVICE LOCATIONS IN THE FOLLOWING ROOMS: JANITORS CLOSETS, ELECTRICAL CLOSETS, TELEPHONE AND DATA CLOSETS, AV STORAGE CLOSETS, KITCHENS AND GENERAL STORAGE ROOMS.
3. NOTIFY THE ARCHITECT IN THE EVENT OF ANY DISCREPANCIES BETWEEN THE MECHANICAL, ELECTRICAL, PLUMBING, FIRE PROTECTION AND SECURITY DRAWINGS AND THE REFLECTED CEILING PLANS. THE ARCHITECTURAL CEILING PLANS SHALL GOVERN ALL LOCATIONS AND DIMENSIONS OF ALL EXPOSED-TO-VIEW ITEMS. DO NOT PROCEED UNTIL DISCREPANCIES HAVE BEEN RESOLVED.
4. FOR CEILING TYPE AND LOCATION OF FINISH REFER TO FINISH SCHEDULE.
5. FOR CEILING HEIGHTS IN STARS SEE STAR DETAILS.
6. START POINT OF CEILING GRID SHALL BE CENTER OF TILE AT CENTER OF ROOM U.O.N.
7. WHEN ACOUSTICAL CEILING TILE EXCEEDS 2 X 2 PROVIDE 2 X 4 ACOUSTICAL CEILING TILE TO BE FIELD CUT.
8. ALL CEILING MOUNTED DEVICES (INCLUDING EXIT SIGNS-NOT ADJACENT TO DOORSMOKE DETECTORS LIGHT FIXTURES) SHALL BE CENTERED ON CEILING TILE U.O.N.
9. ALL FIRE STROBES SHALL BE LOCATED 6 1/2" FROM THE ADJACENT DOOR FRAME TO THE CENTERLINE OF THE STROBE U.O.N. ON EITHER THE REFLECTED CEILING PLANS OR THE INTERIOR ELEVATIONS.
10. STEM AND PENDANT MOUNTED FIXTURES SHALL BE INSTALLED AT HEIGHT (BOTTOM OF FIXTURE AFF.) INDICATED IN THE SPECIFICATIONS.

KEY

[Symbol]	EXPOSED AND SEALED SLAB	[Symbol]	PLASTER FINISH
[Symbol]	PTD GWB	[Symbol]	2 X 2 CLG TILES NOTE: WASHABLE SURFACE IN ALL KITCHEN/PANTRY AREAS
[Symbol]	PERFORATED WOOD ACOUSTICAL PANEL W/ BATT INSULATION	[Symbol]	PERFORATED METAL ACOUSTICAL PANEL OR AIR REGISTER WHERE NOTED
[Symbol]	PAINTED ALUMINUM PANEL SYSTEM	[Symbol]	RESSED WOOD ACOUSTICAL PANEL
[Symbol]	EXPOSED AND SEALED WAFFLE SLAB	[Symbol]	ARCHITECTURAL ACOUSTICAL PANELS
[Symbol]	ORNAMENTAL GLASS AND METAL CANOPY	[Symbol]	FIELD FINISHED MINERAL FIBER ACOUSTICAL PANEL OVER GYP BD CEILING ASSEMBLY
[Symbol]	STAINLESS STEEL FINISH		

RCP DEVICE KEY

[Symbol]	FLOOR/CEILING OUTLET
[Symbol]	SPEAKER/STROBE
[Symbol]	GLASS BREAK DETECTOR
[Symbol]	CEL. MTD MOTION DETECTOR
[Symbol]	WALL MTD MOTION DETECTOR
[Symbol]	CEL. MTD SECURITY SPEAKER
[Symbol]	WALL MTD SECURITY SPEAKER
[Symbol]	CEL. MTD AV SPEAKER
[Symbol]	WALL MTD AV SPEAKER
[Symbol]	SECURITY CAMERA
[Symbol]	CLG MTD SMOKE/HEAT DETECTOR
[Symbol]	CLG MTD EXIT
[Symbol]	WALL MTD EXIT
[Symbol]	CLG MTD SPRINKLER HEAD
[Symbol]	WALL MTD SPRINKLER HEAD
[Symbol]	RETURN OUTLET CLG DIFFUSER
[Symbol]	SUPPLY OUTLET CLG DIFFUSER
[Symbol]	LINEAR SUPPLY DIFFUSER
[Symbol]	WIRELESS ALARM ANTENNA/ TRANSMITTER
[Symbol]	TELEVISION OUTLET

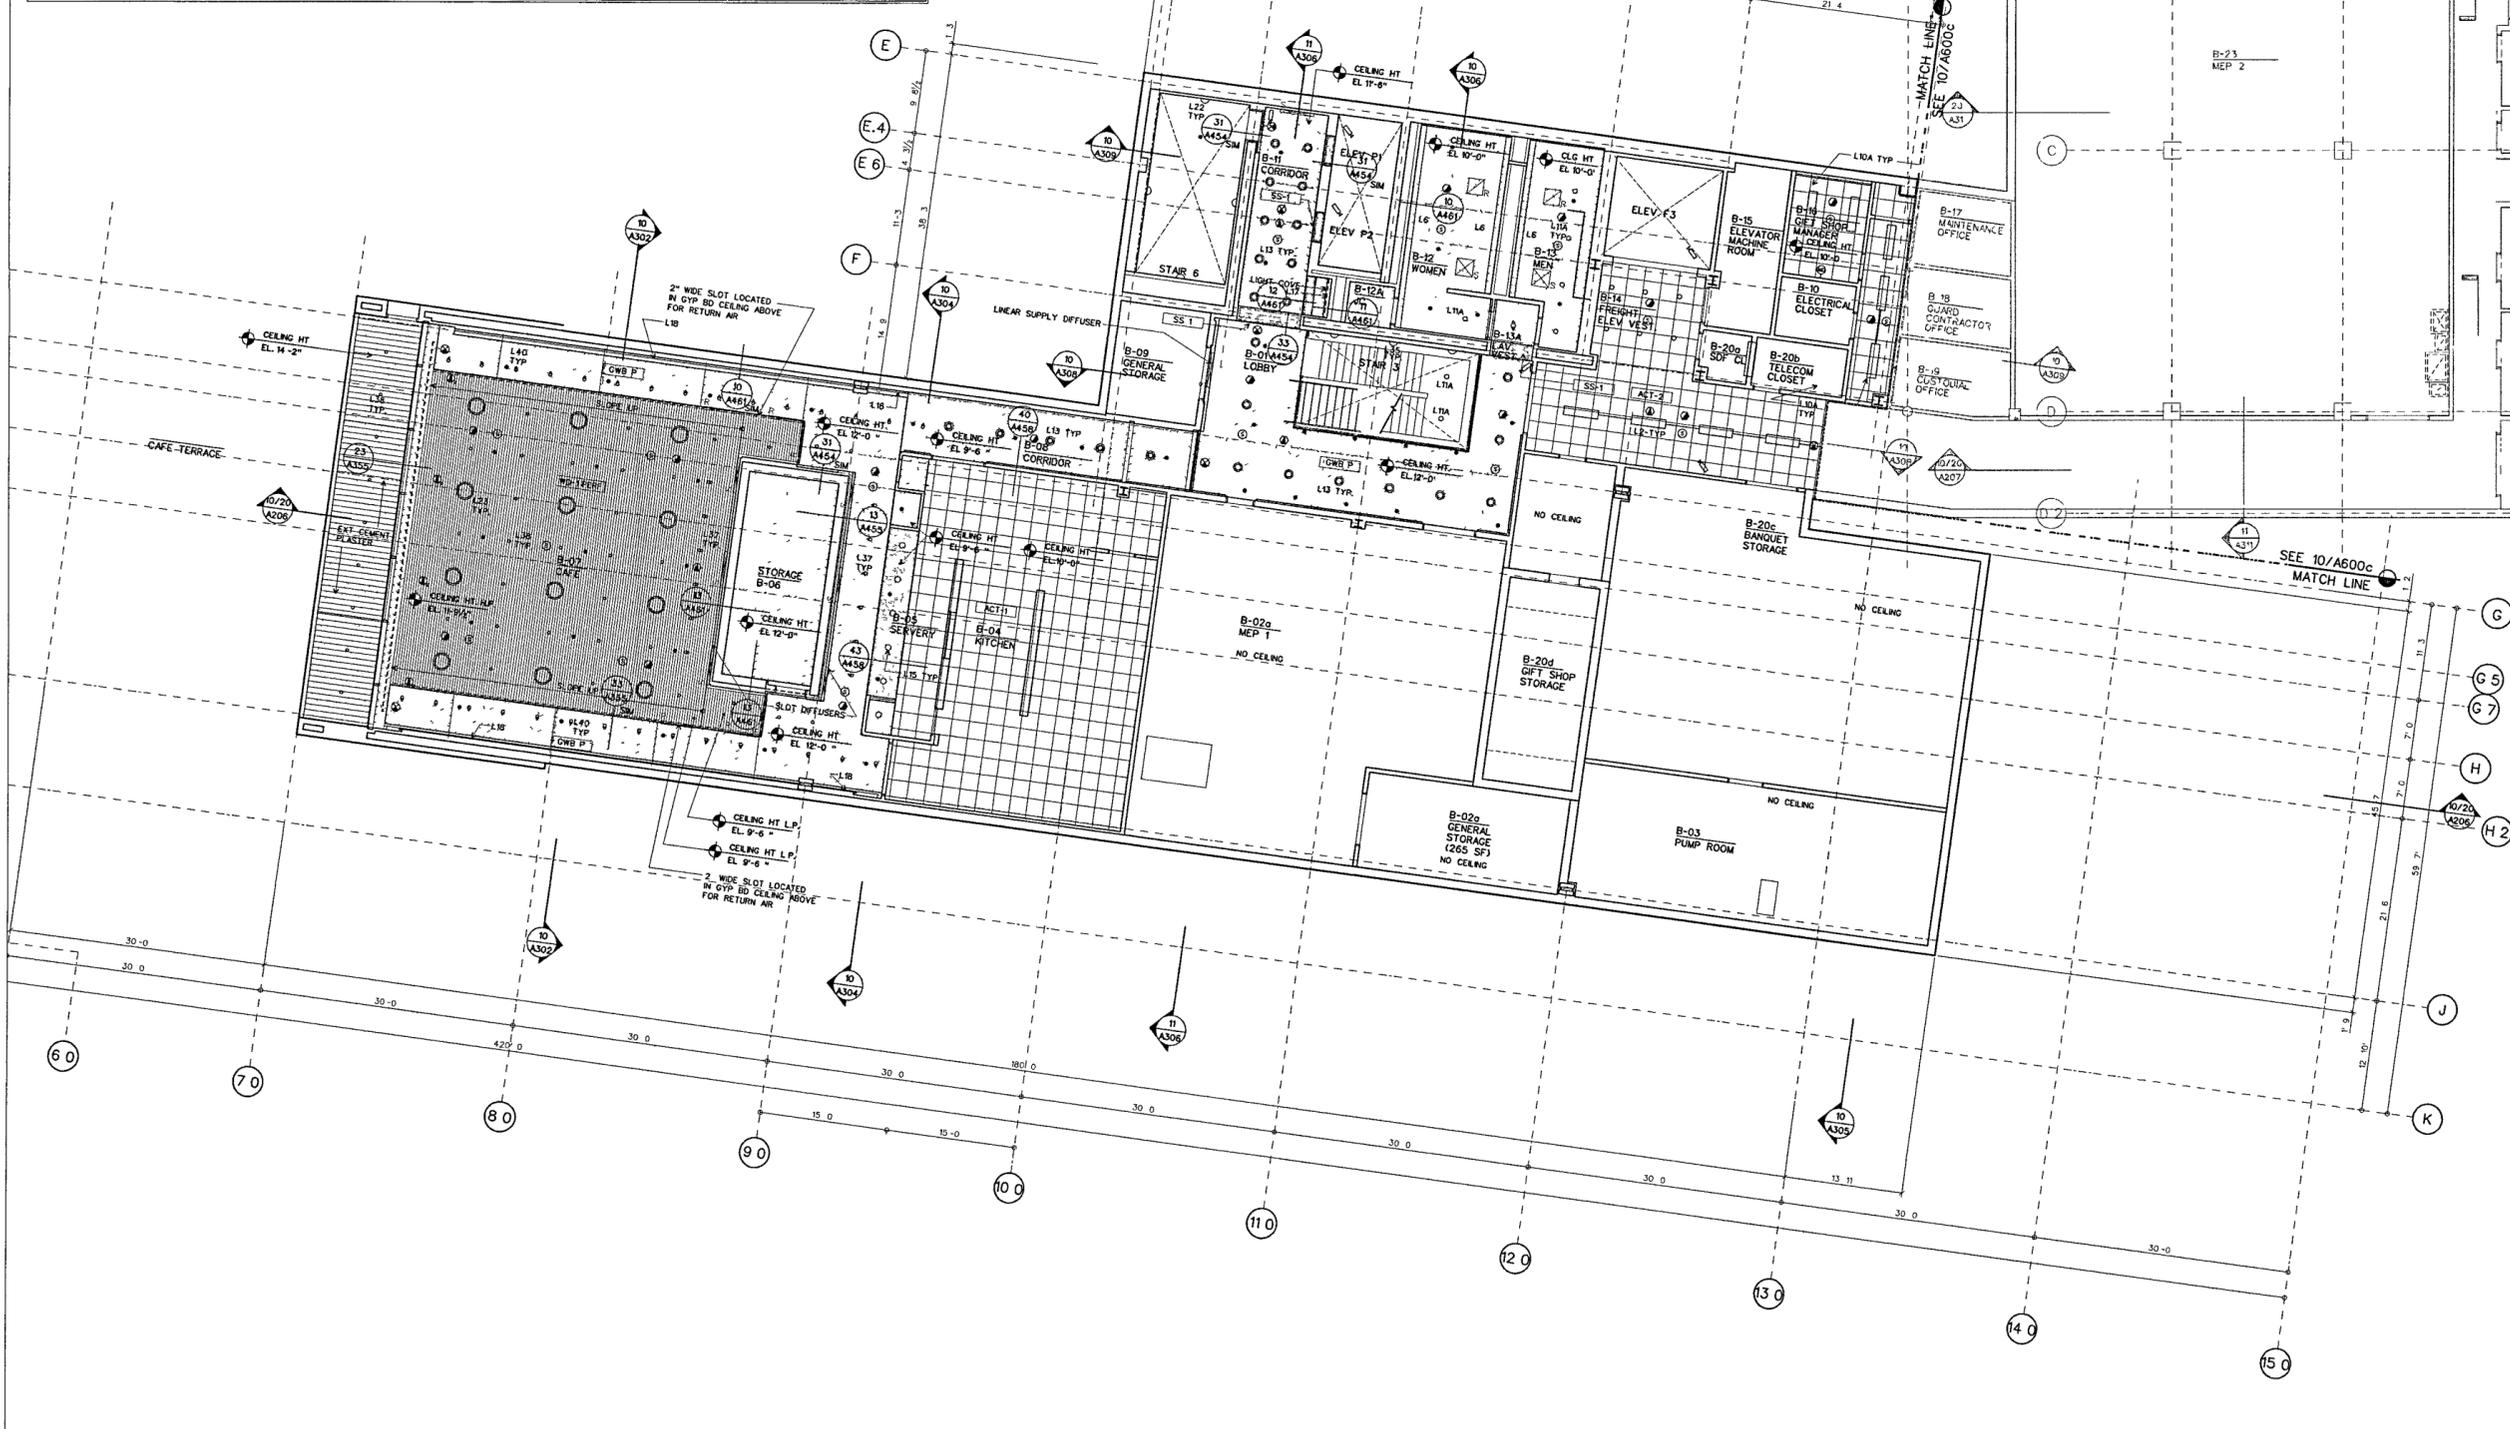

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Seal


100% Construction Documents	09/27/02
90% Progress Printing	08/30/02
100% Struct/CD Progress	07/01/02
Bridge Bldg Substructure	06/14/02
100% Steel & Concrete CD	05/15/02
& Architectural CD Progress	
100% Design Development	03/01/02
Issue	Date

Job No. 9908
 Scale 1/8" = 1'-0"
 Date September 27, 2002
 Title
**BASEMENT LEVEL
PARTIAL REFLECTED
CEILING PLAN**
 Sheet No. **A600b**

BASEMENT LEVEL REFLECTED CEILING PLAN B
 SCALE 1/8" = 1'-0"

RCP-008 DGN 10

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