

**WILLIAM J CLINTON
PRESIDENTIAL
CENTER**

LITTLE ROCK, ARKANSAS

Architect

POLSHEK PARTNERSHIP LLP
320 West 13th Street
New York, New York 10014
212 607 7171

Coordinating Architects

POLK STANLEY YEARY ARCHITECTS LP
700 South Schiller Street
Little Rock, Arkansas 72201
501 378 0878

WITSELL EVANS RASCO
901 West Third Street
Little Rock, Arkansas 72201
501 374 5300

WOODS CARADINE ARCHITECTS
2200 South Main Street
Little Rock, Arkansas 72206
501 374 4060

Landscape Architects

HARGREAVES ASSOCIATES
115 Magazine Street
Cambridge, Massachusetts 02139
617 661 0070

LANDSCAPE ARCHITECTURE, INC.
2300 Cottonville Lane Suite 202
Little Rock, Arkansas 72202
501 374 5610

Structural Engineer

LESLIE E ROBERTSON ASSOC, RLLP
30 Broad Street, 47th Floor
New York, New York 10004
212 750 9000

MEP Engineers


FLACK + KURTZ Inc.
475 Fifth Avenue
New York, New York 10017
212 532 9600

CROMWELL ARCHITECTS ENGINEERS
101 South Spring Street
Little Rock, Arkansas 72201
501 372 2900


Curtainwall Consultant

R. A. HEINTGES ARCHITECTS
126 Fifth Avenue 5th Floor
New York, New York 10011
212 652 2966

Seal

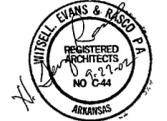

100% Construction Documents	09/27/02
90% Progress Printing	08/30/02
100% Struct./CD Progress	07/01/02
Bridge Bldg. Substructure	06/14/02
100% Steel & Concrete CD	05/15/02
& Architectural CD Progress	
100% Design Development	03/01/02
Issue	Date

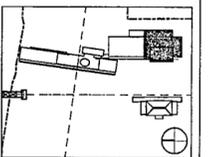

Job No. 9908

Scale 1/8" = 1'-0"

Date September 27, 2002


Title

ROOF PARTIAL PLAN

Sheet No.

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- GENERAL NOTES
1. MIN THICKNESS FOR LT WT CONC FILL @ ROOF DRAINS IS 2" MAXIMUM FILL THICKNESS FOR MAIN ROOF OVER STORAGE BLDG IS 7" MAXIMUM FILL THICKNESS FOR ROOF OVER NORTH & SOUTH CORRIDORS IS 4"
 2. SLOPE TOP OF FILL 1/8" PER FOOT TO ROOF DRAINS TOP OF STRUCTURAL CONC. DECK IS LEVEL
 3. TOP OF FINISHED ROOF IS LEVEL FOR ALL IRMA SYSTEMS ROOF SLOPES SHOWN ARE FOR TOP OF ROOF MEMBRANE ONLY
 4. BOTTOM OF OVERFLOW SCUPPERS SHALL BE 2" ABOVE TOP OF ROOF MEMBRANE - SEE BOTTOM OF SCUPPER ELEV THIS SHEET

ROOF LEVEL FLOOR PLAN D

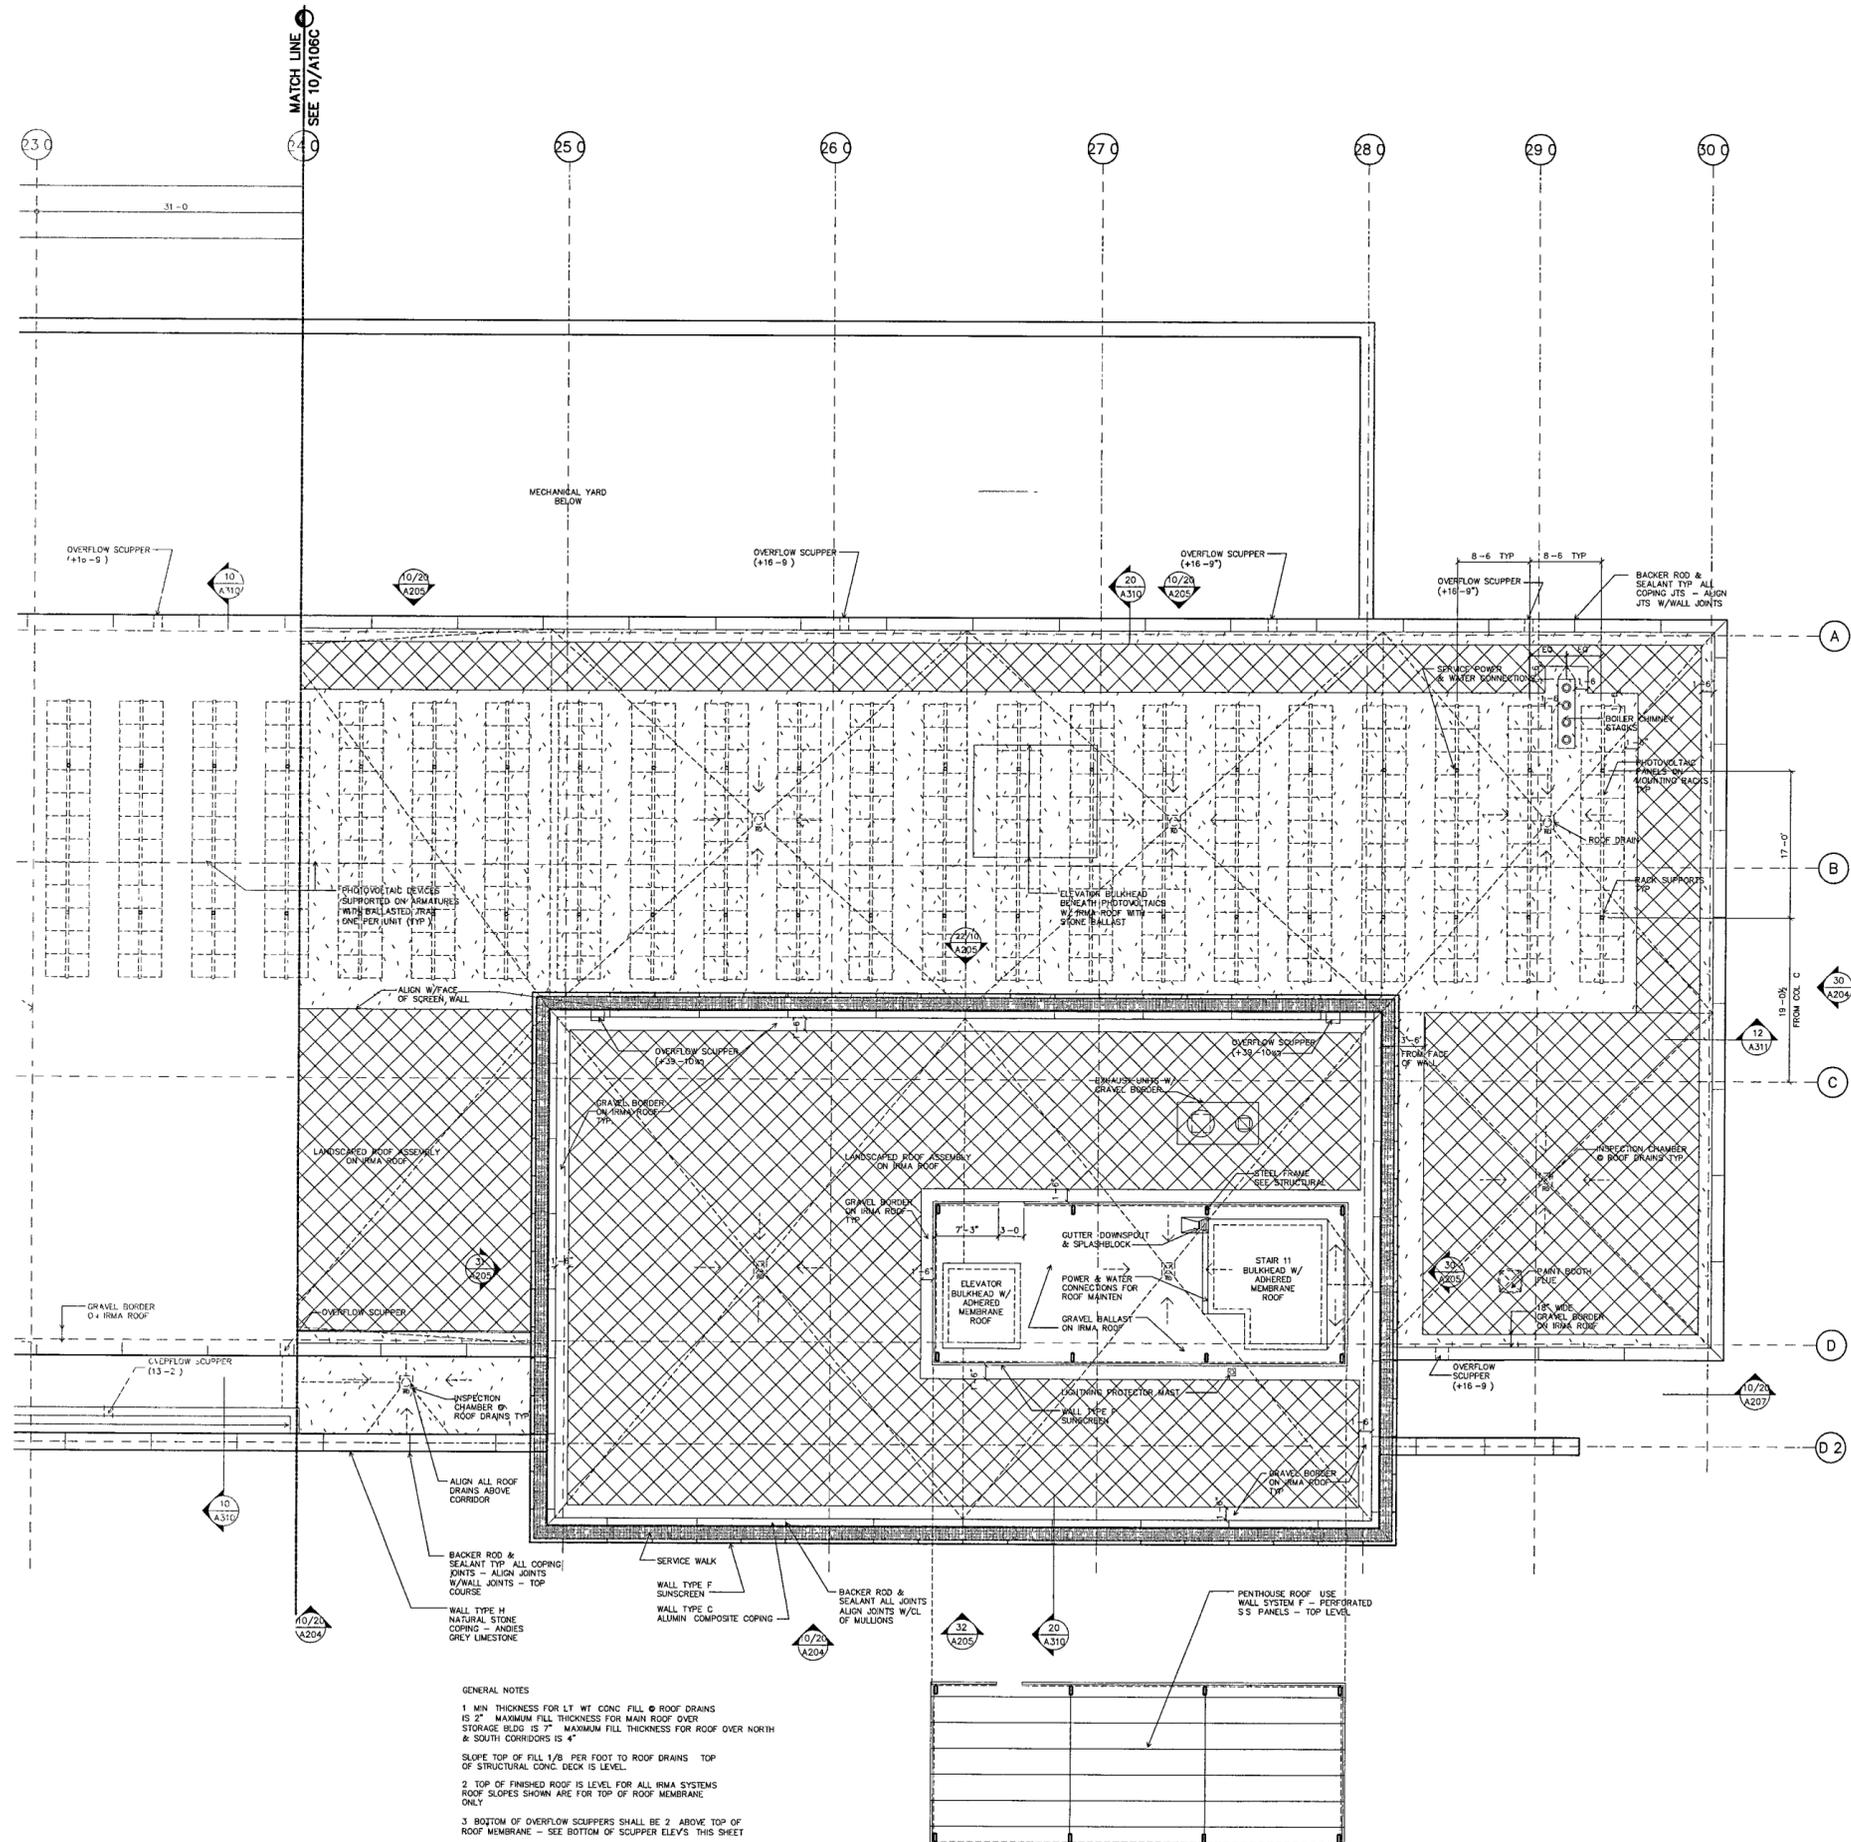SCALE 1/8" = 1'-0"

PENTHOUSE ROOF PLAN