

LITTLE ROCK, ARKANSAS

Architect
POLSHEK PARTNERSHIP LLP
320 West 13th Street
New York, New York 10014
212 607 7171

Landscape Architect



118 Magazine Street
Cambridge, Massachusetts 02138
617 681 0070 f
617 681 0064 f

Coordinating Landscape Architect
LANDSCAPE ARCHITECTURE, INC
2300 Cottondale Lane, Suite 202
Little Rock, Arkansas 72202
501 374.5810

Civil Engineer
McLELLAND CONSULTING ENGINEERS
900 W Markham Street
Little Rock, Arkansas 72201
501 371 0272

Electrical Engineer
CROMWELL ARCHITECTS ENGINEERS
101 South Spring Street
Little Rock, Arkansas 72201
501 372.2900

Marine + Structural Engineers
MORFITT & NICHOL ENGINEERS
616 East Millbrook Road, Suite 160
Raleigh, North Carolina 27609
919 781.6228


Fountain
DAN ELSER WATERARCHITECTURE INC.
58 Mackenzie Drive West
Richmond Hill, Ontario L4C 3S2
CANADA
905 884.4178

Playground Design
PLAY SITE ARCHITECTURE
7 Fairway Road
Acton, Massachusetts 01720
978 283 1030

Signage Design
POULIN + MORRIS
226 Spring Street, Sixth Floor
New York, New York 10013
212 875 1332



04 100% Site Package 2 CD	09/27/02
03 80% Site Package 2 CD	09/16/02
02 60% Site Package 2 CD	08/29/02
01 100% Design Development	04/01/02
Issue	Date

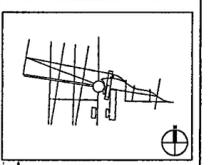

Job No. 4813

Scale 1" = 20'-0"

Date SEPTEMBER 27, 2002

Title SITE PACKAGE 2
100% CONSTRUCTION DOCUMENTS
Marine Edge Site Plan
Sheet 2 of 2



Sheet No. MC102

FOR OFFICIAL USE ONLY

WORK POINT TABLE					
WP No.	NORTHING	EASTING	WP No.	NORTHING	EASTING
5	151004.75	1234253.62	10	150750.14	1234552.30
6	150811.64	1234246.05	11	150718.25	1234699.87
7	150783.54	1234376.09	12	151094.10	1234623.38
8	150998.47	1234413.97	13-PC	151044.14	1234621.42
9	150992.67	1234561.81	14-PT	150742.57	1234862.17

LINE & CURVE TABLE			
DESC	BEARING	LENGTH	RADIUS
L5	S87°-45'-20"E	173.38'	-
L6	S02°-14'-40"W	193.26'	-
L7	N09°-59'-40"E	218.24'	-
L8	S87°-45'-20"E	147.95'	-
L9	S02°-14'-40"W	242.72'	-
L10	S77°-48'-25"E	150.97'	-
L11	S02°-14'-40"W	50.00'	-
C1	-	420.60'	295.00'

RAKER BEAM TABLE		
BEAM No.	STATION	DEFL. ANGLE
21	7+34.72	99°-57'-11"
22	7+57.03	92°-11'-55"
23	7+87.05	92°-11'-55"
24	8+17.08	92°-11'-55"
25	8+47.10	92°-11'-55"

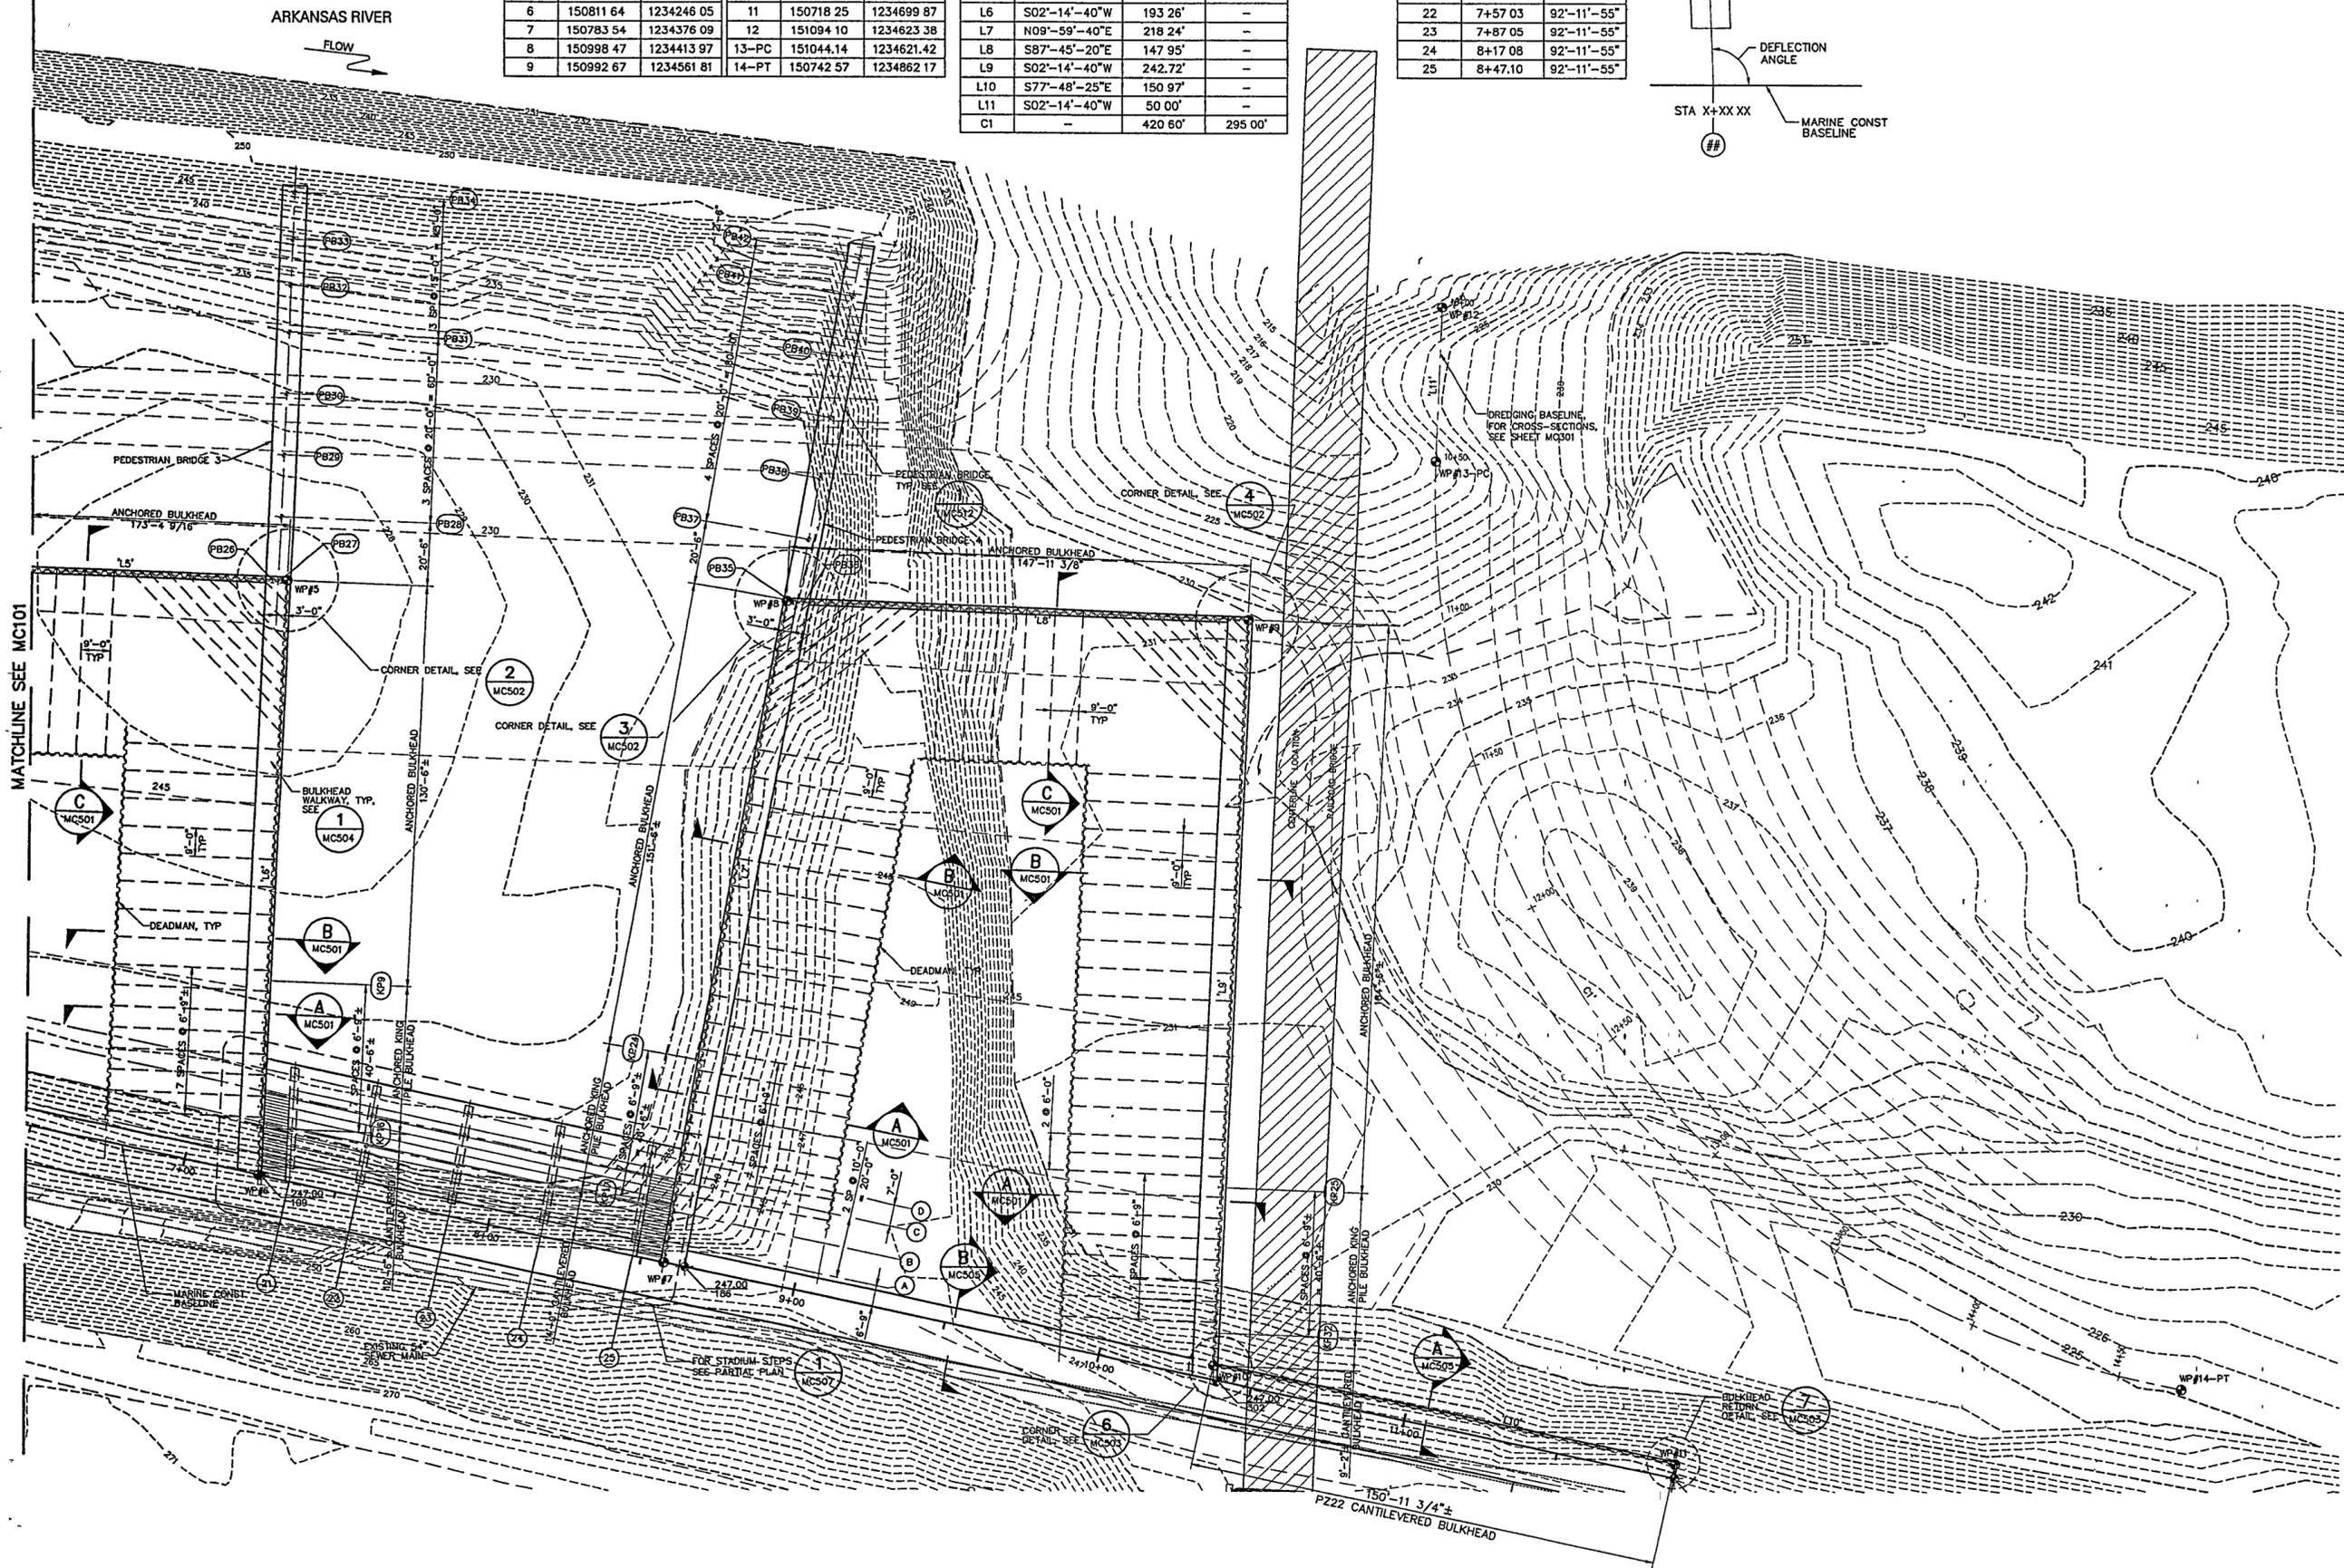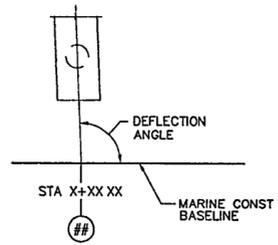

1" = 20'-0" 0 10 20 40 FT