


- GENERAL NOTES.**
- BEFORE INSTALLATION OF ANY DUCTWORK, THE CONTRACTOR SHALL COORDINATE ALL PLUMBING, FIRE PROTECTION, AND DUCTWORK ROUTING
 - REFER TO THE ARCHITECTURAL REFLECTED CEILING PLANS AND ELEVATIONS FOR EXACT LOCATION OF AIR DEVICES AND LOUVERS
 - ALL SUPPLY AND RETURN BRANCHES TO AND FROM AIR DEVICES IN AREAS WITH LAY-IN CEILING SHALL BE PROVIDED WITH A VOLUME DAMPER AT THE MAIN DUCT
 - PROVIDE 5'-0" MAXIMUM FLEX DUCT AT AIR DEVICES
 - VERIFY ROOM SENSOR (THERMOSTAT) LOCATIONS WITH THE CONSTRUCTION MANAGER
 - COORDINATE LOCATION OF CONDUITS IN BLOCK WALLS FOR ROOM SENSORS WITH CONSTRUCTION MANAGER. SURFACE MOUNTED CONDUIT IS NOT ALLOWED
 - PROVIDE DYNAMIC FIRE DAMPERS OF PROPER RATING AT ALL DUCT PENETRATIONS THROUGH RATED WALLS
 - PROVIDE ACCESS DOORS IN DRYWALL CEILINGS AS REQUIRED TO PROVIDE ACCESS FOR MAINTENANCE TO VALVES, DAMPERS, FIRE DAMPERS, ETC

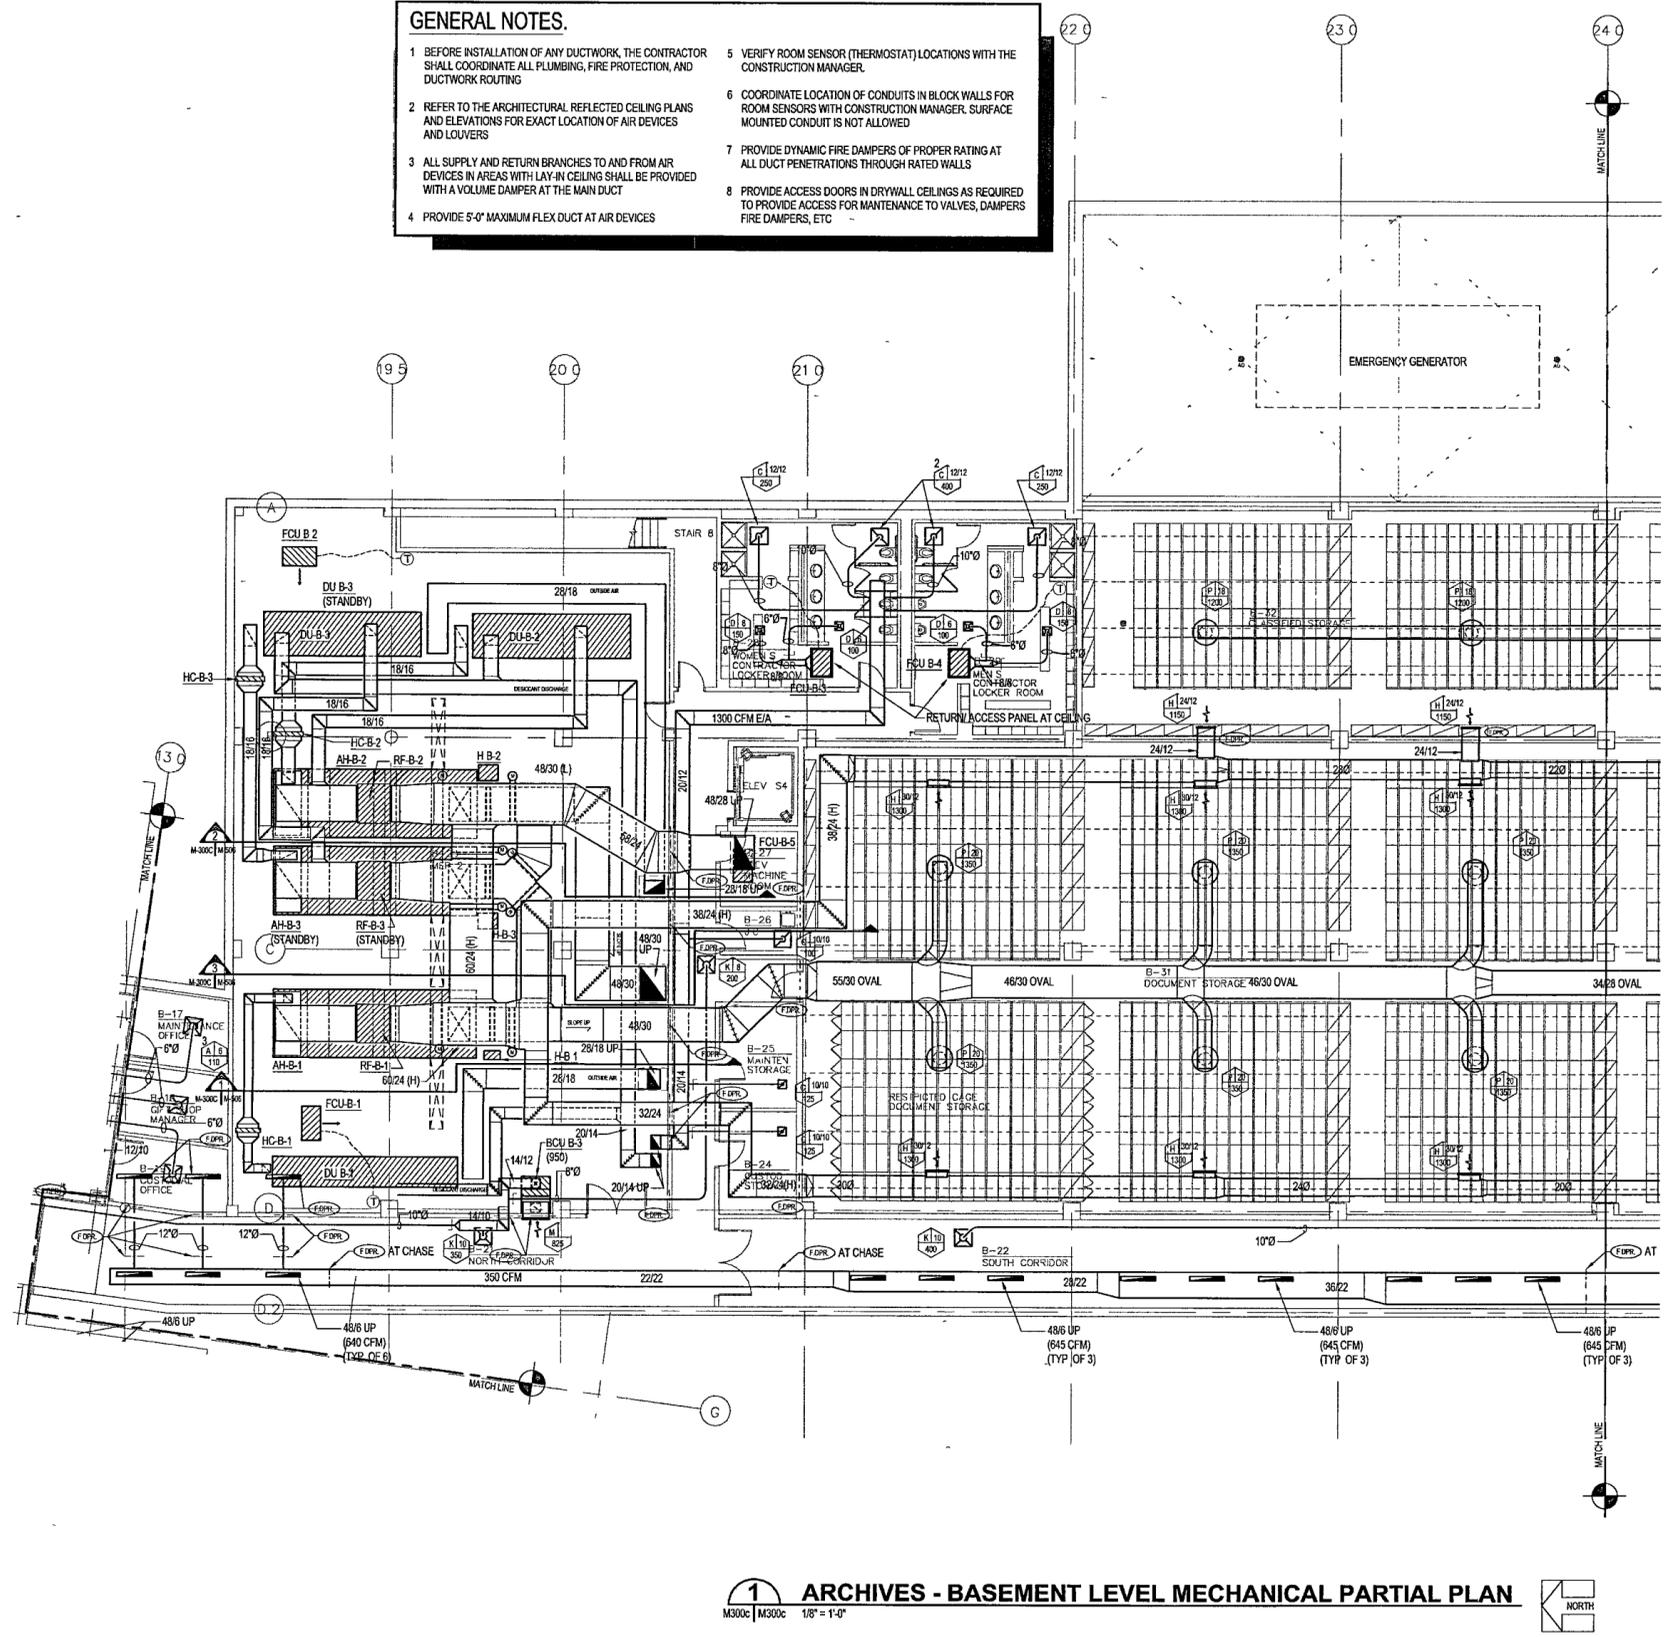

1 ARCHIVES - BASEMENT LEVEL MECHANICAL PARTIAL PLAN
 M300C | M300C | 1/8" = 1'-0"



**WILLIAM J CLINTON
 PRESIDENTIAL
 CENTER**

LITTLE ROCK, ARKANSAS

Architect
 POLSHEK PARTNERSHIP LLP
 520 West 13th Street
 New York, New York 10014
 212.807.7171

Coordinating Architects
 POLK STANLEY YEARY ARCHITECTS, Ltd
 700 South Sabine Street
 Little Rock, Arkansas 72201
 501.378.0878

WITSELL EVANS RASCO
 901 West Third Street
 Little Rock, Arkansas 72201
 501.374.5300

WOODS CARADINE ARCHITECTS
 2200 South Main Street
 Little Rock, Arkansas 72206
 501.374.4060

Landscape Architects
 HARGREAVES ASSOCIATES
 118 Magazine Street
 Cambridge, Massachusetts 02139
 617.651.0070


LANDSCAPE ARCHITECTURE, Inc.
 2300 Cottondale Lane Suite 202
 Little Rock, Arkansas 72202
 501.374.5510

Structural Engineer
 LESLIE E. ROBERTSON ASSOC. RLLP
 30 Broad Street, 4th Floor
 New York, New York 10004
 212.750.9000


MEP Engineers
 FLACK + KURTZ Inc.
 475 Fifth Avenue
 New York, New York 10017
 212.532.9600

CROMWELL ARCHITECTS ENGINEERS
 101 South Spring Street
 Little Rock, Arkansas 72201
 501.372.2900

Curtilwall Consultant
 R. A. HENTGES ARCHITECTS
 126 Fifth Avenue 9th Floor
 New York, New York 10011
 212.632.2966

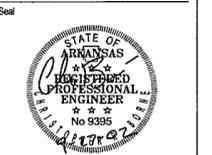

100% Construction Documents	09/27/02
90% Progress Printing	08/30/02
100% Design Development	03/01/02
Issue	Date

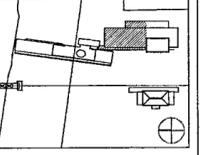


Job No: POLSHEK & PARTNERS ARCH 9908
 CROMWELL AE 99-114

Scale: 1/8" = 1'-0"

Date: SEPTEMBER 27, 2002

Title: ARCHIVES
 BASEMENT LEVEL
 MECHANICAL
 PARTIAL PLAN

Sheet No: **M300C**

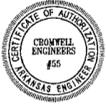

FOR OFFICIAL USE ONLY