

**HISTORIC ELEVATOR STABILIZATION WORK:**

EXISTING HISTORIC WIRE CAGE ELEVATORS IN MEN'S AND WOMEN'S STAIR HALLS TO BE STABILIZED BY CONTRACTOR. CABS TO BE MOVED AND STABILIZED AT THE FIRST FLOOR LEVEL AND FULLY SUPPORTED WITH STEEL BEAM TO NOT MOVE. WEIGHTS TO BE DISENGAGED AND FIXED IN PLACE. CABLES TO BE DISCONNECTED AND INSTALLED TO BE NON-WORKING AND FIXED IN PLACE. CONTRACTOR TO CLEAN UP ALL DEBRIS AND LOOSE EQUIPMENT OR PARTS FROM ELEVATOR PITS. ALL PARTS TO BE BOXED, LABELED, AND DELIVERED TO PARK STORAGE. CONTRACTOR TO EMPTY ALL OIL FROM MOTORS, IF EXISTING. SLIDING DOORS TO BE WELDED INTO PLACE AT ALL FLOOR LEVELS TO PREVENT ACCESS INTO SHAFT. ALL SECTIONS OF THE SHAFT WIRE CAGE TO BE REPAIRED WITH SECTIONS OF NEW METAL MESH PANELING WHERE WIRE MESH IS MISSING OR DAMAGED.


**GENERAL NOTES - TREATMENT:**

- A. DO NOT SCALE FROM THE DRAWINGS. ALL DIMENSIONS ARE APPROXIMATE. ACTUAL FIELD VERIFIED DIMENSIONS SHALL BE OBTAINED BY THE GENERAL CONTRACTOR OR THE APPLICABLE SUB-CONTRACTORS BEFORE SUBMITTING SHOP DRAWINGS, ORDERING MATERIALS, OR THE COMMENCEMENT OF CONSTRUCTION.
- B. THE GENERAL CONTRACTOR IS RESPONSIBLE FOR VERIFYING EXISTING CONDITIONS, IDENTIFYING ADDITIONAL TREATMENT WORK THAT MAY BE REQUIRED FOR THE INSTALLATION OF NEW WORK.
- C. THE CONTRACTOR SHALL FIELD VERIFY EXISTING CONDITIONS PRIOR TO COMMENCING ANY WORK. EXISTING CONDITIONS INCLUDE UTILITY LOCATIONS, EXISTING STRUCTURE LOCATIONS, AND EXISTING FIELD DIMENSIONS. THE ARCHITECT SHALL BE NOTIFIED OF ANY DISCREPANCIES DETRIMENTAL TO THE PROPER EXECUTION OF NEW WORK.


**KEYNOTES**

05.00	055213, 099123 - NORTH/SOUTH STAIRS: STRIP AND REPAINT EXISTING HISTORIC ELEVATOR CAGE TO REMAIN (ALL LEVELS - BASEMENT THROUGH 3RD FLOOR). PAINT WITH COLOR FROM HISTORIC PAINT ANALYSIS. MAKE REPAIRS TO ELEVATOR CAGE FOR SAFETY. REFERENCE VERTICAL CIRCULATION INTERIOR ELEVATION. REFER TO MATERIALS TEST REPORT FOR LEAD PAINT TESTING.
05.01	055213, 099123 - NORTH/SOUTH STAIRS: INSTALL METAL SUPPORT AT EXISTING ELEVATOR CAGE TO SUPPORT ANCHORING ON NEW HANDRAIL BRACKETS. PREP, PRIME, AND PAINT.
05.11	055213, 099123 - NORTH/SOUTH STAIR: INSTALL NEW ABAAS COMPLIANT STEEL HANDRAIL AT ALL LEVELS - BASEMENT THROUGH 3RD FLOOR. PREP, PRIME AND PAINT IN THE FIELD. ALL ANCHORS TO BE STAINLESS STEEL.
05.13	EXISTING ELEVATOR DOOR AT ALL FLOORS IS TO BE SECURED AND WELDED SHUT.
05.100	BASEMENT: INSTALL NEW METAL GATE AT ELEVATOR PIT OPENINGS (2 EA).
08.01	081113, 081433, 087100 - REFERENCE FLOOR PLANS, THE DOOR SCHEDULE, AND SPECIFICATIONS FOR WORK REQUIRED FOR DOORS.
09.52	SOUTH STAIRS: CLEAN ALL MARBLE TREADS AND LANDINGS (1 LS). BASIS OF DESIGN PROSOCO LIQUID MARBLE CLEANER, OR EQUAL, PER THE MANUFACTURER'S INSTRUCTIONS. REMOVE STAINING AND SOILING FROM MARBLE.
10.13	ADD ABA TEXTURED LOW VISION ANTI-SLIP TAPE ALONG TREAD EDGE. TYPICAL FOR ALL INTERIOR STAIRS.

**1**  
**A5.2** Enlarged Plan - South Stairs and Elevator Basement Plan  
1/2" = 1'-0" SCALE (A)

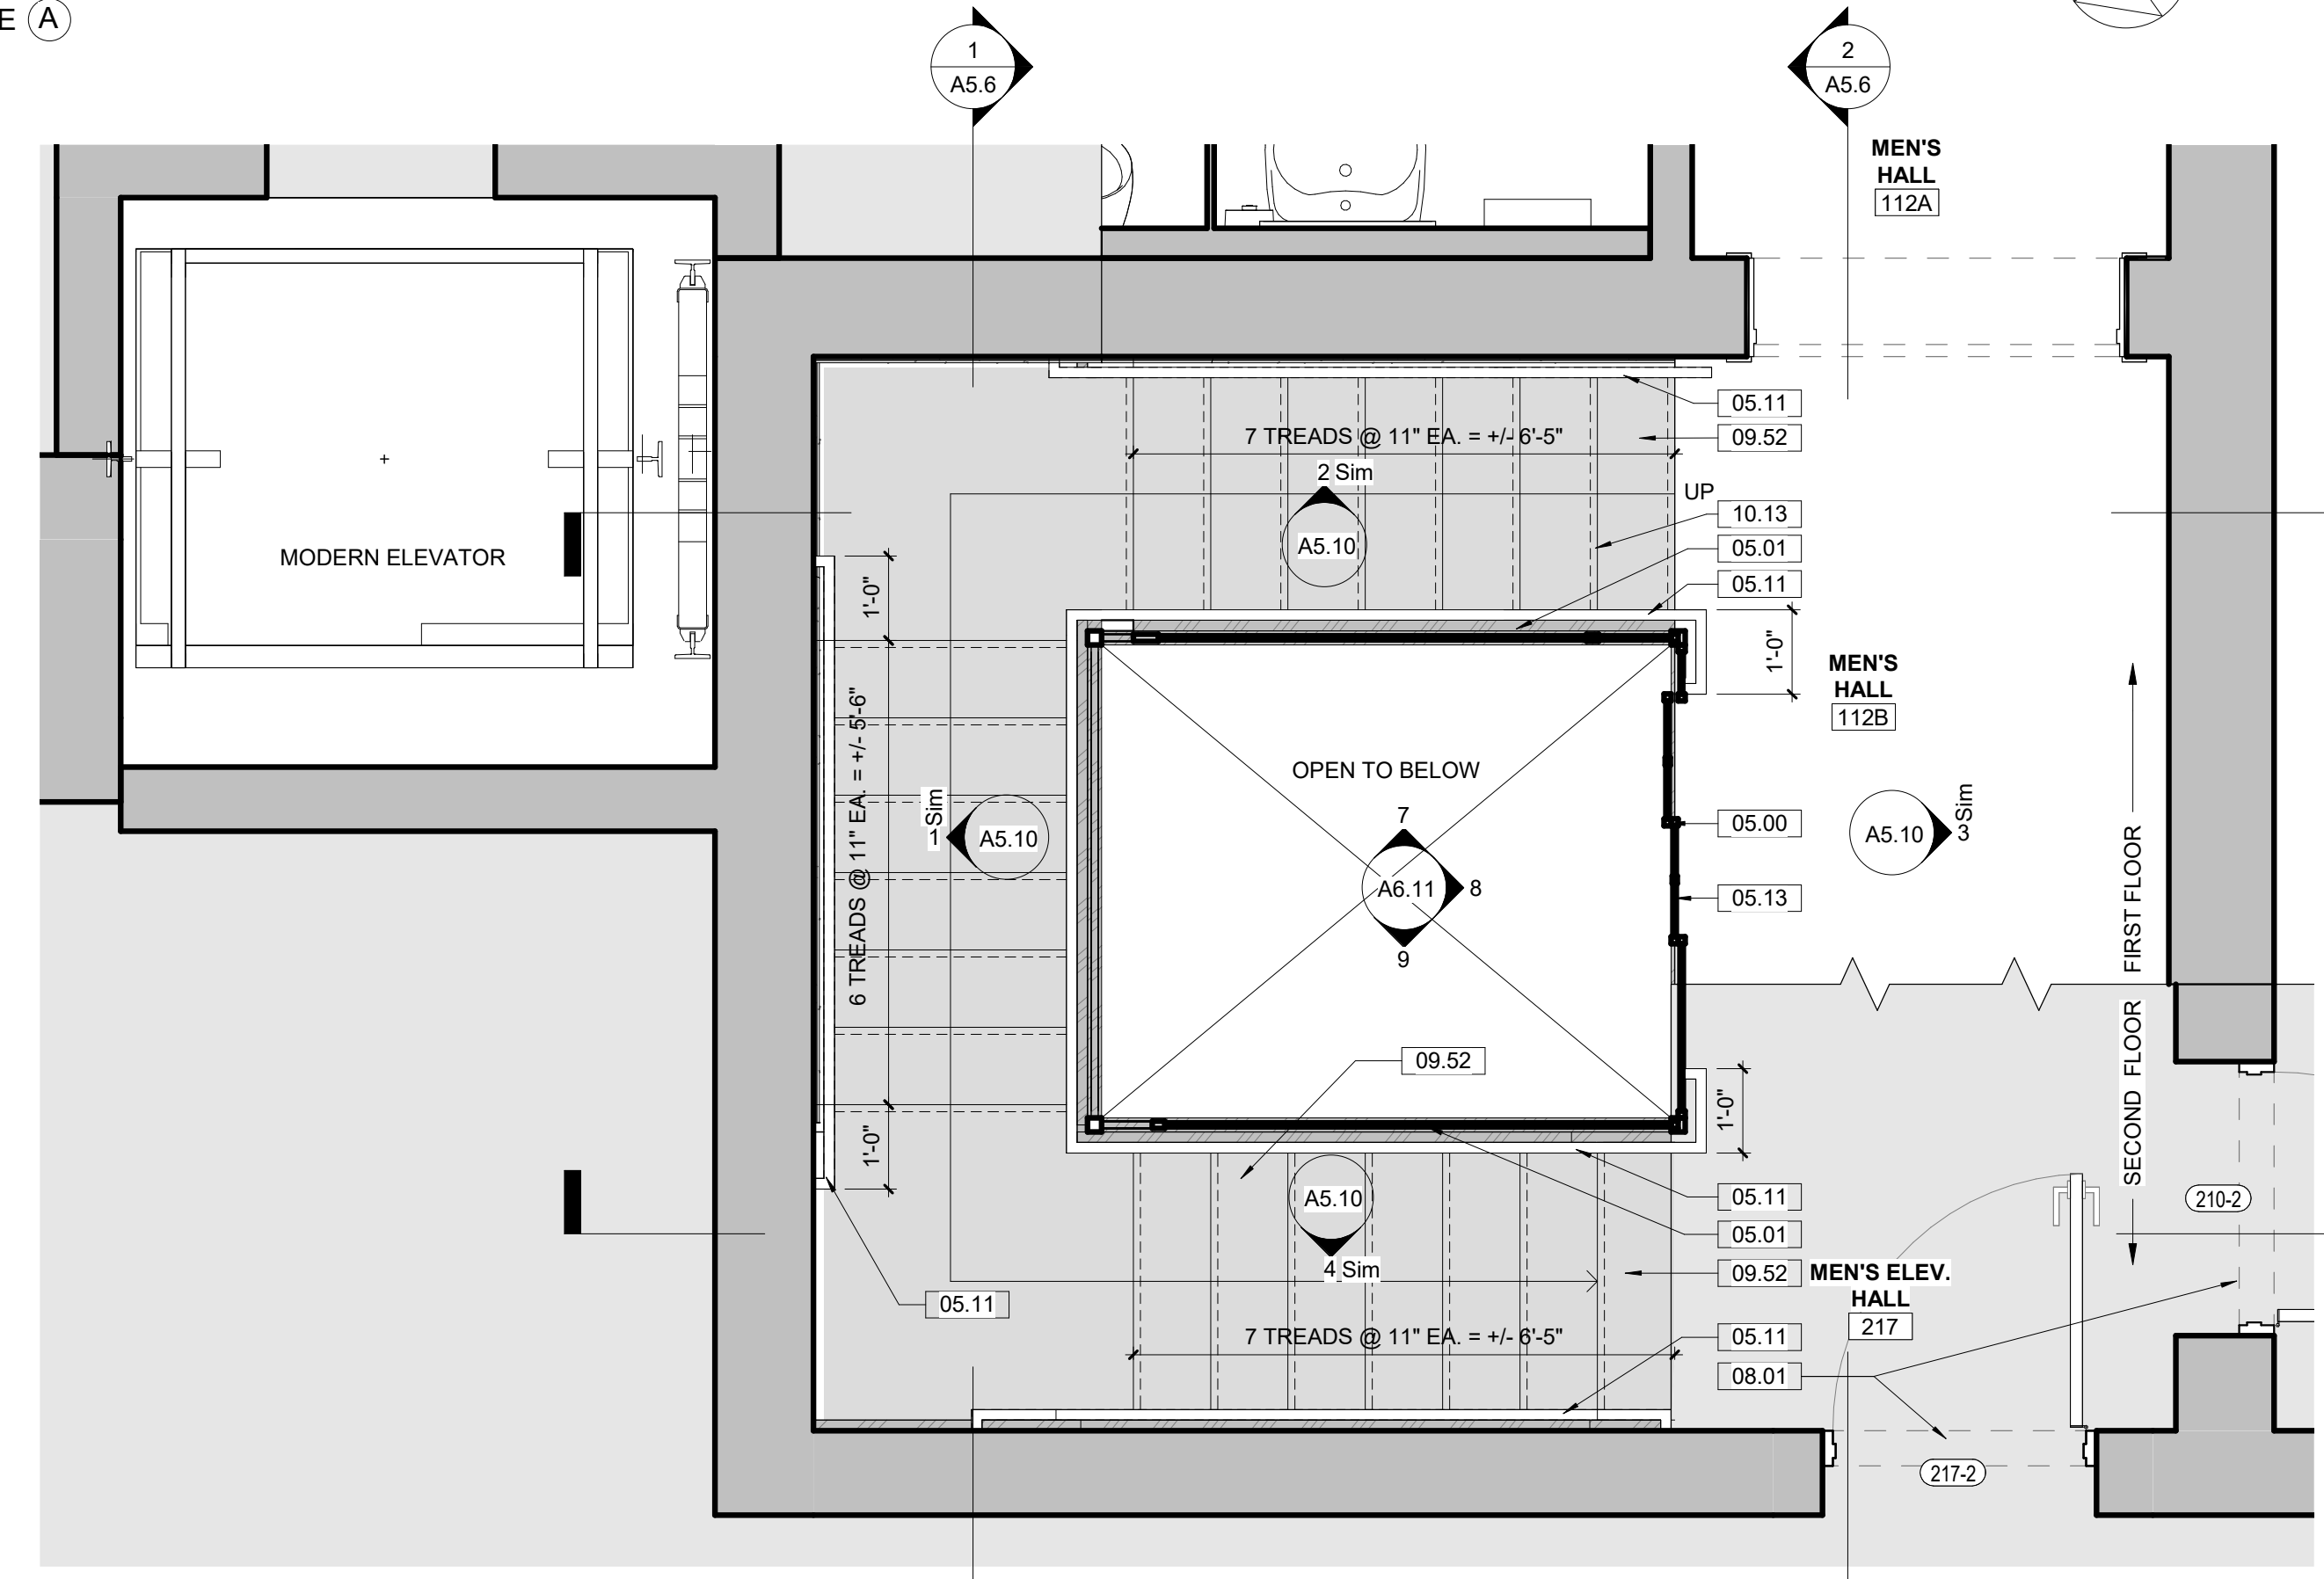

**2**  
**A5.2** Enlarged Plan - South Stairs and Elevator First Floor Plan  
1/2" = 1'-0" SCALE (A)

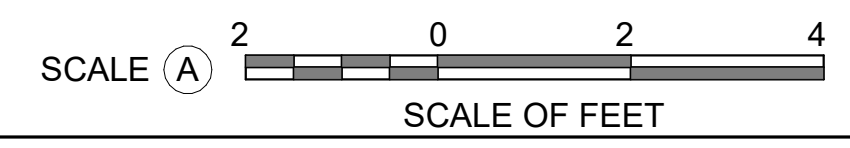

A/E FIRMS PRIME/ARCH: STRATA ARCHITECTURE 1701 OAK STREET, SUITE 100 KANSAS CITY, MO T: 816.474.0900	DESIGNED: CA/AG	SUB SHEET NO.  <b>01</b> <b>A5.2</b>	TITLE OF SHEET MAURICE BATHHOUSE <b>VERTICAL CIRCULATION</b>	DRAWING NO. <b>128</b> <b>182951</b>
	CADD: CA/ZA/EM		PMIS/PKG NO. 318915	
	TECH. REVIEW: AG		SHEET 66 OF 286	
	DATE: 10.27.2023		REHABILITATE BATHHOUSES HOT SPRINGS NATIONAL PARK	

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