



- TYPICAL NOTES:**
- COORDINATE ALL PAVEMENT DETAILS WITH GEOTECHNICAL ENGINEER AND SITE SPECIFIC INVESTIGATION REPORT.
 - ALL EXISTING CONDITIONS SHOULD BE FIELD VERIFIED PRIOR TO CONSTRUCTION AND IT SHALL BE THE CONTRACTOR'S RESPONSIBILITY TO VERIFY THE LOCATIONS OF ALL UTILITIES WITHIN THE LIMITS OF WORK.
 - COMPLETELY REMOVE ANY UNSUITABLE MATERIAL ENCOUNTERED UNDER PROPOSED ROADS AND STRUCTURES TO A DEPTH DETERMINED BY THE GEOTECHNICAL ENGINEER.
 - PROMPTLY REPORT THE ENGINEER OF ANY DISCREPANCY DISCOVERED OR CONFLICT BETWEEN THE DRAWINGS OR SPECIFICATIONS.
 - PAVEMENT AND PEDESTRIAN EGRESS OR ACCESS SHALL BE IN ACCORDANCE WITH ADAAG OR LOCAL REGULATIONS. REFERENCE ARCHITECTURAL DRAWINGS FOR DESIGNATED EMERGENCY EGRESS PATHWAYS.
 - ALL SITE SIGNAGE AND STRIPING SHALL BE IN ACCORDANCE WITH THE RELEVANT NATIONAL, STATE AND LOCAL JURISDICTIONAL CODES AND REGULATIONS. THIS INCLUDES ADA ACCESSIBILITY GUIDELINES (ADAAG) AND THE MANUAL ON UNIFORM TRAFFIC CONTROL DEVICES (MUTCD). PROJECT SPECIFIC SIGNAGE SHALL BE IN ACCORDANCE WITH SUCH APPLICABLE INSTALLATION AND ACCESSIBILITY CODES AND REGULATIONS AS WELL AS THE OWNER PROVIDED DC SIGNAGE MANUAL V.0.0.
 - REFERENCE ELECTRICAL AND SECURITY SITE PLAN SHEETS FOR LIGHTING AND CAMERA LOCATIONS, RESPECTIVELY.
 - DOORS NORTH AND SOUTH OF DC ARE ADA EGRESS DOORS WITH 2.00% MAX CROSS SLOPE ACCESS PROVIDED FOR SHELL 1 AND SHELL 2.
 - REFER TO DISCIPLINE SPECIFIC SHEETS FOR DETAILED PHASING INFORMATION. GENERAL PHASING SHOWN FOR INFORMATIONAL PURPOSES AND NOT INTENDED TO CONVEY COMPLETE SCOPE RE SPECIFIC PHASE.
 - INFORMATION PROVIDED ON OVERALL SHEETS SHALL APPLY TO ALL PHASES, UNLESS OTHERWISE NOTED.

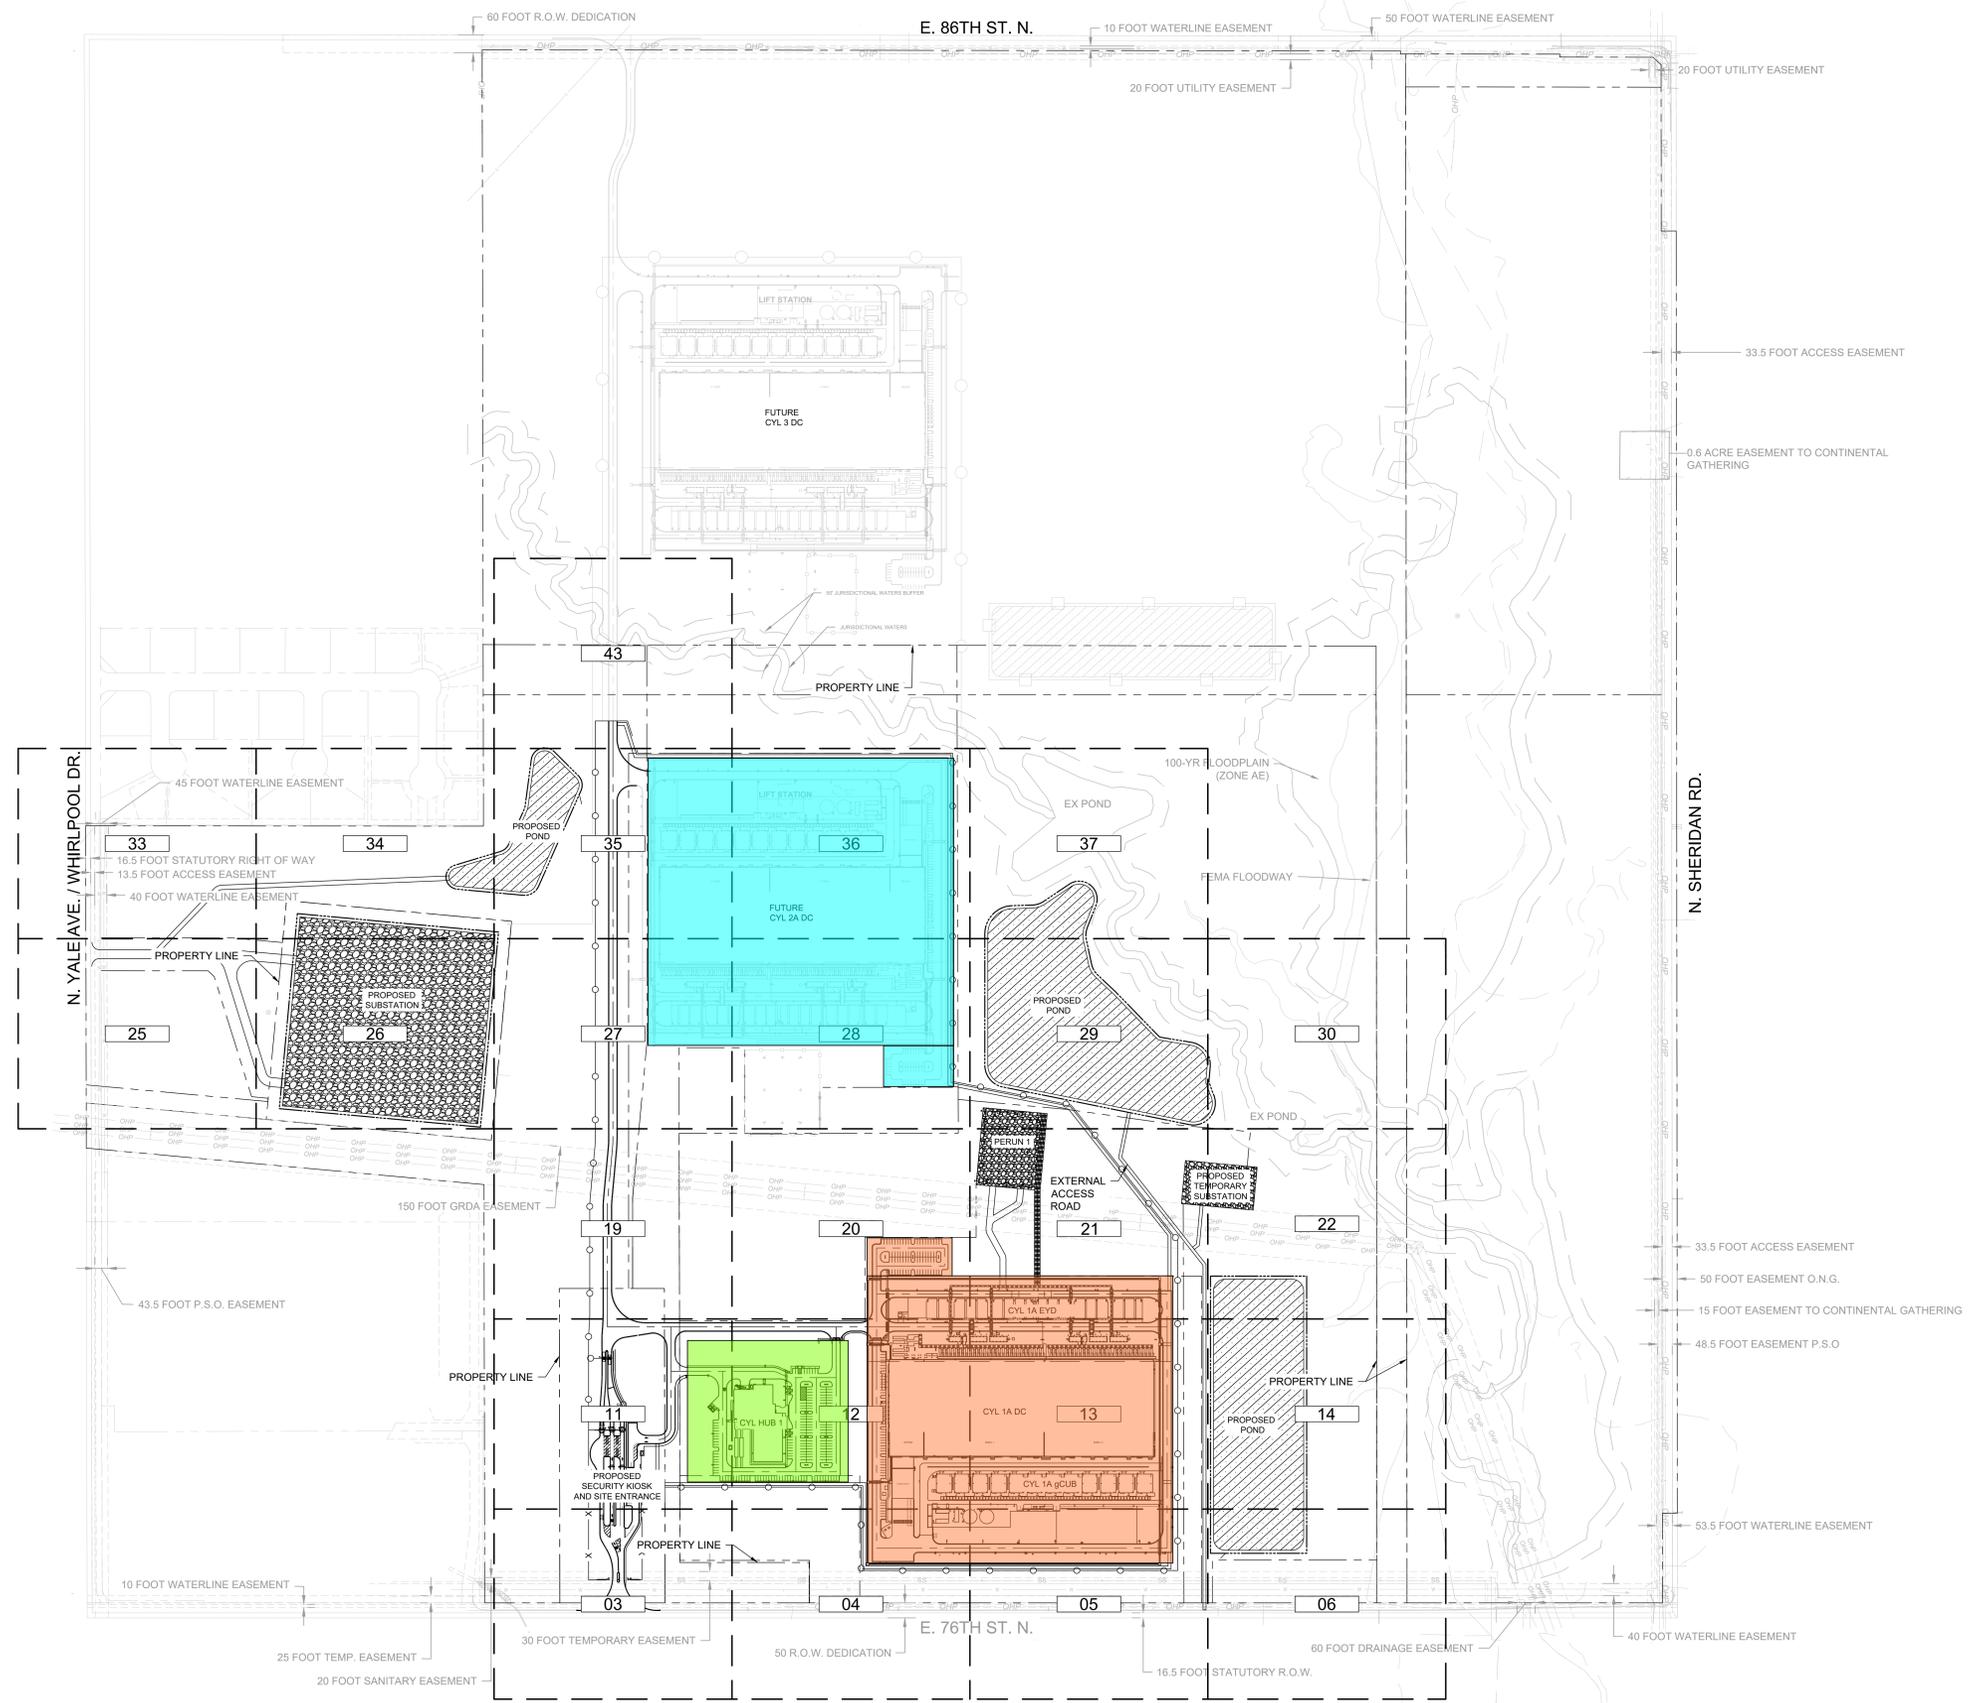

- HUB SCOPE
- DCB1 SCOPE
- DCB2 SCOPE Alternate
- SITE (No Highlight)

THESE DRAWINGS ARE A 65% PROGRESS SET FOR AN OVER-THE-SHOULDER REVIEW AND ARE NOT INTENDED FOR CONSTRUCTION, PERMITTING, OR REGULATORY REVIEW. THEY ARE PROVIDED SOLELY FOR REVIEW AND COORDINATION PURPOSES. THESE DRAWINGS ARE PRELIMINARY AND DO NOT INCLUDE ALL NECESSARY INFORMATION REQUIRED FOR A FINAL DESIGN. DIMENSIONS, MATERIALS, AND DESIGNS ARE SUBJECT TO CHANGE WITHOUT NOTICE AS ADDITIONAL DETAILS ARE DEVELOPED AND DESIGN DECISIONS ARE REFINED. USERS SHOULD INDEPENDENTLY VERIFY ALL DETAILS AND EXERCISE THEIR OWN PROFESSIONAL JUDGMENT BEFORE MAKING DECISIONS BASED ON THESE DRAWINGS. THESE DRAWINGS SHALL NOT BE USED FOR OBTAINING CONSTRUCTION PERMITS, COMPLETING DETAILED DESIGN, OR STARTING CONSTRUCTION ACTIVITIES.

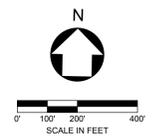

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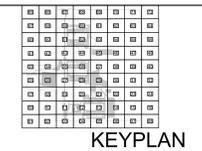
ARCHITECTURE:
HDR Architecture, Inc.
1601 UTICA AVE. SOUTH
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Kimley-Horn Associates, Inc.
1437 S BOULDER AVE.
TULSA, OK 74119
Ph. (918) 380-8868

CYL1A (E3 Drawing Set)
(NOT FOR CONSTRUCTION)
2025-08-18



REVISIONS		
NO.	DATE	DESCRIPTION
0.1	2025/07/07	SPS 30% DESIGN
0.2	2025/08/18	SPS 65% DESIGN

DRAWN: CYL1A
APPR'VD: PROJECT ADDRESS:
TULSA COUNTY, OK
PROJ. NO.: 10434525

SITE PLAN - OVERALL

SCALE: AS SHOWN

SHEET NUMBER:
1A-C-2000

PAPER SIZE: E (36"x48")
PHASE: SPS 65% DESIGN