

VOLUME 01

An Addiiton for BWHS

BWHS Band Addition

1351 GAMBLE RD CENTERTON, AR

Issue Date: 02/02/2026

Project No.: 2421

30% REVIEW SET

CIVIL ENGINEER:

HALFF ENGINEERS
2407 SE COTTONWOOD ST. #1
BENTONVILLE, AR

STRUCTURAL ENGINEER:

TATUM-SMITH-WELCHER ENGINEERS
3100 S MARKET ST
SUITE 202
ROGERS, AR 72758

MECHANICAL / ELECTRICAL ENGINEER:

HSA ENGINEERING
7405 ELLIS ST
FORT SMITH, AR 72916

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CIVIL	XXXXXXXXXXXXXXXXXXXX
C1.0	XXXXXXXXXXXXXXXXXXXX
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Hight Jackson


ASSOCIATES

5201 W Village Parkway, Suite 300 | Rogers, Arkansas 72758 | (479) 464-4965 | www.hjarch.com

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NOTE: REFER TO SHEET A2.5 FOR ADA MOUNTING HEIGHTS DIAGRAM

NOTE: CLEARANCES PROVIDED FOR REFERENCE. REFER TO ANSI A117.1 (CURRENT VERSION)

A1.1 - ADA Door Clearances
1/4" = 1'-0"

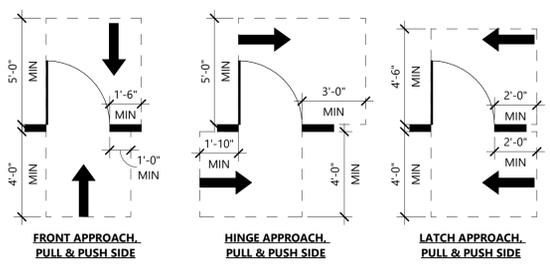TOTAL FIRST FLOOR:
5215 SF
XXX OCCUPANTS

SYMBOL LEGEND	
	1 HR FIRE BARRIER
	2 HR FIRE WALL
	2 HR FIRE BARRIER
	DESIGNATED EXIT
	# OCCUPANTS EGRESSING
	X" EXIT WIDTH REQ'D
	X" EXIT WIDTH PROV'D
XXX	MAX. OCCUPANT LOAD SIGNAGE
2	SECONDARY EXIT
X	NOT AN EXIT
	EXIT SIGN
FEC	FIRE EXTINGUISHER CABINET
FEB-WC	FIRE EXTINGUISHER BRACKET / WET CHEMICAL
HVC	HOSE VALVE CABINET (COORD. W/ FIRE MARSHAL)
	RATED GYPSUM CEILING
ROOM NAME	ROOM USE, RE-- LEGEND
-- SF	SQUARE FEET
-- OCC	OCCUPANCY

ROOM LEGEND	
AC	ART CLASSROOM
BO	BUSINESS OFFICE
CA	CAFETERIA / COMMONS
CO	CONCESSIONS
CF	CONFERENCE
CR	CLASSROOM
DT	DATA/COMMUNICATION
EE	ELEVATOR EQUIPMENT
EL	ELECTRICAL
ER	EXERCISE ROOM
GM	GYMNASIUM / PE
IN	INSTRUMENT
KT	KITCHEN
LB	LAB
LR	LOCKER ROOM
ME	MECHANICAL
MP	MULTI-PURPOSE
MU	MUSIC
OF	OFFICE
PF	PLATFORM
RD	READING ROOM
RE	RESOURCE CLASSROOM
SP	SCIENCE PREP
ST	STORAGE
TP	TEACHER PREP

TYPE OF CONSTRUCTION: TYPE IIB EDUCATIONAL, SPRINKLERED

FACILITY NAME: BENTONVILLE WEST HIGH SCHOOL ADDITIONS

FACILITY LOCATION:
1351 GAMBLE RD
CENTERTON, AR 72718

COUNTY: BENTON

LOCAL FIRE DEPARTMENT:
CENTERTON FIRE DEPARTMENT

WATER SUPPLY:
CENTERTON WATER AND SEWER

LOCAL BUILDING INSPECTION DEPARTMENT:
BUILDING PERMITS AND INSPECTIONS DEPARTMENT

APPLICABLE CODES AND REGULATIONS:
2021 ARKANSAS FIRE PREVENTION CODE, 2012 EDITION, VOLUME 1, FIRE
2021 INTERNATIONAL BUILDING CODE, 2012 EDITION, VOLUME II, BUILDING
(VOL. 2 WITH ARKANSAS STATE AMENDMENTS)
2018 ARKANSAS PLUMBING CODE
2021 IMC MECHANICAL CODE
2020 NATIONAL ELECTRIC CODE
2014 ARKANSAS ENERGY CODE

ARCHITECT CONTACT
HIGHT JACKSON ASSOCIATES
MICHELLE MCCLAFLIN / TIM SCHMIDT
5201 WEST VILLAGE PARKWAY, SUITE 300
ROGERS, AR 72758
PHONE- (479)-464-4965
FAX- (479) 464-8324

OWNER CONTACT:
PAUL WALLACE
BENTONVILLE SCHOOL DISTRICT FACILITIES DIRECTOR
8579 WEST FORD SPRINGS RD.
BENTONVILLE, AR 72712
PHONE- (479)-254-5085

NEW CONSTRUCTION:

OCCUPANCY TYPE- EDUCATIONAL (E)
OCCUPANT LOAD- --
CONSTRUCTION TYPE- --
BASIC ALLOWABLE AREA PER STORY- --
SPRINKLER INCREASE - --
FRONTAGE INCREASE PER BUILDING

TOTAL ALLOWABLE AREA PER BUILDING
NORTH BUILDING - --
EAST BUILDING - --
WEST BUILDING - --
ALLOWABLE HEIGHT- --
ACTUAL HEIGHT- --
ALLOWABLE STORIES- --
ACTUAL STORIES- --
COMBINE TOTAL SQUARE FOOTAGE - --


HORIZONTAL SEPARATION TO PROPERTY LINE - +/- -" TO EAST
PL, +/- - TO SOUTH PL, +/- - TO WEST PL, AND
+/- - TO NORTH PL.

STRUCTURAL FIRE PROTECTION
STRUCTURAL FRAME- 0 HR.
EXTERIOR BEARING WALLS- 0 HR.
INTERIOR BEARING WALLS- 0 HR.
EXTERIOR NON-BEARING WALLS- 0 HR.
INTERIOR NON-BEARING WALLS- 0 HR.
FLOORS- 0 HR.
ROOF- 0 HR.

ACTIVE FIRE SAFETY FEATURES:
FIRE SPRINKLER SYSTEM THROUGHOUT
FIRE ALARM SYSTEM- GENERATOR AND BATTERY BACK UP
SMOKE DETECTION THROUGHOUT-BATTERY BACKUP
AUTOMATIC AIR HANDLING EQUIPMENT SHUTDOWN
KITCHEN HOOD SUPPRESSION SYSTEM
EXIT LIGHTS- GENERATOR BACK UP
EMERGENCY LIGHTING- GENERATOR BACK UP

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A1 First Floor Life Safety Plan
1/8" = 1'-0"

An Addition for BWHS
BWHS Band Addition
1351 GAMBLE RD CENTERTON, AR

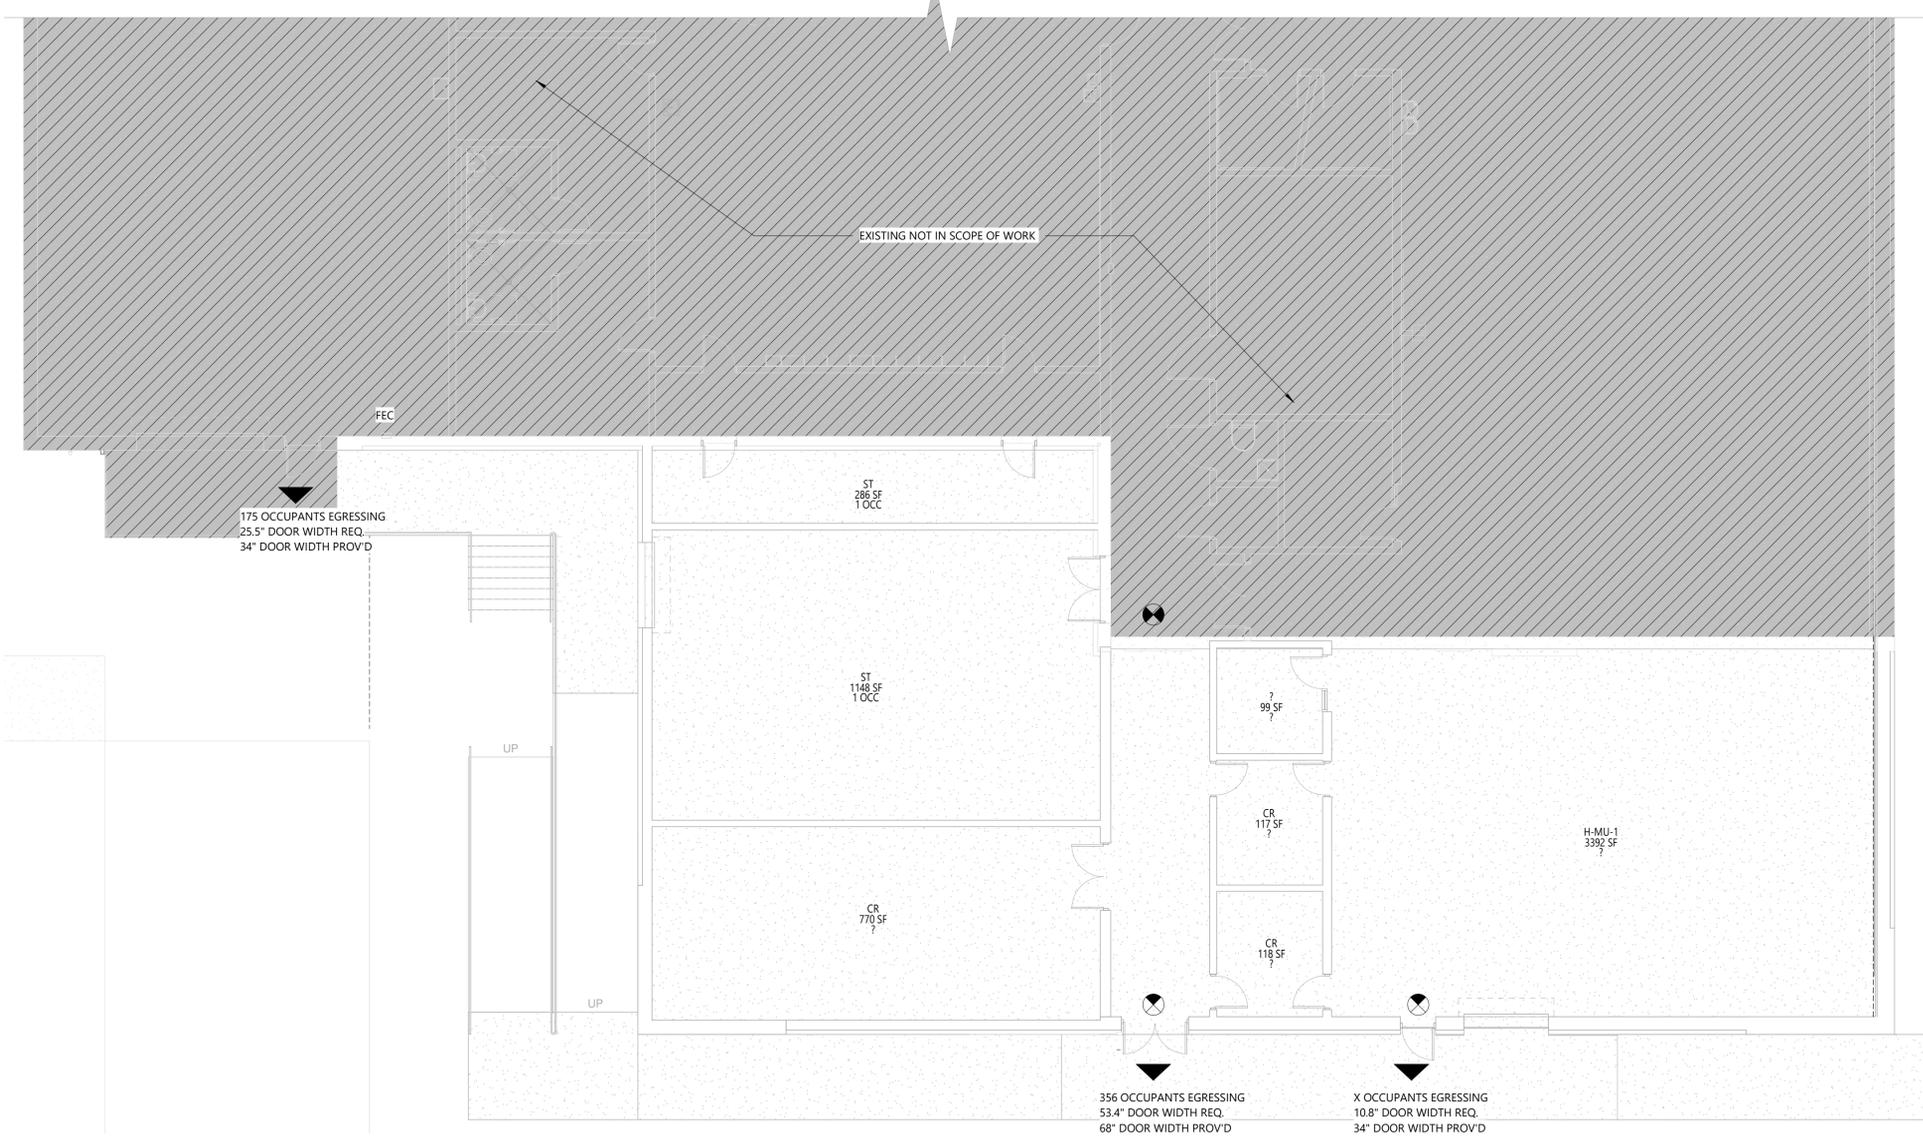DRAWN BY:
MS
CHECK BY:
TS
ISSUE DATE:
02/02/2026

PROJECT NO:
2421

REVISION DATES

CODE FOOTPRINT
SHEET
A0.1

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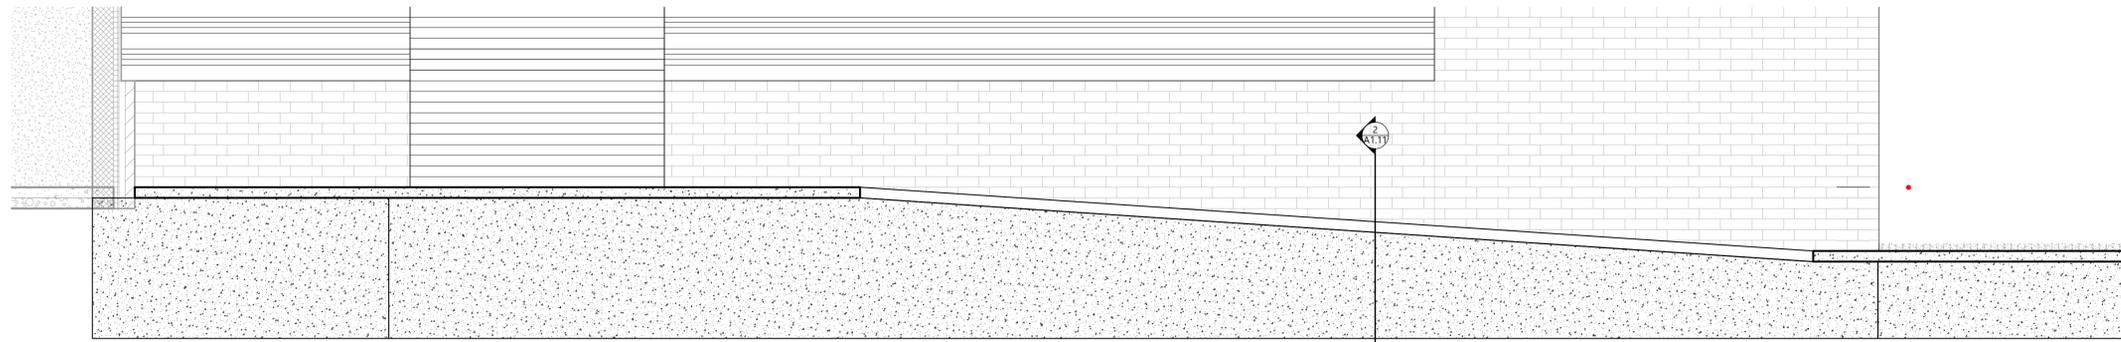
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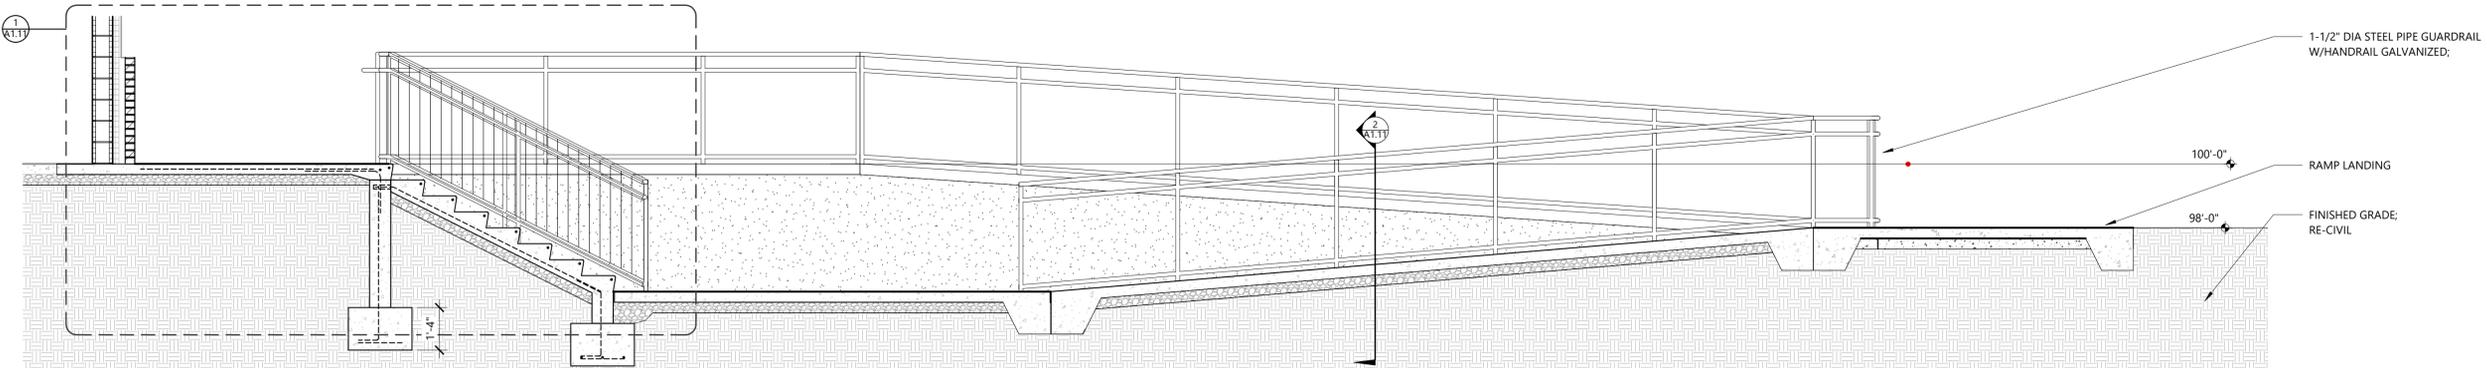
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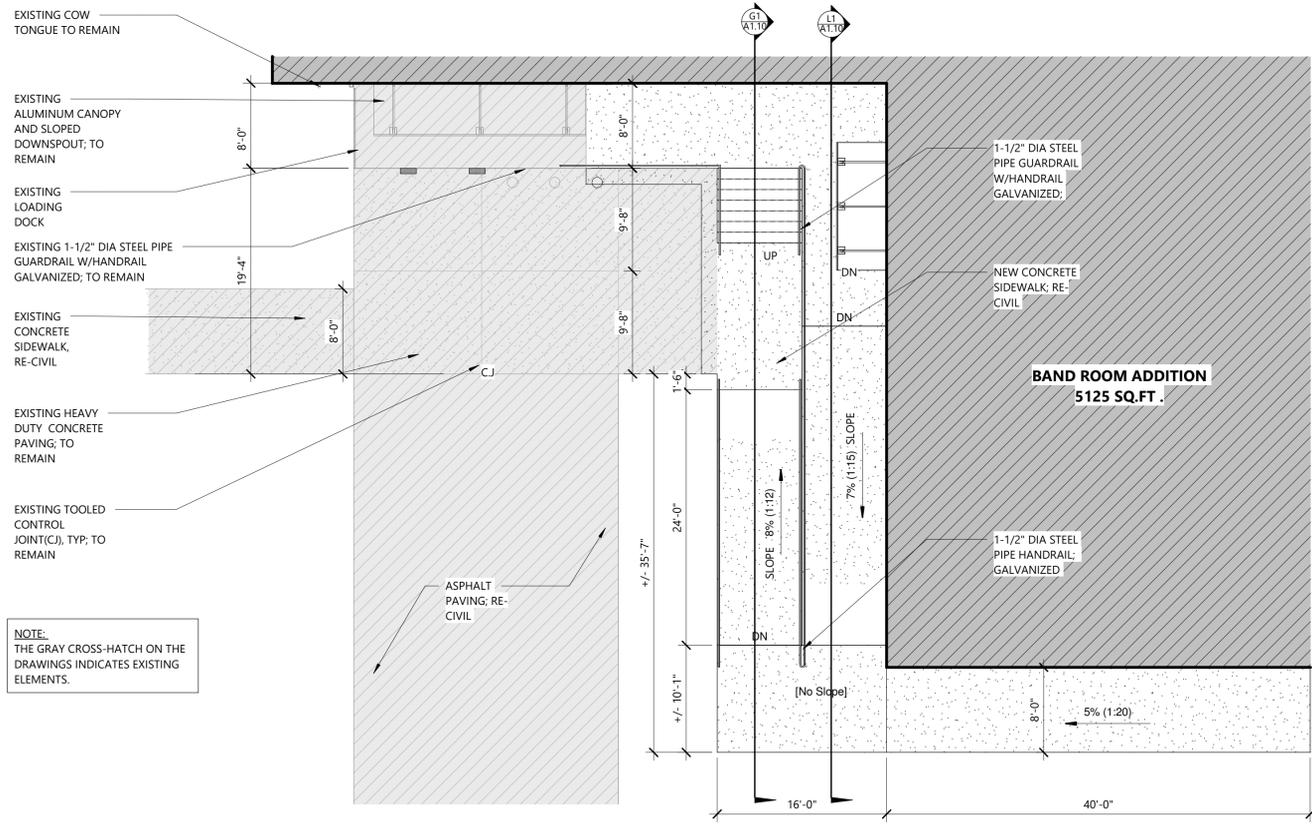
ARCHITECTURAL SITE PLAN
SHEET
A1.10
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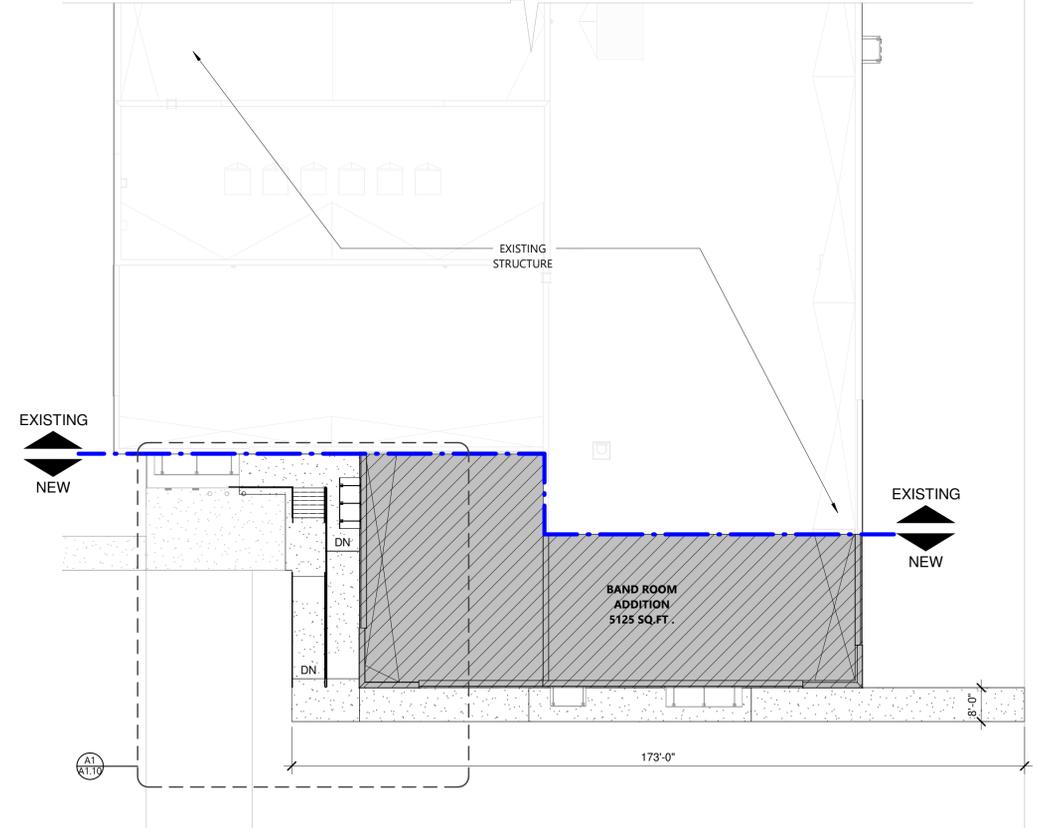
L1 Ramp Section
3/8" = 1'-0" Ref: A1/ A1.10



G1 Ramp Section
3/8" = 1'-0" Ref: A1/ A1.10



A1 Enlarged Site Plan
1/8" = 1'-0" Ref: A12/ A1.10




A12 Site Plan
1" = 20'-0"

General Demolition Notes

- DEMOLITION NOTES ARE PROVIDED TO EXPLAIN THE ITEMS TO BE REMOVED, RELOCATED, AND/OR MODIFIED IN ORDER TO FACILITATE THE REMODEL AND NEW CONSTRUCTION. IT SHALL BE THE RESPONSIBILITY OF THE GENERAL CONTRACTOR TO PROVIDE DEMOLITION AND PATCH ITEMS, SURFACES AND AREAS AS REQUIRED TO PROVIDE NEW WORK OR TO INSTALL NEW ITEMS WHERE CALLED FOR ON THE DRAWINGS AND SPECIFICATION.
- PRIOR TO DEMOLITION AND CONSTRUCTION, IT IS THE CONTRACTOR'S RESPONSIBILITY TO FIELD VERIFY THE LOCATION AND CONDITION OF ALL EXISTING UTILITIES AND ELECTRICAL ITEMS (EXTERIOR AND INTERIOR) ON THE SITE AND WITHIN THE EXISTING BUILDING(S).
- CONTRACTOR TO COORDINATE WITH OWNER THE REMOVAL OF ALL ITEMS OWNER WISHES TO SALVAGE FROM EXISTING REMODEL AREAS PRIOR TO THE START OF CONSTRUCTION. CONTRACTOR TO STORE CLASSROOM SUPPLIES DURING PHASE REMODEL.
- CONTRACTOR TO VERIFY ALL UTILITY CONDITIONS. REMOVAL AND REPLACEMENT OF ANY UTILITY LINE OR CONDUIT REQUIRED TO INSTALL NEW WORK TO BE INCLUDED AS PART OF THIS BID.
- PROTECT ALL PLUMBING, MECHANICAL, ELECTRICAL, DATA EQUIPMENT, AND OTHER ITEMS NOTED OR INDICATED TO REMAIN. REFER TO PLUMBING, MECHANICAL, AND ELECTRICAL DRAWINGS FOR ADDITIONAL NOTES. IT IS THE CONTRACTOR'S RESPONSIBILITY TO PAY FOR AND REPAIR OR REPLACE ANY ITEMS DAMAGED DURING WORK TO LIKE-NEW CONDITION PRIOR TO PROJECT CLOSE-OUT. REFER TO SECTIONS, PLUMBING, MECHANICAL, AND ELECTRICAL DRAWINGS FOR ADDITIONAL DEMOLITION NOTES AND INFORMATION.
- REPORT ANY DISCREPANCIES IMMEDIATELY TO ARCHITECT.
- SAW CUT AND REMOVE SECTIONS OF EXISTING SLABS AND EXISTING SIDEWALKS AS REQUIRED TO INSTALL NEW WORK. PATCH AND REPAIR EXISTING SLABS AND SIDEWALKS AS REQUIRED.
- REPAIR EXISTING WALLS AT LOCATIONS OF ANY DEMOLISHED PORTIONS OF WALLS AND DOOR FRAMES AS REQUIRED FOR NEW SURFACE AND FINISH.
- REMOVE EXISTING WALL FINISHES AS REQUIRED FOR NEW PAINT. RE- SPECIALTY PLANS
- REMOVE EXISTING LIGHTS RE- REFLECTED CEILING PLAN. REFER TO ELECTRICAL/LIGHTING PLAN FOR ADDITIONAL NOTES.
- REFER TO M.E.P DEMOLITION PLANS AND NOTES FOR ADDITIONAL REMOVAL AND/OR RELOCATION OF SYSTEMS NOT NOTED IN ARCHITECTURAL
- REPAIR WALLS AT LOCATIONS OF ANY REMOVED MECHANICAL, ELECTRICAL OR PLUMBING ITEMS. REPAIR WALLS WITH SAME MATERIAL AS ADJACENT SURFACES TO NEW CONDITION. PAINT AS REQUIRED. WHERE ITEMS ARE REMOVED IN AREAS OF CMU, FILL IN WITH CMU TO MATCH COURSING.
- REMOVE ALL EXISTING COUNTERTOPS, MILLWORK, CABINETS, SHELVES, AND HOOKS
- REMOVE PARTS OF EXISTING WALLS TO INSTALL NEW PLUMBING, ELECTRICAL, ETC. REFER TO M.E.P PLANS FOR NEW M.E.P LOCATIONS. REPAIR WALLS BACK TO FINISH CONDITIONS FOR PAINTING.
- DEMOLISH ALL PROJECTOR CEILING PLATES, PROJECTORS, SMARTBOARDS AND RAPID RUN CABLES.
- REMOVE MARKER BOARD, TACK BOARD, AND TACK STRIPS, PATCH WALLS AND REPAIR FOR FINAL FINISH SURFACE LIKE NEW.
- REMOVE ANY MOVABLE ITEMS SUCH AS SHELVING, FURNITURE, ETC. THAT HAS NOT BEEN REMOVED BY THE OWNER COORDINATE WITH OWNER.
- OWNER HAS PREFORMED ABATEMENT REMOVAL OF VCT FLOOR COVERING, NOTIFY CONTRACTOR AND ARCHITECT IF YOU SUSPECT ASBESTOS MATERIAL.
- ALL CRACKS, VOIDS, HOLES, ETC. IN CMU WALLS TO BE REPAIRED TO RECEIVE NEW FINISH, RE- FINISH LEGEND AND SPECIALTY PLAN
- REMOVE AND REPLACE ROOFS WHERE NOTED, REFER TO ROOF DEMO PLAN
- REMOVE ALL METAL ITEMS ASSOCIATED WITH ROOF REPLACEMENT, REFER TO ROOF DEMO PLAN.
- REMOVE AND PROTECT EXISTING ROOM SIGNAGE NOTED FOR REINSTALL ON SPECIALTY PLANS. DEMOLISH ALL EXISTING ROOM SIGNS NOT NOTED FOR REINSTALL.
- REFER TO HVAC PLANS FOR REUSE, REMOVAL AND REPLACEMENT OF EXISTING EQUIPMENT. PATCH AND REPAIR ALL EXISTING WALLS, FLOORS AND ROOFS AS REQUIRED AFTER REMOVAL OR INSTALLATION.
- PATCH AND REPAIR, PLUG HOLES, REMOVE UNNECESSARY HARDWARE AND STICKERS(NOT UL LABELS) AT EXISTING HM DOORS AND FRAMES FOR NEW PAINT AND HARDWARE AS NOTED, RE SPECIALTY PLAN AND DOOR SCHEDULE/TAGS.
- DURING SLAB DEMOLITION FOR NEW CONSTRUCTION, CONSTRUCTION MANAGER TO VERIFY SLAB THICKNESS AND REPORT TO ARCHITECT.
- ALL WALL SURFACES AFFECTED BY DEMO OR NEW WORK MUST BE REPAIRED FOR FINAL FINISH SURFACE RE- SPECIFICATION SECTION 092900 FOR TEXTURE REQUIREMENTS AT PAINTED GYP. BD. WALLS
- REMOVE EXISTING DOWNSPOUTS, GUTTERS AND FASCIA AND REPLACE WITH NEW AT ALL LOCATIONS UNLESS NOTED OTHERWISE, REFER TO ROOF DEMO PLAN.
- CAP OFF ALL UNUSED PLUMBING PIPING AND ELECTRICAL LINES BELOW FLOOR SLAB, ABOVE CEILING OR WITHIN WALLS AS ALLOWED BY CODE. PATCH OR INFILL AREAS AS REQUIRED. RE-MEP
- REMOVE ALL SURFACE MOUNT, JUNCTION BOXES, CONDUIT, AND WIREMOLD, RE-ELECT.
- AT EXTERIOR LIGHT REMOVAL/REPLACE, TOOTH IN BRICK AS REQUIRED TO FILL ANY HOLE BEHIND LIGHT FIXTURE.
- REMOVE ALL EXIT LIGHTS AND REPLACE WITH NEW AT CURRENT LOCATIONS UNLESS NOTED OTHERWISE.
- REMOVE ALL EXISTING TV'S. REPAIR WALL TO LIKE NEW CONDITION FROM TV BRACKET REMOVAL.
- REMOVE ALL UNUSED EQUIPMENT AND SYSTEMS SUCH AS CORRIDOR BELLS, INTERCOM STATIONS, OCCUPANCY SENSORS, FIRE ALARM DEVICES ETC. NO LONGER IN USE AFTER IMPLEMENTATION OF NEW SYSTEMS. PATCH ALL WALLS TO MATCH ADJACENT WALL SURFACE AFTER REMOVAL
- REMOVE ALL PROJECTION SCREENS, ROLL-UP WALL MOUNTED MAPS AND PULL DOWNS.
- REMOVE ALL CABLING EXCEPT SECURITY CAMERA CABLING. CABLING TO BE REMOVED PER CONSTRUCTION PHASING DO NOT LEAVE UNUSED CABLING.
- REMOVE ALL OLD ANCHORS, BRACKET, SCREENS ETC. FROM EXISTING WALLS. PATCH ANY REMAINING HOLES TO CREATE LIKE NEW WALL FOR NEW PAINT APPLICATION.
- ALL EXPOSED CAPPED PLUMBING LINES TO BE TERMINATED WITHIN WALL OR OVERHEAD, REPAIR WALL TO CREATE LIKE NEW WALL FOR NEW FINISHES/PAINT APPLICATION.
- REMOVE ALL EXISTING RUBBER BASE
- ANY INTERRUPTION IN SERVICES MUST BE COORDINATED WITH OWNER PRIOR TO SHUT OFF.
- REMOVE ALL TECTUM UPPER WALL FUR DOWNS AND WOOD TRIM, PREP FOR METAL STUD FRAMING INSTALL.
- EXISTING FIRE EXTINGUISHER CABINETS TO BE REMOVED. PREP WALL AT SAME LOCATION TO INSTALL NEW FIRE EXTINGUISHER CABINET WITH HANDLE NO HIGHER THAN 48". FIRE EXTINGUISHER MAYBE RE- INSTALLED ONCE TESTED AND TAGGED.
- REMOVE ALL SURFACE MOUNT CONDUIT, JUNCTION BOXES AND WIREMOLD. REFER TO ELECTRICAL FOR REPLACEMENT INSTRUCTION.
- REPAIR WALLS TO LIKE NEW CONDITION AT ANY REMOVED SURFACE APPLIED PRODUCTS. REMOVE ANY ADHESIVE OR INCONSISTENT TEXTURE FROM WALL. REPAIR MASONRY JOINTS
- REPAIR WALLS TO LIKE NEW CONDITION FROM ANY REMOVED WALLS OR VENEER. TUCKPOINT AND RE-POINT MASONRY JOINTS TO TOOLED JOINT TO MATCH ADJACENT. REMOVE ANY EXCESS MORTAR OR WIRE TIES FOR SMOOTH WALL CONDITION READY FOR PAINTING.

DEMOLITION KEYED NOTES

WTWT	Description
1	DEMO EXISTING CARPET AND BASE; PREP FLOOR FOR NEW INSTALLATION
2	REMOVE AND REINSTALL EXISTING ACOUSTIC WALL PANELS
3	REMOVE AND RE-INSTALL A PORTION OF EXISTING WALL-MOUNTED DISPLAY CASE AND MIRRORS FOR NEW CONSTRUCTION
4	PROTECT EXISTING WATER FOUNTAIN TO REMAIN.
5	PROTECT EXISTING FURR DOWN
6	DEMO EXISTING COILING DOOR
7	DEMO MASONRY WALL WITH MASONRY/STEEL LINTEL, PARAPET CAP, AND ASSOCIATED WALL COMPONENTS
8	DEMO EXISTING RAMP AND LANDING
9	REMOVE EXISTING SECURITY CAMERA
10	REMOVE EXISTING EXIT SIGN
11	REMOVE EXISTING DOOR AND FRAME
12	REMOVE AND REINSTALL OR PROTECT EXISTING PROJECTOR SCREEN AND SPEAKERS DURING CONSTRUCTION
13	REMOVE AND REINSTALL OR PROTECT WALL-MOUNTED TV AND EQUIPMENT
14	REMOVE AND REINSTALL OR PROTECT TACK BOARD
15	SAW CUT AND REMOVE SECTION OF EXISTING SLABS AS REQUIRED TO INSTALL NEW WORK. PATCH AND REPAIR SLAB AS REQUIRED.
16	DEMO EXISTING STAIRS
17	DEMO RAILING
18	REMOVE AND RE-INSTALL EXISTING ALUMINUM CANOPIES
19	PATCH AND FILL HOLES AND REPAIR LOADING DOCK PLATFORM WITH CONCRETE AFTER DEMOLISHING HANDRAIL
20	DEMO SIDEWALK AND PREP FOR NEW
21	REMOVE EXISTING WATER AND ELECTRICAL OUTLET AT EXTERIOR WALL
22	REMOVE EXISTING DRYER OUTLET AT EXTERIOR WALL AND PATCH OPENING
23	REMOVE AND REINSTALL EXISTING SIGNAGE AND EXIT SIGN ON EXTERIOR WALL; RETURN TO OWNER
24	DEMO EXISTING PORTION OF WALL FOR NEW DOOR INSTALLATION
25	DEMOLISH PORTION OF CONCRETE SIDEWALK AND PREP AREA FOR NEW INSTALLATION
26	REMOVE AND RE-INSTALL WALL MOUNTED OUTDOOR SPEAKER ON EXTERIOR WALL
27	REMOVE AND RE-INSTALL WALL MOUNTED OUTDOOR SECURITY CAMERA ON EXTERIOR WALL
28	DEMO EXISTING 2'x4' LIGHT FIXTURES FROM CLASSROOM AND REINSTALL IN NEW CORRIDOR
29	REMOVE AND REINSTALL EXISTING BOULDER
30	EXISTING BOULDERS TO REMAIN
32	DEMOLISH EXTERIOR METAL PANELS, RIGID INSULATION, AND Z-GIRTS, INCLUDING BRICK VENEER COURSE AT BASE; CLEAN CMU WALL FOR NEW INTERIOR FINISH INSTALLATION
33	DEMOLISH EXISTING EDGE CEILING GRID AND PREP FOR NEW GRID INSTALLATION
34	REMOVE PYRAMIDAL DIFFUSERS AT LAST GRID OF WALL AND REINSTALL AFTER NEW CEILING GRID IS CONNECTED TO EXISTING GRID
35	REMOVE AND REINSTALL EXISTING 2' X 4' LIGHT FIXTURE AFTER NEW CEILING GRID IS CONNECTED TO EXISTING GRID
36	EXISTING PROJECTOR AND HANGER ROD FROM CEILING TO REMAIN AND BE PROTECTED
37	EXISTING DIFFUSER TO REMAIN; RE-MECH

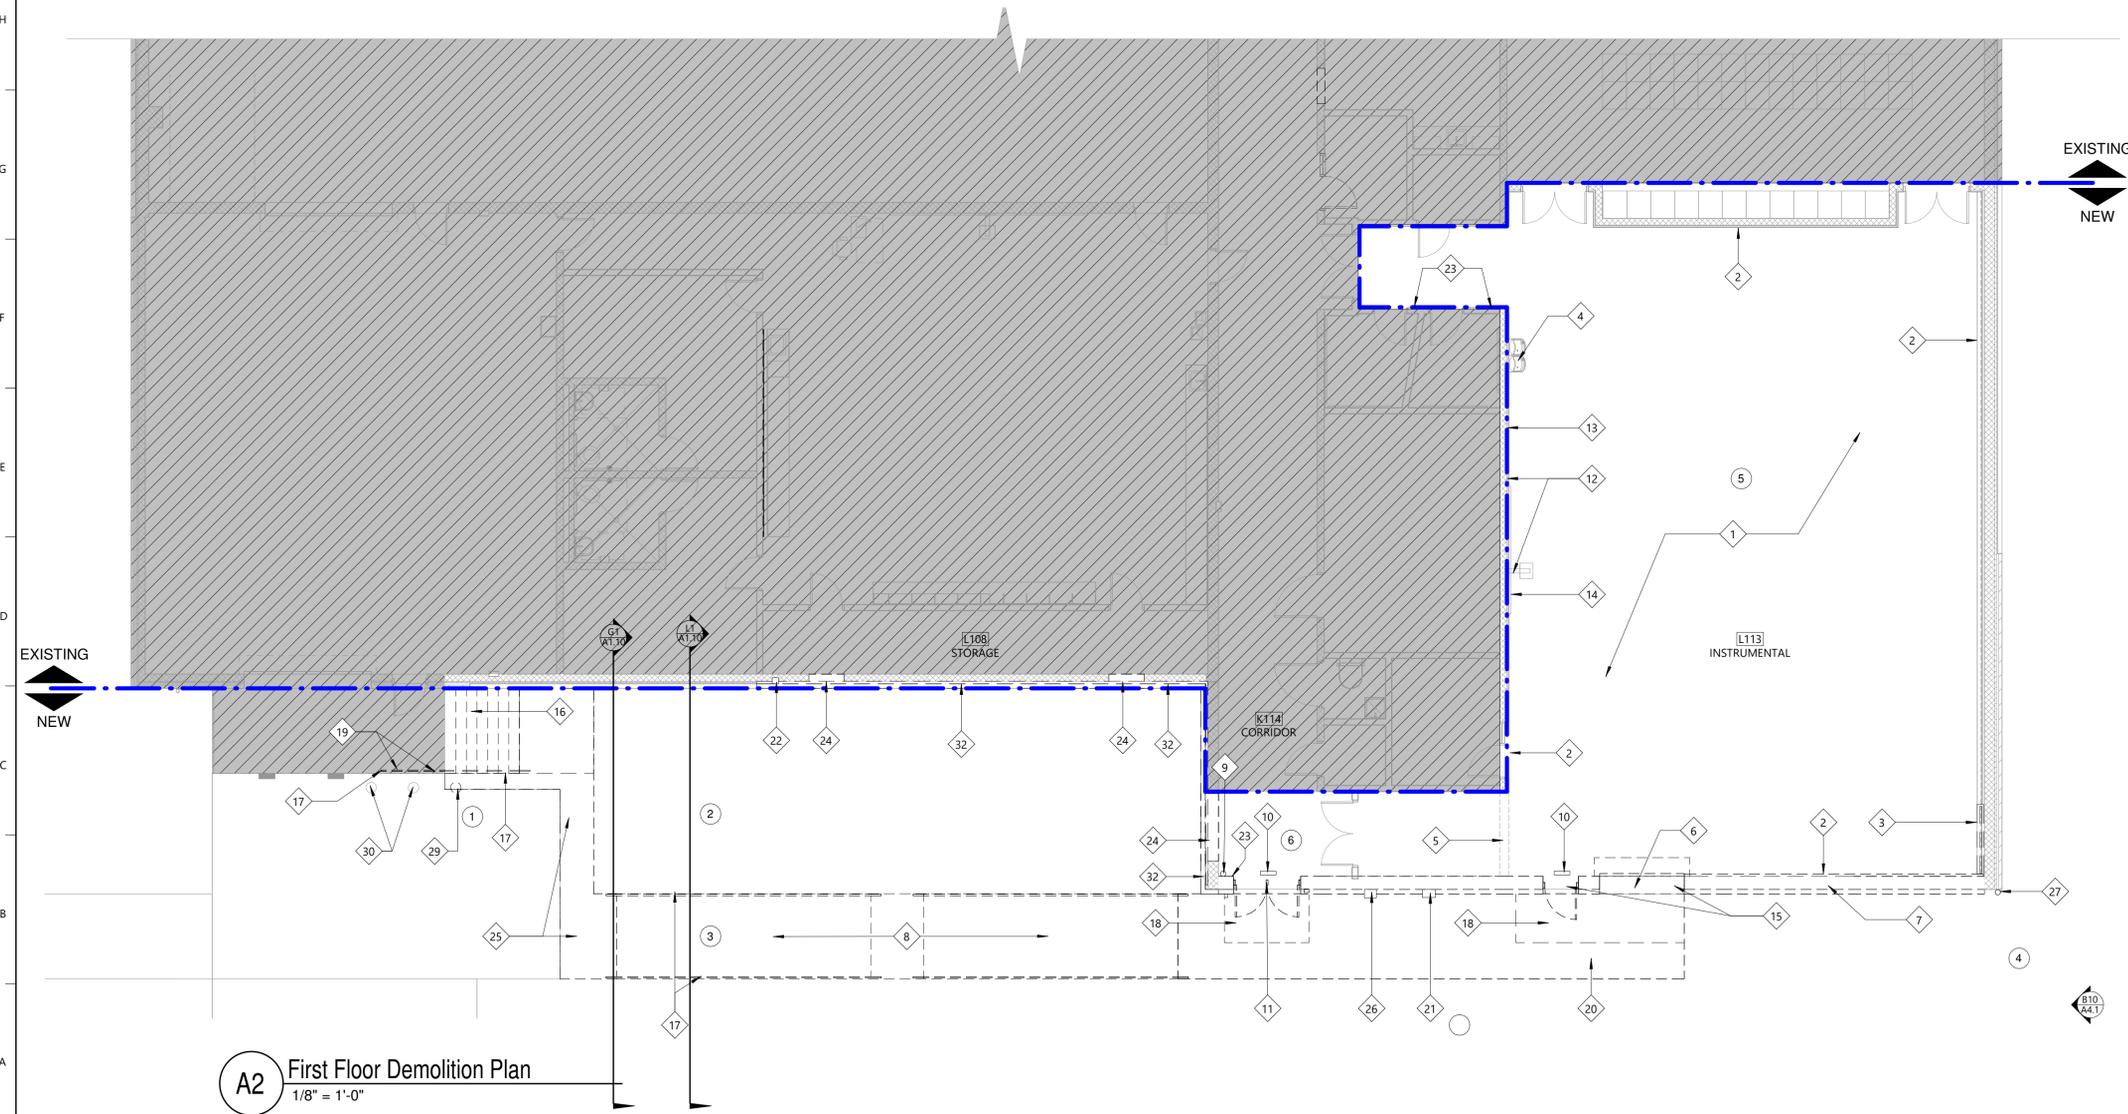

A2 First Floor Demolition Plan
1/8" = 1'-0"

30% REVIEW SET

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BWHS Band Addition
 1351 GAMBLE RD CENTERTON, AR

DRAWN BY: MS
 CHECK BY: TS
 ISSUE DATE: 02/02/2026

PROJECT NO: 2421
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DEMOLITION PLAN
 S H E E T
A2.0
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BWHS Band Addition
1351 GAMBLE RD CENTERTON, AR

DRAWN BY:
MS
CHECK BY:
TS
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2421
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RCP DEMOLITION PLAN
SHEET
A2.0A
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1 Loading Dock Demo



2 Exterior Storage wall Demo



3 Ramp and Band Room Exterior Wall Demo

Reflected Ceiling Demo Plan Legend

-  EXISTING 2"x4" ACOUSTICAL CEILING
-  DEMO EXISTING GRID
-  DEMO EXISTING 2 X 4 LIGHT FIXTURE, RE-ELEC
-  EXISTING 2 X 4 LIGHT FIXTURE, RE-ELEC
-  PICTURE REFERENCE, RE - A2.01

Ceiling Demo Plan General Notes:


1. VERIFY ALL DEMOLITION ITEMS AND EXTENTS BEFORE REMOVAL.
2. PROTECT EXISTING CEILINGS, DIFFUSERS, PROJECTORS, HANGER RODS, AND OTHER FIXTURES NOTED TO REMAIN.
3. REMOVE DEMOLITION ITEMS CAREFULLY TO AVOID DAMAGE TO ADJACENT CONSTRUCTION OR FINISHES.
4. ITEMS DESIGNATED FOR REINSTALLATION, INCLUDING LIGHT FIXTURES AND DIFFUSERS, TO BE REINSTALLED AS DIRECTED.
5. PREP SUBSTRATES, CEILING GRIDS, AND OPENINGS FOR NEW INSTALLATIONS.
6. COORDINATE WITH ELECTRICAL, MECHANICAL, AND OTHER TRADES FOR REMOVAL, PROTECTION, AND REINSTALLATION.




4 Existing South Wall Demo



3 Existing Band Classroom interior East, South and West Elevation Demo

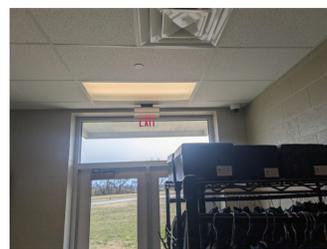

5 Existing Corridor Demo Notes

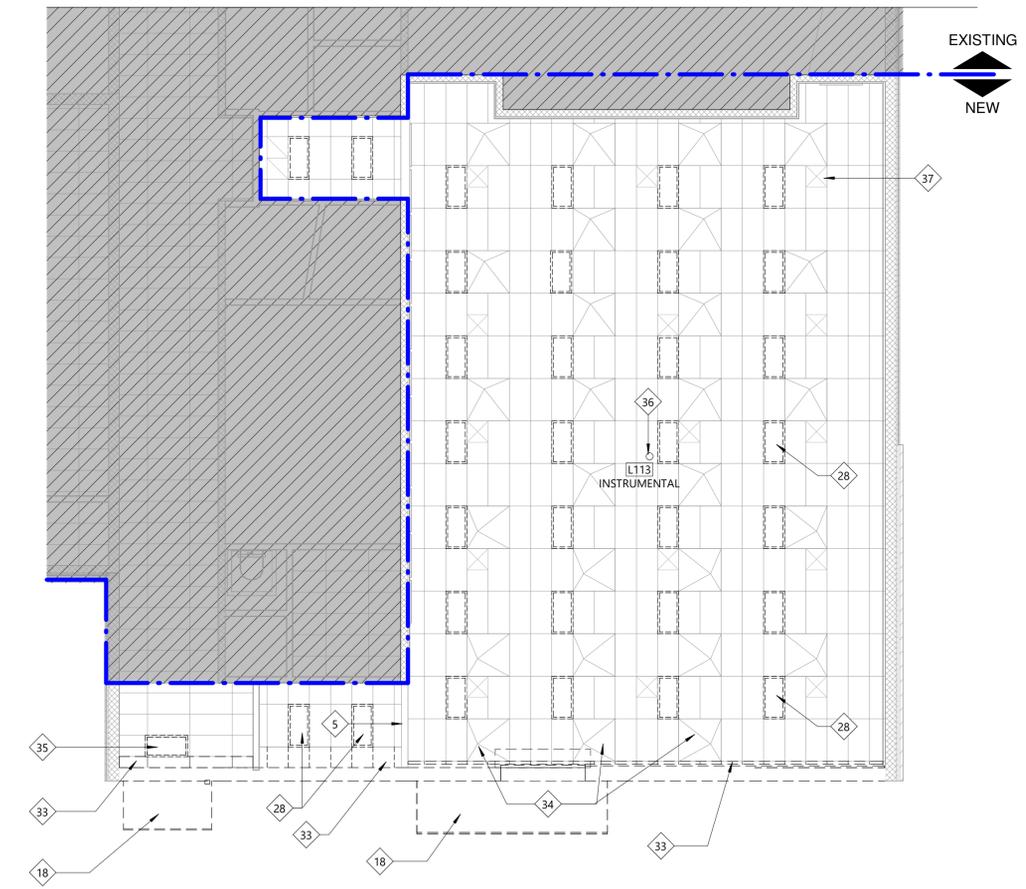


A11 First Floor Reflected Ceiling Demo Plan
1/8" = 1'-0"

Specialty Plan Legend

TV	TV MOUNTING BRACKET; RE-ELEC
(S)	WINDOW ROLLER SHADE
FEC	FIRE EXTINGUISHER CABINET, ALL FEC LOCATIONS TO BE NEW U.N.O
FEB-WC	FIRE EXTINGUISHER BRACKET- WET CHEMICAL
CG	CORNER GUARD
1	SIGN TYPE, RE- ROOM SIGNAGE SCHEDULE
6MB	6' MARKER BOARD, BOTTOM AT 3'-0" AFF
6MS	6' MARKER BOARD WITH STAFF LINES, BOTTOM AT 3'-0" AFF
16MB	16' MARKER BOARD, BOTTOM AT 3'-0" AFF
4TB	4' TACK BOARD, BOTTOM AT 3'-0" AFF
8TB	8' TACK BOARD, BOTTOM AT 3'-0" AFF
SB	INTERACTIVE DISPLAY BOARD (SMART BOARD), BY OWNER'S VENDOR CONTRACTOR
PT-1	ACCENT PAINT, RE- FINISH LEGEND AND GENERAL FINISH NOTE #25
X-TS	TACK STRIP - NUMBER REPRESENTS THE LINEAR FEET OF TACK STRIP. I.E. 12-TS = 12' OF TACK STRIP. ALL TACK STRIP LOCATIONS TO HAVE 2 ROWS OF TACK STRIPS. ONE STRIP AT 4'-0" AFF, ONE STRIP AT 5'-6" AFF
SS-1@C PL-1@A	MILLWORK FINISH CALLOUT; REFER TO FINISH LEGEND SUFFIX INDICATES LOCATION OF FINISH


Room SIGNAGE Schedule

ROOM NAME	DESIGN
CLASSROOM/OFFICE	TYPE 5
RESTROOM	TYPE 2
WOMEN/GIRLS RESTROOM	TYPE 1
MEN/ BOYS RESTROOM	TYPE 1
CUSTODIAN	TYPE 4
DATA	TYPE 4
STORAGE	TYPE 8
HEALTH CENTER	TYPE 8
ADMINISTRATION	TYPE 4
MEDIA CENTER	TYPE 4
TEACHERS' LOUNGE	TYPE 4
TEACHERS' WORKROOM	TYPE 4
GYMNASIUM	TYPE 8
CAFETERIA	TYPE 4
MECHANICAL/ELECTRICAL	TYPE 4
EXIT	TYPE 3
MAXIMUM OCCUPANCY 406	TYPE 6
MAXIMUM OCCUPANCY 225	TYPE 7
EXISTING SIGN TO BE REINSTALLED	
BLANK TO MATCH SIZE OF SIGN ON OPPOSITE SIDE OF GLASS	
EXTERIOR WINDOW SIGN	TYPE 9

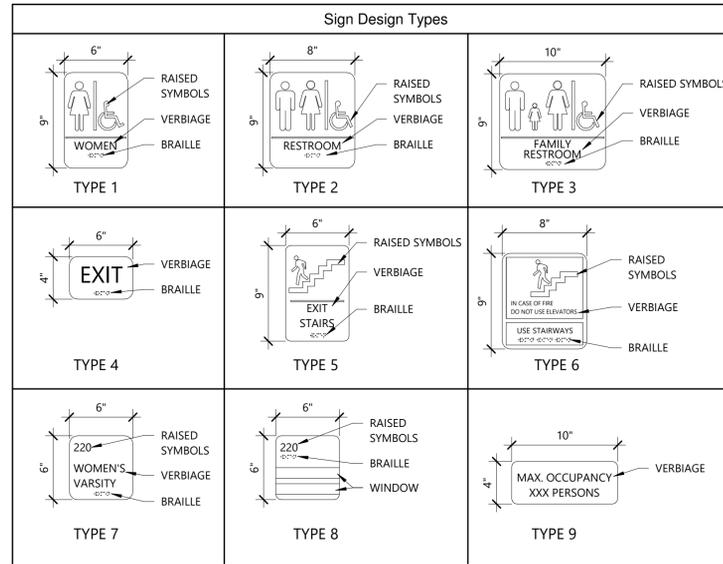


- ### General Finish Notes
- PROVIDE 1 LAYER 5/8" TYPE X GYPSUM BOARD AT METAL STUD WALLS, UNLESS OTHERWISE NOTED IN DRAWINGS.
 - REFER TO DRAWINGS FOR LOCATIONS OF ACOUSTICAL TREATMENTS (REFLECTED CEILING PLANS AND INTERIOR ELEVATIONS)
 - PROVIDE ZINC TERMINATION STRIP WHERE EPOXY FLOOR FINISH TRANSITIONS TO ANOTHER FLOOR MATERIAL.
 - REFER TO REFLECTED CEILING PLANS FOR ALL CEILING HEIGHTS AND METAL STUD WITH GYPSUM BOARD HEADWALLS AND FURR DOWN LOCATIONS.
 - UNLESS NOTED OTHERWISE, PAINT WALLS WITHOUT CEILINGS FULL HEIGHT TO UNDERSIDE OF DECK.
 - PROVIDE 6" THICK UNFACED BATT INSULATION IN ALL CEILINGS ABOVE TOILET AND RESTROOM LOCATIONS.
 - PROVIDE 3 1/2" MINIMUM THICK SOUND ATTENUATION INSULATION IN ALL STUD WALLS SURROUNDING ALL TOILET AND RESTROOM LOCATIONS.
 - PROVIDE 6" THICK UNFACED BATT INSULATION IN WALLS SEPARATING CLASSROOMS, VOCAL PRACTICE, INSTRUMENT PRACTICE, COMPUTER LABS, MEDIA CENTER, OFFICES AND CONFERENCE ROOMS FROM OTHER AREAS.
 - PROVIDE A 48" WIDE STRIP OF 6" THICK UNFACED BATT INSULATION ABOVE ALL CEILINGS ON BOTH SIDES OF WALL SEPARATING CLASSROOMS, OFFICES AND CONFERENCE ROOMS FROM OTHER AREAS.
 - ALL EXPOSED PIPE RAIL, STEEL STAIR COMPONENTS, ETCETERA, EXPOSED TO VIEW ARE TO RECEIVE PAINT, PT-3
 - PROVIDE CARPET FLOORING IN ELEVATOR CAB AND REFER TO SPECIFICATIONS FOR OTHER FINISHES INSIDE CAB--SHAFTS ARE TO REMAIN UNFINISHED.
 - REFER TO FLOOR PATTERN PLANS FOR FLOOR COVERING PATTERNS.
 - REFER TO CODE FOOTPRINT FOR FIRE SEPARATION WALLS.
 - PROVIDE OUTSIDE CORNER GUARDS AS SPECIFIED ON ALL GYPSUM BOARD OUTSIDE CORNERS UNLESS NOTED OTHERWISE.
 - UNLESS NOTED OR SHOWN ON DRAWINGS OTHERWISE, TERMINATE ALL NON-BEARING, NON-RATED PARTITIONS A MINIMUM 6" TO 8" ABOVE HIGHEST ADJACENT CEILINGS.
 - REFER TO REFLECTED CEILING PLANS FOR
 - UNLESS SHOWN OTHERWISE PROVIDE 4" FINISH IS SCHEDULED.
 - PROVIDE 6" EPOXY COVE BASE IN KITCHEN AND KITCHEN SLAB PRIOR TO APPLYING FINAL FINISH. EXTEND EPOXY FLOORING TIGHT TO INTERSECTION OF ADJACENT WALLS.
 - PROVIDE CONCRETE GROUT INFILL IN FLOOR FINISH TO MEET LOCAL HEALTH DEPARTMENT REQUIREMENTS.
 - APPLY 2-COAT MINIMUM OF BLOCK FILLER
 - PROVIDE SOLID WOOD BLOCKING IN WALL LECTURES UNIT AND TOILET ACCESSORIES
 - ALL WALLS TIGHT TO DECK AT PLENUM SPACES TO A DIFFERENT FLOOR MATERIAL.
 - PROVIDE TRANSITION STRIP AS SPECIFIED
 - REFER TO ELECTRICAL DRAWINGS FOR ALL SWITCHES WITH MILLWORK.
 - ACCENT PAINT MARKER INDICATES SURFACE AT THE END OF WALL OR INTERSECTION OF ADJACENT WALL.
 - FLOOR MATERIAL TRANSITIONS AT DOOR POSITION. FLOOR PATTERN PLANS ARE TO SHOW MATERIAL COLOR AND LAYOUT ONLY.
 - AT WALLS WITH INSULATION THAT ONLY HAVE GYPSUM BOARD ON ONE SIDE OF THE WALL PROVIDE METAL STRAPPING TO SECURE THE INSULATION IN PLACE.
 - ALL HOLLOW METAL DOORS AND FRAMES TO BE PAINTED PT-3, INTERIOR AND EXTERIOR.
 - REFER TO SPECIALTY PLANS FOR DETAILED FINISH INFORMATION, COLORS, & ACCENT WALLS NOT FOUND IN FINISH SCHEDULE.
 - ALL EXPOSED STEEL PIPE RAIL, STEEL STAIR COMPONENTS, ETC., EXPOSED TO VIEW ARE TO RECEIVE PAINT.
 - PROVIDE CLEAR CONCRETE SEALER AT ALL EXPOSED CONCRETE FLOORS, BLEACHER TREADS, AND CONCRETE STEPS.
 - PROVIDE 6" UNFACED INSULATION IN ALL EXTERIOR WALLS.
 - PROVIDE 4" WIDE FRP PANELS AT ALL MOP SINK LOCATIONS TO HEIGHT OF 4'-0" AFF AT GYPSUM BOARD WALLS AND AS NOTED ON DRAWINGS.
 - REFER TO TOILET ELEVATIONS FOR LOCATIONS AND HEIGHT OF CERAMIC WALL TILE. PROVIDE CEMENT BOARD BACKER BEHIND ALL CERAMIC WALL TILE.
 - IN ROOMS SHOWN TO TAPE AND FLOAT GYPSUM BOARD OR NOT TO PAINT CMU, WALLS ARE TO BE CLEANED OF ANY MARKING OR DIRT. ALL GYPSUM BOARD IS TO BE REPAIRED IF DAMAGED.
 - COUNTERTOP TO BE SOLID SURFACE AT ALL MILLWORK LOCATIONS WITH SINKS, UNLESS NOTED OTHERWISE. REFER TO MILLWORK ELEVATIONS AND SECTIONS.
 - ALL HOLLOW METAL DOORS AND FRAMES TO BE PAINTED, INTERIOR AND EXTERIOR.
 - AT FRY REGLET REVEAL FILL GAP CREATED BEHIND FLOOR BASE WITH FILLER AND SEALANT TO TOP OF BASE TO MATCH BASE COLOR.
 - DO NOT PAINT FRY REGLET REVEALS, OR PAINT FRY REGLET REVEALS
 - AT FIRE RATED WALLS WHERE FIRE CAULK WILL BE EXPOSED, BACKSET FIRE CAULK AND CAULK OVER WITH COLOR MATCH CAULK.
 - FASCIA OF WINDOWSHADES TO BE MOUNTED FLUSH WITH INTERIOR GYP. BOARD WALL SURFACE.


- ### Keyed Finish Notes (KN-1)
- PROVIDE 6" SOUND BATT INSULATION ABOVE ENTIRE CEILING
 - PROVIDE PLASTIC LAMINATE PL-3 AT EXPOSED SHELVING
 - CERAMIC TILE AT RESTROOM WALLS, REFER TO RESTROOM ELEVATIONS FOR PATTERN AND COLORS
 - GYP. BD. WALLS TO BE COVERED WITH FRP FROM TOP OF EPOXY BASE
 - PROVIDE (2) 4'-0" X 6'-0" TECTUM WALL PANELS (TP), CENTER EACH PANEL ON WALL

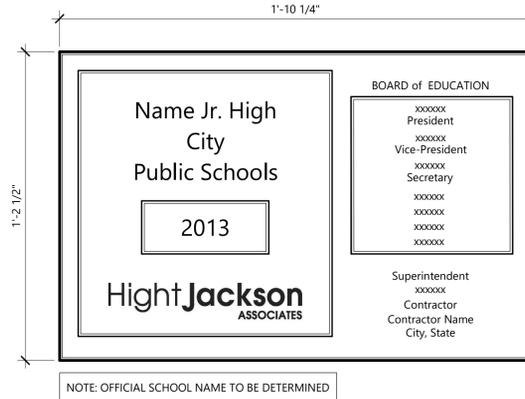

SIGN SHALL BE MOUNTED ON THE WALL ADJACENT TO LATCH SIDE OF DOOR. WHERE THERE IS NO WALL SPACE TO THE LATCH SIDE OF THE DOOR, SIGNS SHALL BE PLACED ON THE NEAREST ADJACENT WALL. MOUNTING HEIGHT SHALL BE 60" A.F.F. TO THE TOP OF SIGN. MOUNTING LOCATION FOR SIGN SHALL BE SO THAT A PERSON MAY APPROACH WITHIN 3" OF SIGNAGE WITHOUT ENCOUNTERING PROTRUDING OBJECTS OR STANDING WITHIN THE SWING OF A DOOR.

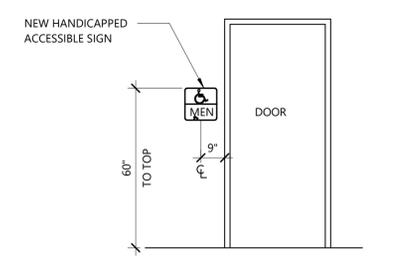

3 Room Signage Detail
3/8" = 1'-0"

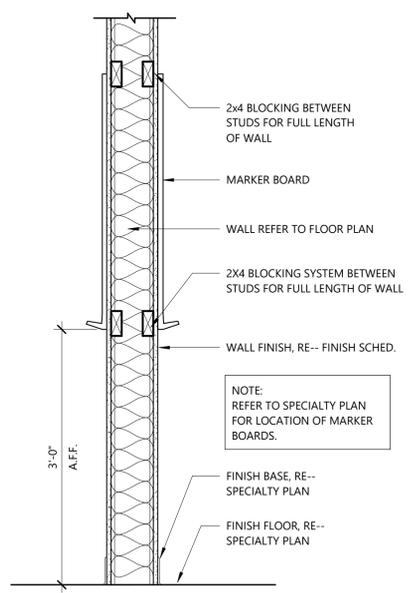

1 A2.3 - Markerboard Detail
1" = 1'-0"

Finish Legend

FINISH	DESCRIPTION	MANUFACTURER / COLOR	
BASE	EB-1	4" EPOXY BASE	EPOXY BASE TO MATCH EF-1
BASE	NB	NO BASE	--
BASE	RB	RUBBER BASE	MANUF. COLOR #
CEILING	AC-1	2' X 4' ACOUSTICAL CEILING TILE	xxxCOLORxx SUSPENDED ACOUSTICAL CEILING
CEILING	ES	EXPOSED STRUCTURE	NO PAINT
CEILING	ESP-X	EXPOSED STRUCTURE PAINTED	"X" REPRESENTS PAINT NUMBER FROM WALL COLOR LISTED BELOW, DRY FALL
CEILING	PT-X	PAINTED GYPSUM BOARD	"X" REPRESENTS PAINT NUMBER FROM WALL COLOR LISTED BELOW, DRY FALL
FLOORS	CPT-1	CARPET TILE, xxSIZExx	MANUF. COLOR #
FLOORS	EF-1	EPOXY FLOORING	MANUF. COLOR # OR (LOCATION, I.E.-RESTROOMS)
FLOORS	SC	SEALED CONCRETE	--
MILLWORK	HPL-1	PLASTIC LAMINATE COUNTERTOP	MANUF. COLOR #
MILLWORK	SS-1	SOLID SURFACE COUNTERTOP	MANUF. COLOR #
MILLWORK	TFL-1	THERMALLY FUSED LAMINATE (MELAMINE) CABINET BODY	MANUF. COLOR #
OTHER	DOORS	WOOD DOORS	SPECIES: FINISH
OTHER	TP	TOILET PARTITIONS	MANUF. COLOR #
WALLS	EP-X	EPOXY PAINT	"X" REPRESENTS PAINT NUMBER FROM THE PT WALL COLOR LISTED BELOW
WALLS	FRP	FIBERGLASS REINFORCED PANEL	COLOR TBD
WALLS	PT-1	PAINT, TYP WALL COLOR	MANUF. COLOR #
WALLS	PT-2	PAINT, TYP CEILING COLOR	MANUF. COLOR #
WALLS	PT-3	PAINT, TYP DOOR FRAME COLOR	MANUF. COLOR #
WALLS	PT-4	ACCENT PAINT COLOR	MANUF. COLOR #

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An Addition for BWHS
BWHS Band Addition
 1351 GAMBLE RD CENTERTON, AR

DRAWN BY: MS
 CHECK BY: TS
 ISSUE DATE: 02/02/2026
 PROJECT NO: 2421
 REVISION DATES:

FINISH SCHEDULE / NOTES / PLAN DETAILS
 S H E E T
A2.2
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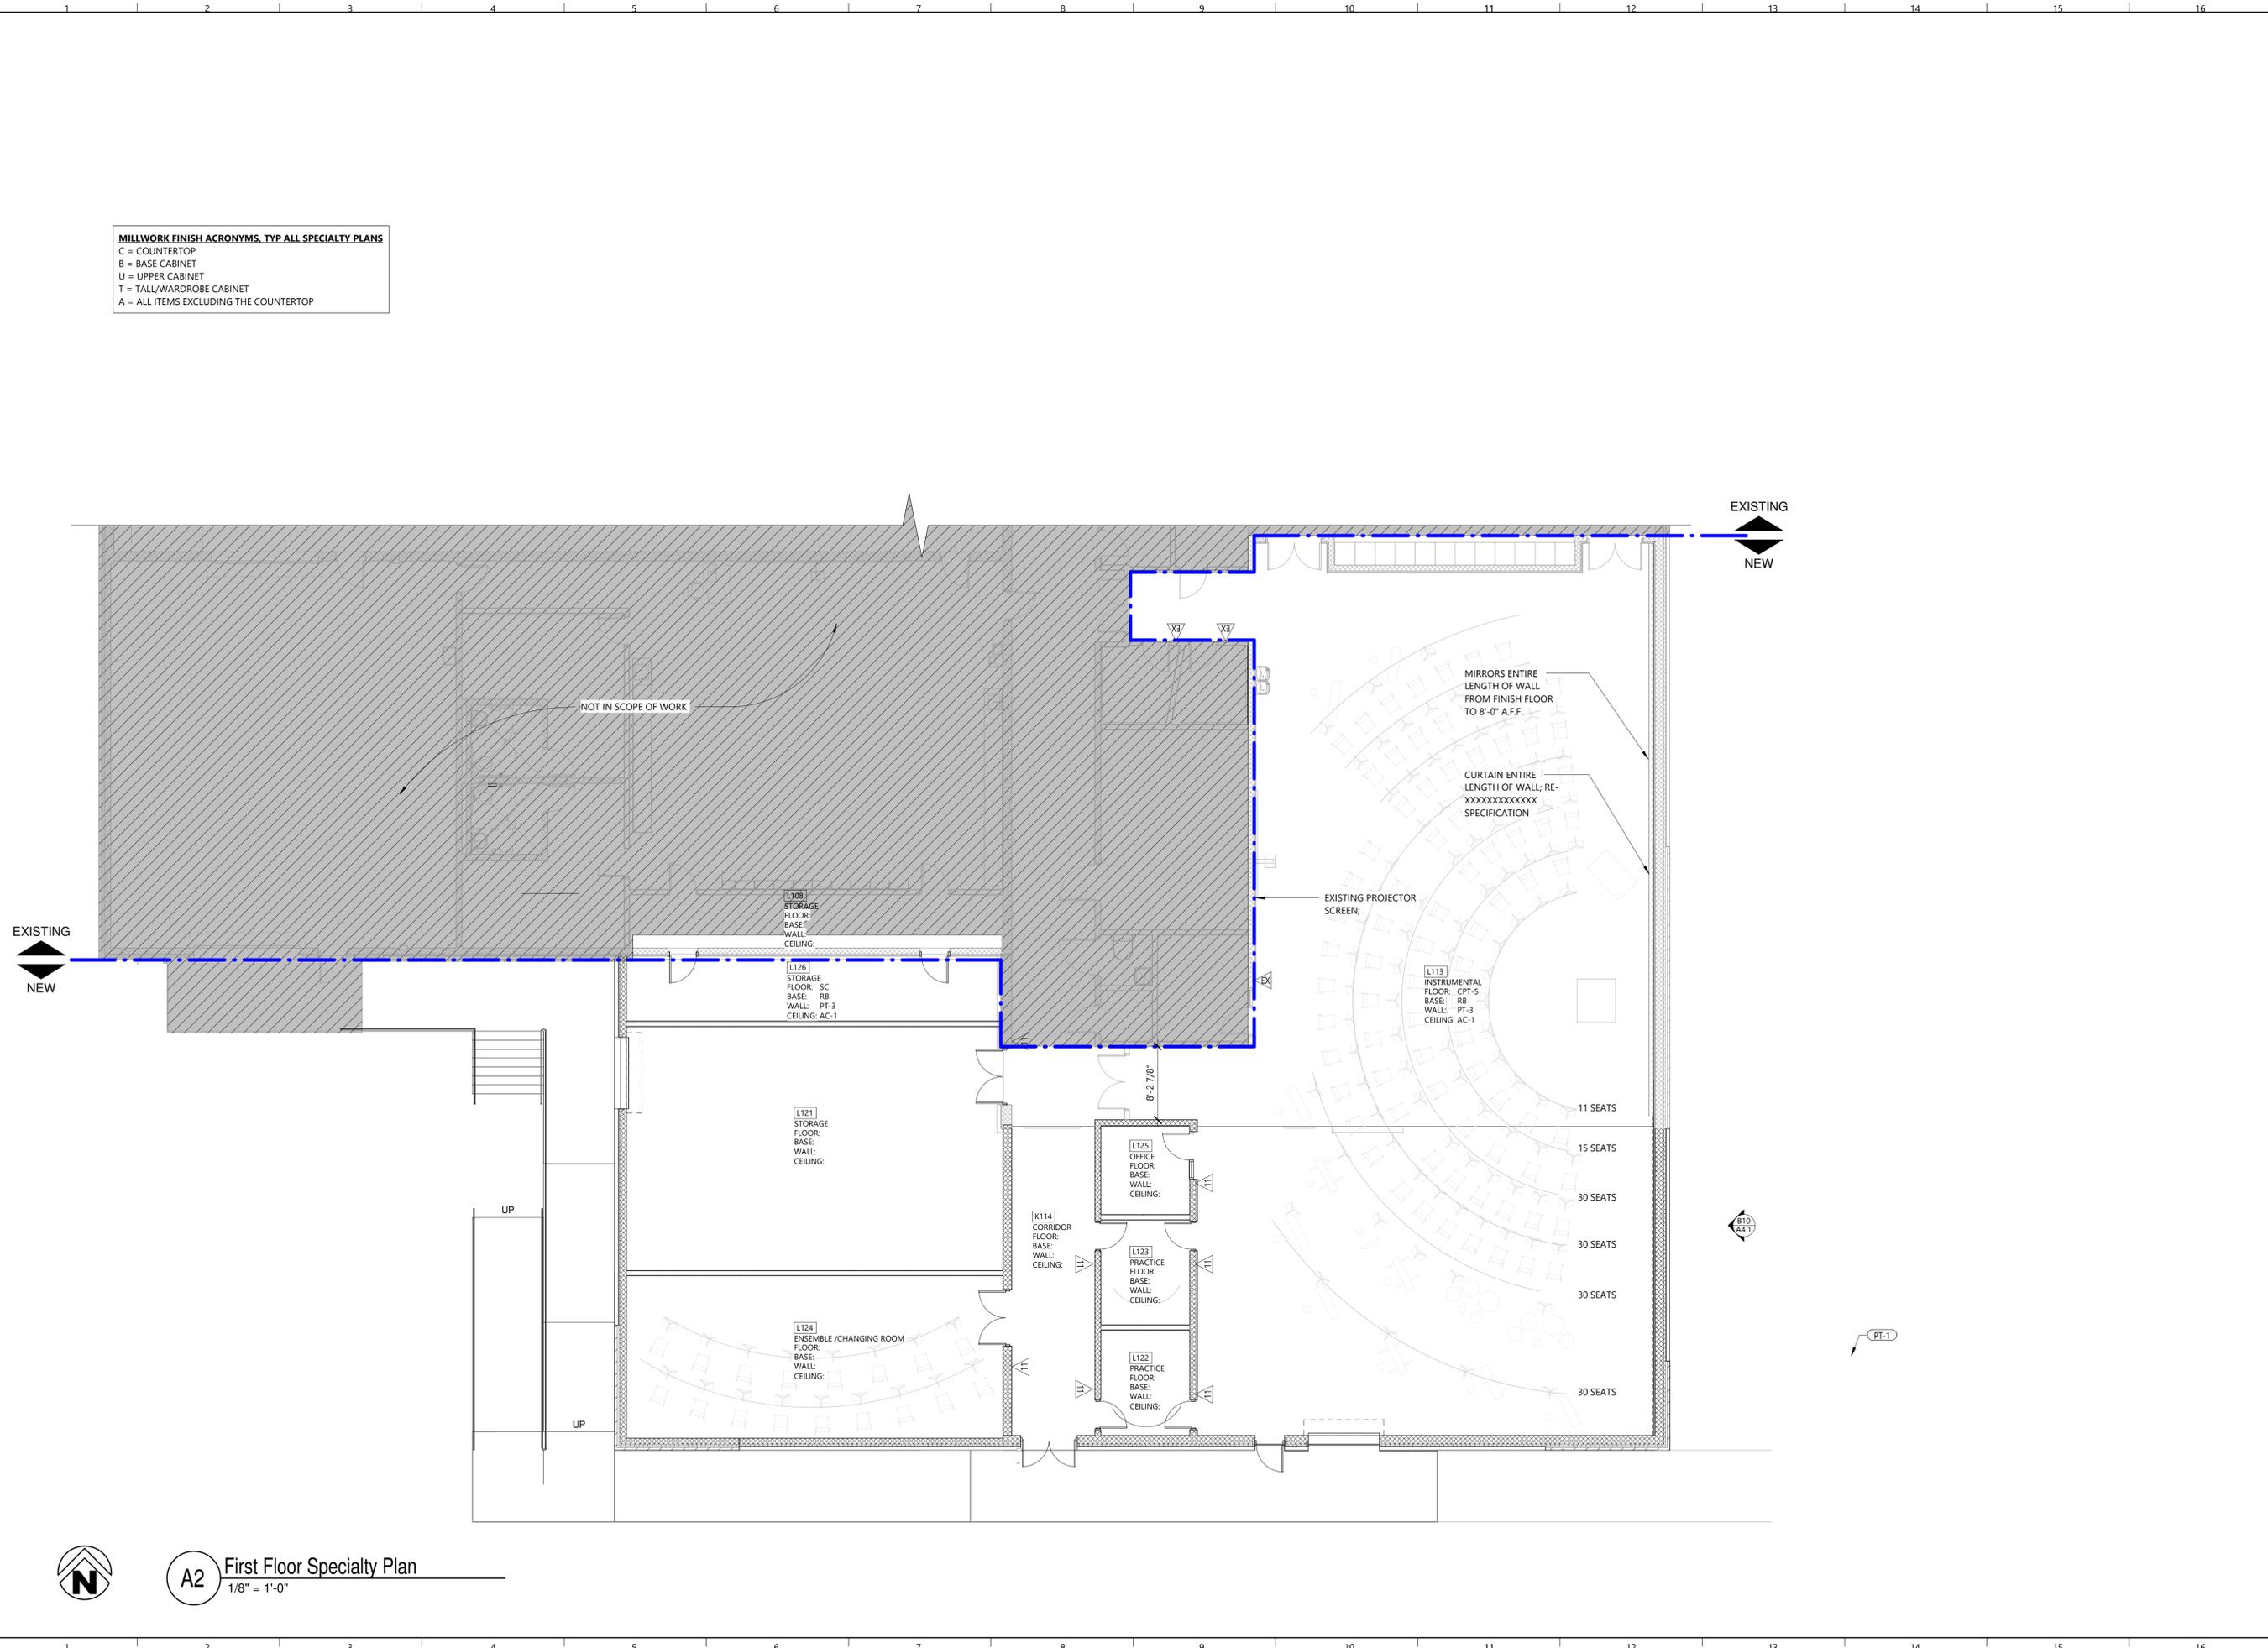
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REVISION DATES

SPECIALTY PLAN
S H E E T
A2.3A

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MILLWORK FINISH ACRONYMS, TYP ALL SPECIALTY PLANS
C = COUNTERTOP
B = BASE CABINET
U = UPPER CABINET
T = TALL/WARDROBE CABINET
A = ALL ITEMS EXCLUDING THE COUNTERTOP



EXISTING
NEW

EXISTING
NEW

NOT IN SCOPE OF WORK

MIRRORS ENTIRE LENGTH OF WALL FROM FINISH FLOOR TO 8'-0" A.F.F.

CURTAIN ENTIRE LENGTH OF WALL; RE-XXXXXXXXXXXXXXXXX SPECIFICATION

EXISTING PROJECTOR SCREEN;

L113 INSTRUMENTAL FLOOR: CPT-5
BASE: RB
WALL: PT-3
CEILING: AC-1

L108 STORAGE FLOOR: SC
BASE: RB
WALL: PT-3
CEILING: AC-1

L126 STORAGE FLOOR: SC
BASE: RB
WALL: PT-3
CEILING: AC-1

L121 STORAGE FLOOR: SC
BASE: RB
WALL: PT-3
CEILING: AC-1

L125 OFFICE FLOOR: SC
BASE: RB
WALL: PT-3
CEILING: AC-1

L123 PRACTICE FLOOR: SC
BASE: RB
WALL: PT-3
CEILING: AC-1

L122 PRACTICE FLOOR: SC
BASE: RB
WALL: PT-3
CEILING: AC-1

L124 ENSEMBLE/CHANGING ROOM FLOOR: SC
BASE: RB
WALL: PT-3
CEILING: AC-1


K114 CORRIDOR FLOOR: SC
BASE: RB
WALL: PT-3
CEILING: AC-1

B10
A41

PT-1



A2 First Floor Specialty Plan
1/8" = 1'-0"

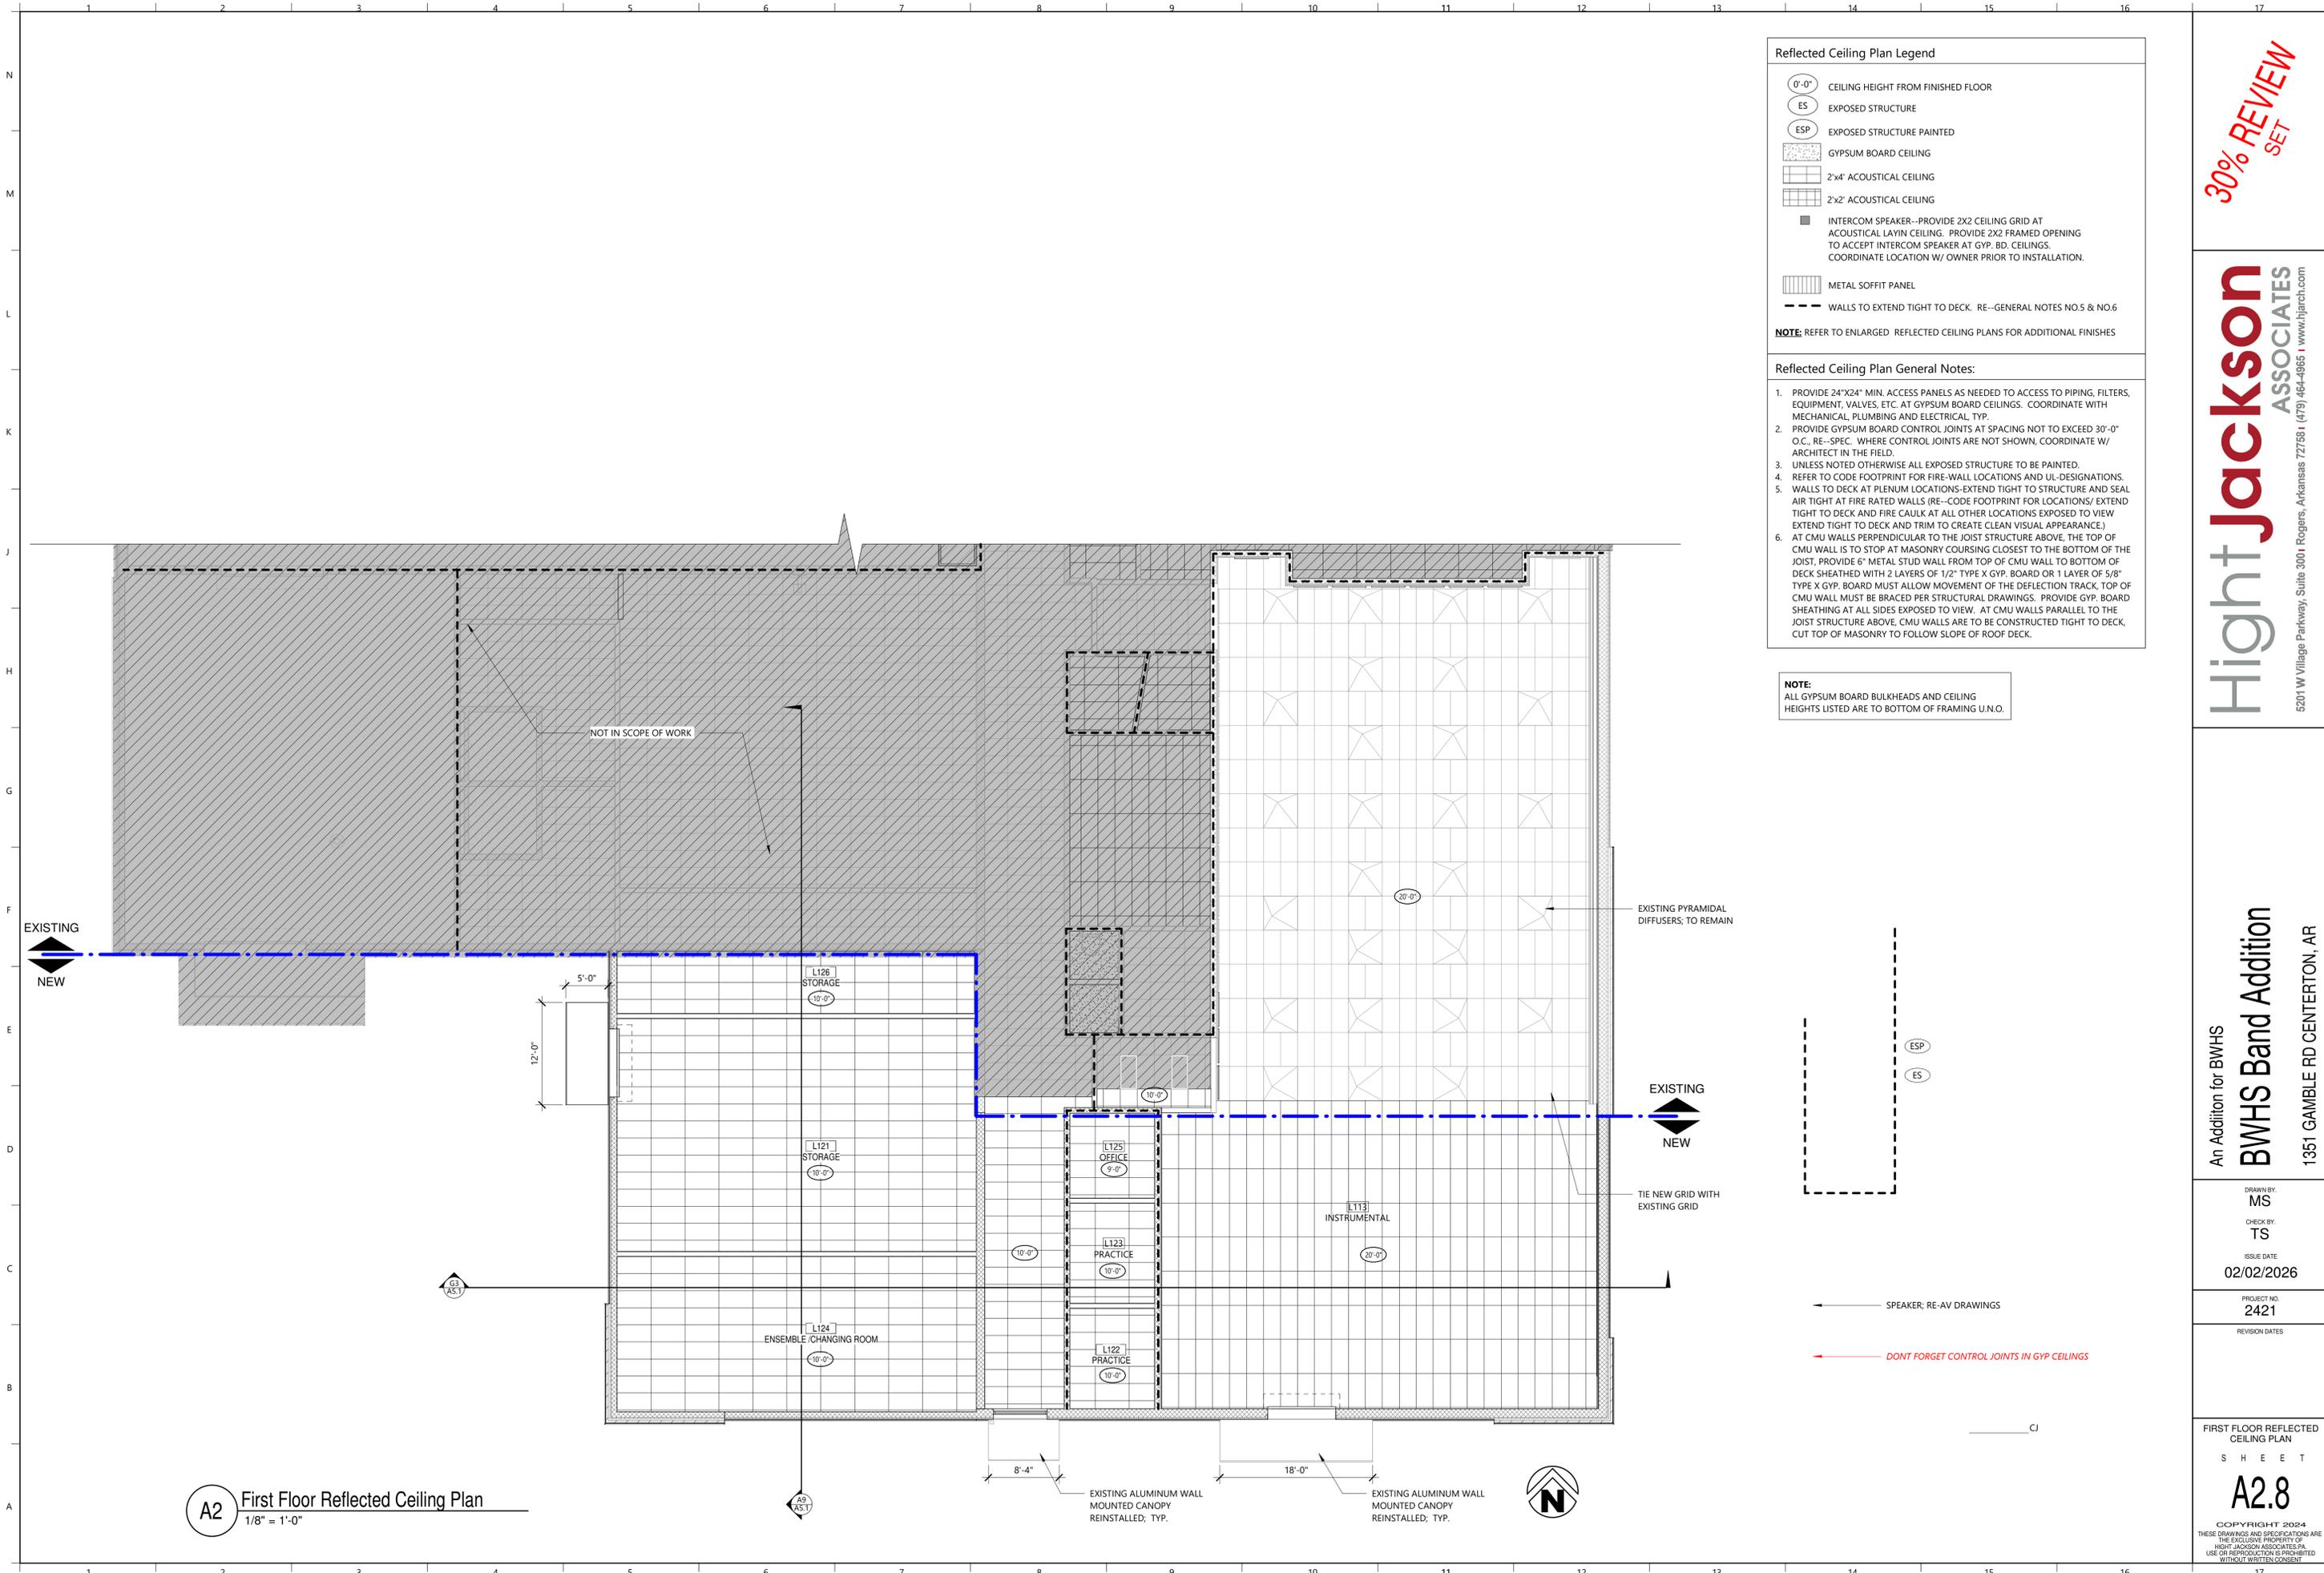


Reflected Ceiling Plan Legend

0'-0"	CEILING HEIGHT FROM FINISHED FLOOR
ES	EXPOSED STRUCTURE
ESP	EXPOSED STRUCTURE PAINTED
[Pattern]	GYPSUM BOARD CEILING
[Pattern]	2"x4" ACOUSTICAL CEILING
[Pattern]	2"x2" ACOUSTICAL CEILING
[Symbol]	INTERCOM SPEAKER--PROVIDE 2X2 CEILING GRID AT ACOUSTICAL LAYIN CEILING. PROVIDE 2X2 FRAMED OPENING TO ACCEPT INTERCOM SPEAKER AT GYP. BD. CEILINGS. COORDINATE LOCATION W/ OWNER PRIOR TO INSTALLATION.
[Pattern]	METAL SOFFIT PANEL
[Symbol]	WALLS TO EXTEND TIGHT TO DECK. RE--GENERAL NOTES NO.5 & NO.6

NOTE: REFER TO ENLARGED REFLECTED CEILING PLANS FOR ADDITIONAL FINISHES

- Reflected Ceiling Plan General Notes:**
1. PROVIDE 24"x24" MIN. ACCESS PANELS AS NEEDED TO ACCESS TO PIPING, FILTERS, EQUIPMENT, VALVES, ETC. AT GYPSUM BOARD CEILINGS. COORDINATE WITH MECHANICAL, PLUMBING AND ELECTRICAL, TYP.
 2. PROVIDE GYPSUM BOARD CONTROL JOINTS AT SPACING NOT TO EXCEED 30'-0" O.C., RE--SPEC. WHERE CONTROL JOINTS ARE NOT SHOWN, COORDINATE W/ ARCHITECT IN THE FIELD.
 3. UNLESS NOTED OTHERWISE ALL EXPOSED STRUCTURE TO BE PAINTED.
 4. REFER TO CODE FOOTPRINT FOR FIRE-WALL LOCATIONS AND UL-DESIGNATIONS.
 5. WALLS TO DECK AT PLENUM LOCATIONS--EXTEND TIGHT TO STRUCTURE AND SEAL AIR TIGHT AT FIRE RATED WALLS (RE--CODE FOOTPRINT FOR LOCATIONS/ EXTEND TIGHT TO DECK AND FIRE CAULK AT ALL OTHER LOCATIONS EXPOSED TO VIEW EXTEND TIGHT TO DECK AND TRIM TO CREATE CLEAN VISUAL APPEARANCE.)
 6. AT CMU WALLS PERPENDICULAR TO THE JOIST STRUCTURE ABOVE, THE TOP OF CMU WALL IS TO STOP AT MASONRY COURSING CLOSEST TO THE BOTTOM OF THE JOIST, PROVIDE 6" METAL STUD WALL FROM TOP OF CMU WALL TO BOTTOM OF DECK SHEATHED WITH 2 LAYERS OF 1/2" TYPE X GYP. BOARD OR 1 LAYER OF 5/8" TYPE X GYP. BOARD MUST ALLOW MOVEMENT OF THE DEFLECTION TRACK, TOP OF CMU WALL MUST BE BRACED PER STRUCTURAL DRAWINGS. PROVIDE GYP. BOARD SHEATHING AT ALL SIDES EXPOSED TO VIEW. AT CMU WALLS PARALLEL TO THE JOIST STRUCTURE ABOVE, CMU WALLS ARE TO BE CONSTRUCTED TIGHT TO DECK, CUT TOP OF MASONRY TO FOLLOW SLOPE OF ROOF DECK.

NOTE:
ALL GYPSUM BOARD BULKHEADS AND CEILING HEIGHTS LISTED ARE TO BOTTOM OF FRAMING U.N.O.

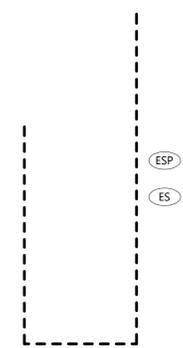

A2 First Floor Reflected Ceiling Plan
1/8" = 1'-0"


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BWHS Band Addition
1351 GAMBLE RD CENTERTON, AR

DRAWN BY: MS
CHECK BY: TS
ISSUE DATE: 02/02/2026
PROJECT NO: 2421
REVISION DATES:

FIRST FLOOR REFLECTED CEILING PLAN
SHEET
A2.8
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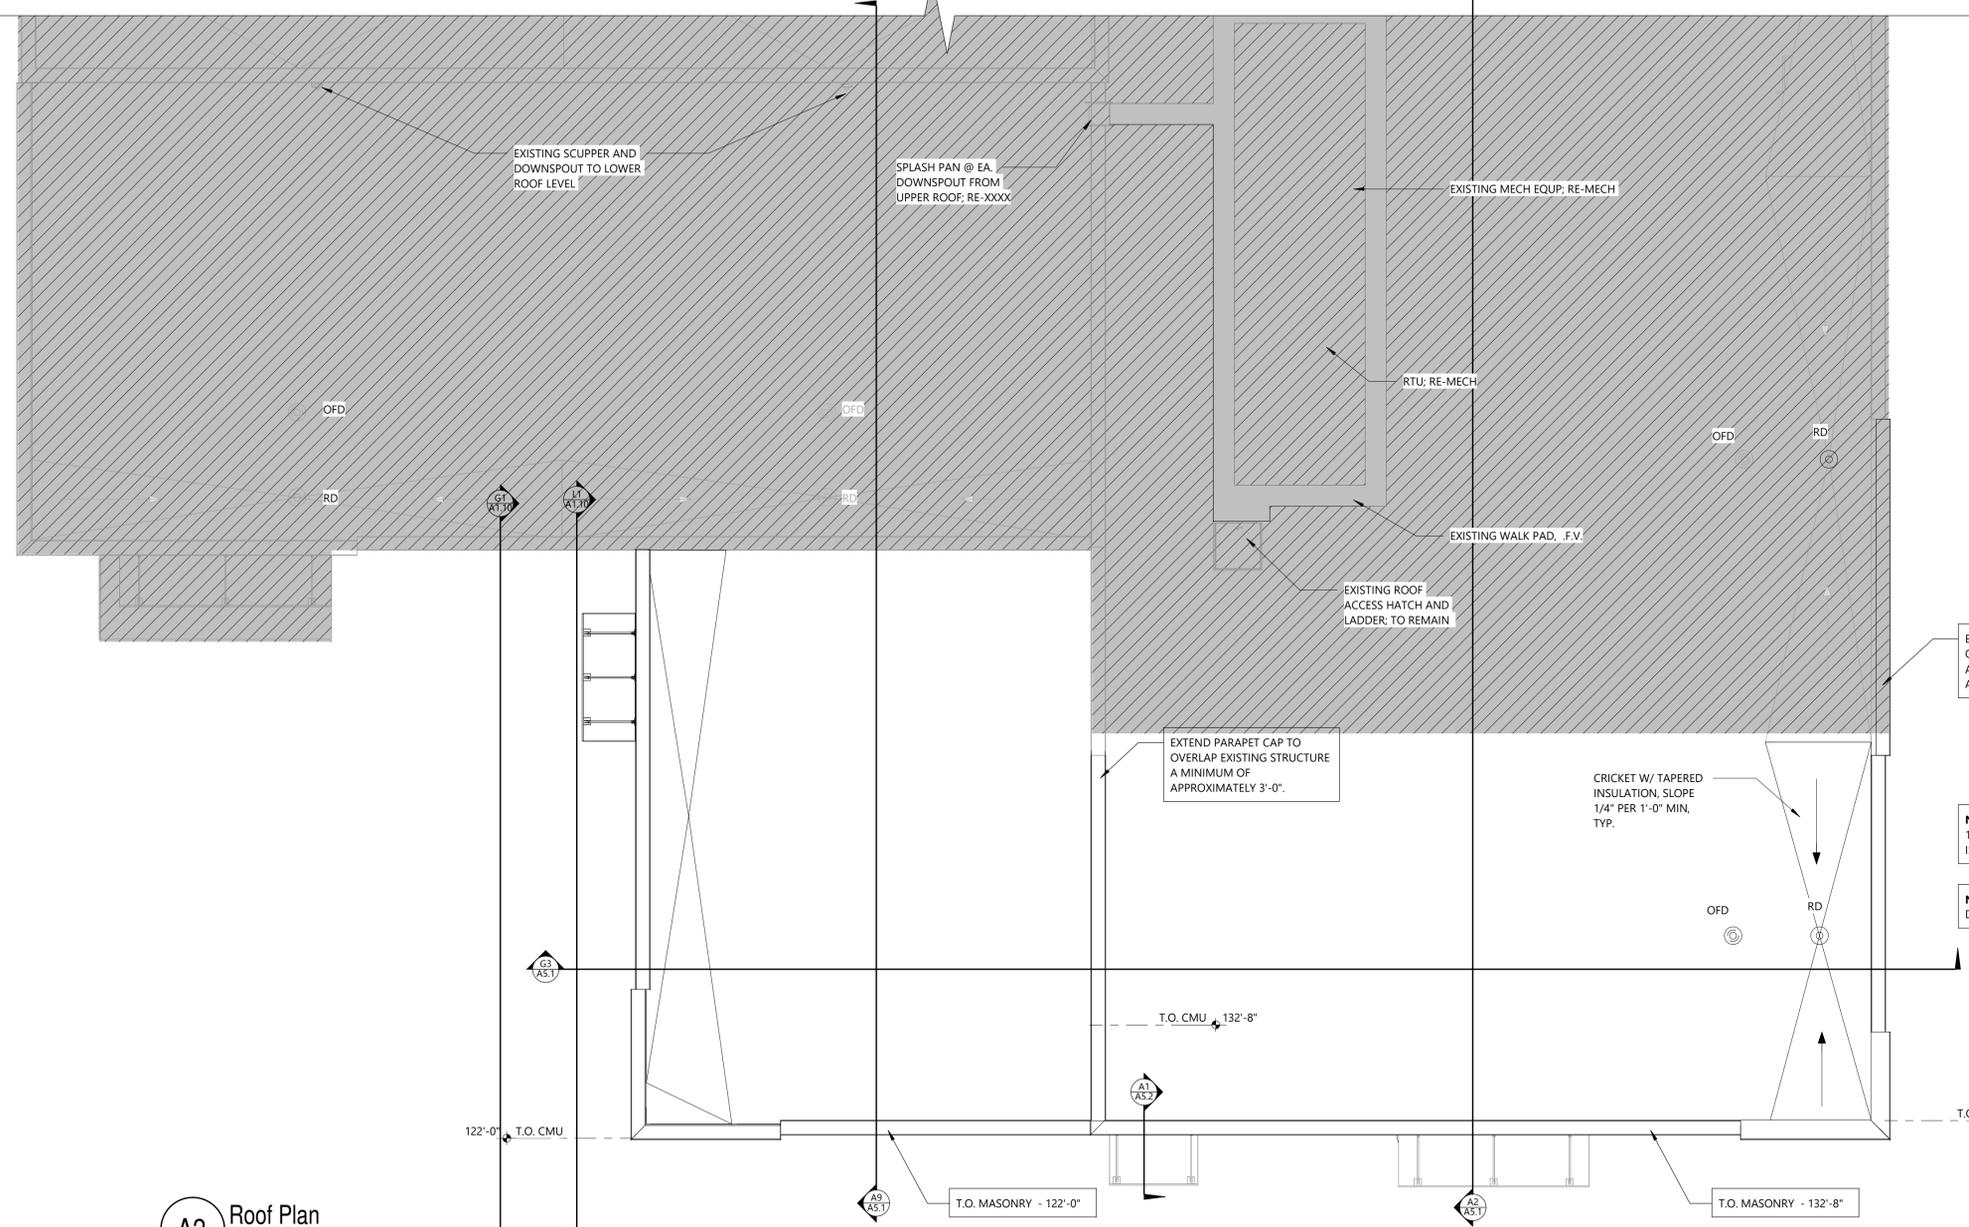


- ROOF PLAN GENERAL NOTES**
1. ALL "FLAT" ROOFS TO BE PROVIDED WITH A MINIMUM SLOPE OF 1/4" : 12. NO PONDING WATER IS ALLOWED
 2. MAINTAIN A 6'-0" MINIMUM DISTANCE BETWEEN ROOF DRAINS AND THE BACK OF PARAPET WALLS
 3. ALL DOWNSPOUTS THAT DISCHARGE ONTO A LOWER ROOF ARE TO BE PROVIDED WITH A METAL SPLASH PAN PER DETAIL XX/XXX
 4. ALL UTILITIES ON ROOF TO BE PROVIDED WITH THE PROPER SUPPORTS; REF-PLUMBING AND ELECTRICAL
 5. ALL EXPOSED GAS PIPING TO BE PAINTED, REFER TO PLUMBING SPECIFICATIONS
 6. CONDENSATE DRAIN LINES TO DISCHARGE DIRECTLY INTO ROOF DRAIN OR GUTTER. DO NOT DISCHARGE ONTO ROOF SURFACE
 7. ROOF HATCH TO BE PAINTED PER SPECIFICATIONS

K1 Parapet Detail
1 1/2" = 1'-0"

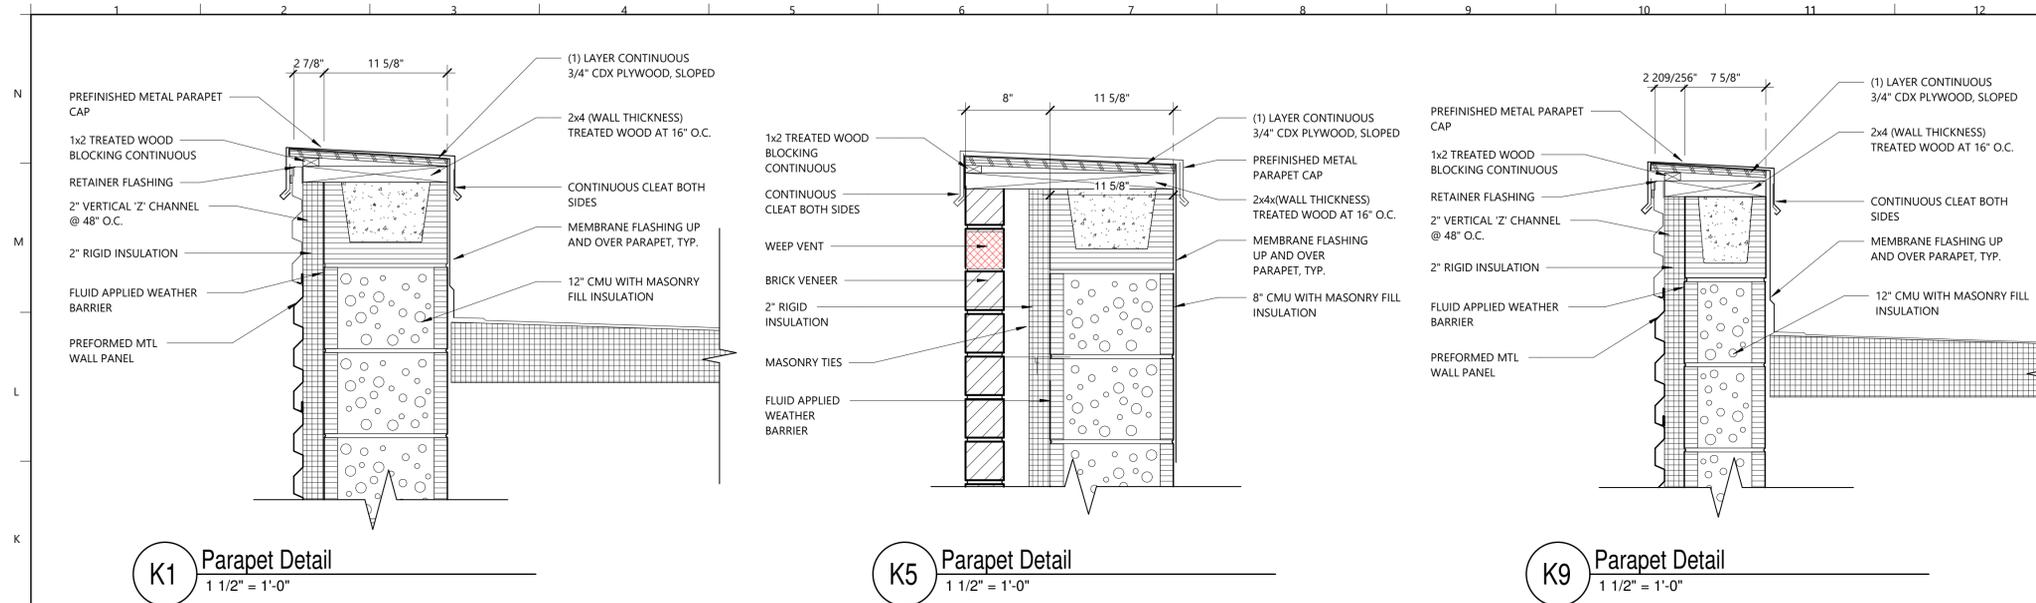K5 Parapet Detail
1 1/2" = 1'-0"

K9 Parapet Detail
1 1/2" = 1'-0"



A2 Roof Plan
1/8" = 1'-0"

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1351 GAMBLE RD CENTERTON, AR


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PROJECT NO: 2421

REVISION DATES

ROOF PLAN
SHEET
A2.10
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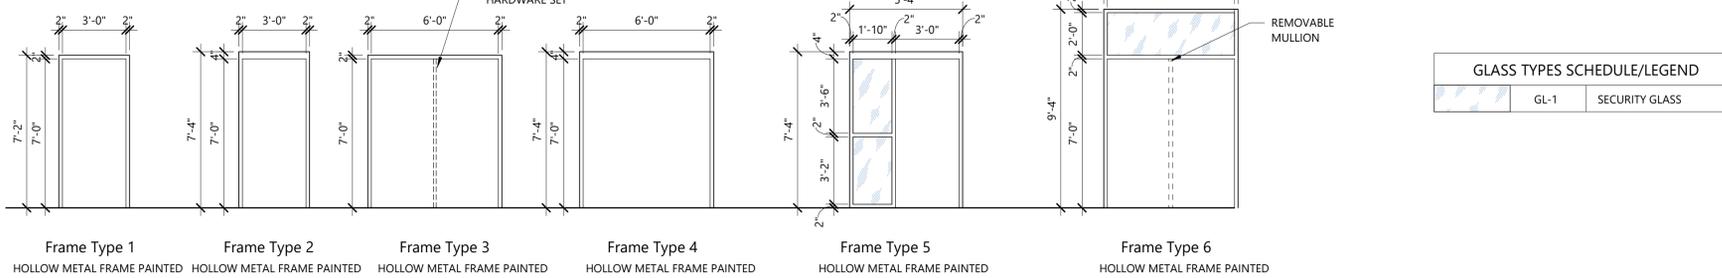
Door Types



Door Frame & Window Frame General Notes

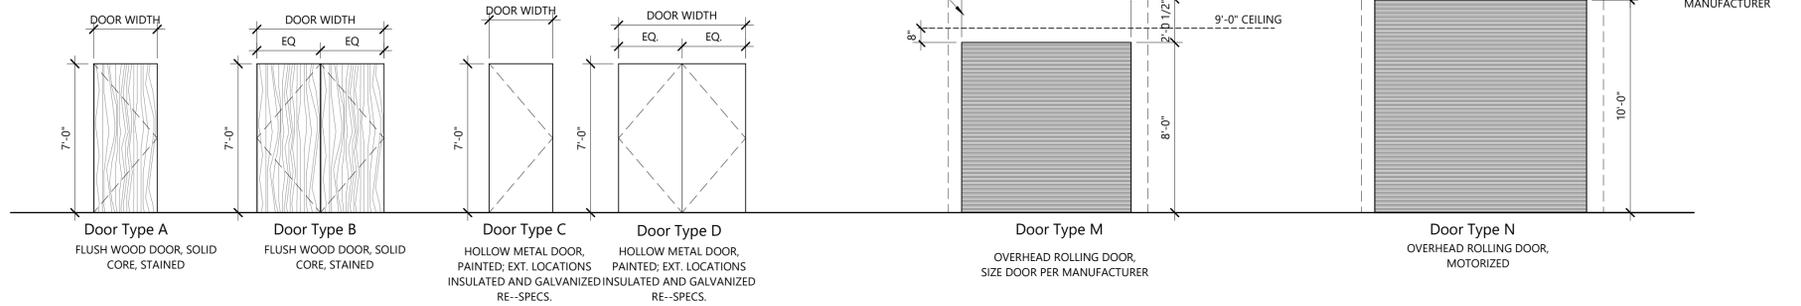- These are door frame general notes
- Go to ROWS --> INSERT --> DATA ROW to add new lines
- PROVIDE BLOCKING IN GYPSUM BOARD AND STUD WALLS TO ATTACH AND SUPPORT ALL WALL MOUNTED HARDWARE
- PROVIDE REINFORCING IN HOLLOW METAL AND ALUMINUM DOOR AND FRAMES AS REQUIRED TO PROPERLY SECURE HARDWARE, RE- SPECS
- PROVIDE SILENCERS FOR ALL HOLLOW METAL DOOR FRAMES UNLESS WEATHER STRIPPING IS PROVIDED
- ANCHOR THE RECEIVING END OF RECESSED FLUSH BOLTS AND SURFACE MOUNTED BOLTS IN EPOXY CONCRETE AT CONCRETE FLOORS
- REFER TO DOOR TAG AND SPECIFICATION SECTION 08 71 00 FOR HARDWARE SETS AT HOLLOW METAL DOOR FRAMES
- DOOR LEAVES ARE STANDARD 3'-0" WIDE AND 7'-0" HIGH. REFER TO FLOOR PLAN DIMENSIONS AND NOTES ON DOOR SCHEDULE FOR EXCEPTIONS
- DETAILS TO NOT INDICATE DOOR SWING. REFER TO ARCHITECTURAL FLOOR PLANS FOR DOOR SWING
- CONTRACTOR IS RESPONSIBLE FOR VERIFICATION AND COORDINATION OF FRAME THROAT DEPTHS WITH WALL THICKNESS PRIOR TO ORDERING FRAMES
- EACH LEAF OF ALL EXTERIOR HOLLOW METAL DOORS, UNLESS NOTED OTHERWISE, IS TO RECEIVE THE FOLLOWING ITEMS: ADA ACCESSIBLE CLOSER, CONTINUOUS HINGES, WEATHERSTRIPPING SET, ADA THRESHOLD (SET IN BUTYL RUBBER SEALANT), REMOVABLE MULLION (FOR PAIR OF DOORS), MULLION SEAL (FOR REMOVABLE MULLIONS), DOOR SHOE, DRIP CAP, RIM MOUNTED EXIT AND VANDAL RESISTANT TRIM (RE- HARDWARE SETS IN SPEC. SECTION 08 71 00)
- WHERE FLOOR MOUNTED STOPS AND OVERHEAD STOPS ARE USED ON THE SAME DOOR, ALIGN STOPS SO THAT DOOR DOES NOT TWIST WHEN HELD AGAINST STOPS
- COORDINATE MOUNTING HEIGHTS OF LATCHES, EXIT DEVICES AND OTHER HARDWARE ITEMS WITH DOOR LITE DIMENSIONS
- PROVIDE CONTINUOUS HINGES ON ALL EXTERIOR HOLLOW METAL AND ALUMINUM STOREFRONT DOORS AND VESTIBULE ALUMINUM STOREFRONT DOORS
- FOR ALL DOORS UP TO 3'-0" WIDE- LEAFS ARE TO HAVE 3 HINGES ON EACH LEAF UNLESS NOTED OTHERWISE. DOORS 3'-6" AND WIDER ARE TO HAVE 4 HINGES ON EACH LEAF, UNLESS NOTED OTHERWISE
- PROVIDE GALVANIZED, INSULATED, HOLLOW METAL DOORS AT EXTERIOR LOCATIONS
- ALL CLOSERS TO HAVE PARALLEL ARMS, UNLESS NOTED OTHERWISE OR INSTALLATION REQUIRES ALTERNATE ARM TYPE
- PROVIDE FIRE GASKET AROUND PERIMETER OF ALL FIRE RATED DOORS IN ACCORDANCE WITH INTERNATIONAL BUILDING CODE.
- VERIFY LINTEL CONDITIONS WITH STRUCTURAL LINTEL PLAN
- REFER TO DOOR TAGS AND SPEC. SECTION 08 43 13 FOR HARDWARE SETS AT ALUMINUM STOREFRONT FRAMES

Door Frame Types






GLASS TYPES SCHEDULE/LEGEND	
	GL-1 SECURITY GLASS

Access Control Notes


- THESE ARE DOOR GENERAL NOTES
- SO KEEP TYPING AWAY...
- AT DOORS TO BE CONTROLLED BY ACCESS CONTROL SYSTEM, COORDINATE LOCATION AND INSTALLATION OF JUNCTION BOXES AND CONDUIT WITH THE ELECTRICIAN AND ACCESS CONTROL CONTRACTOR.
- CONDUIT MUST BE ROUTED FROM AN ACCESSIBLE POINT ABOVE CEILING TO FRAME JAMB AT WIRE TRANSFER DEVICE LOCATION.
- REFER TO SPECIFICATION SECTION 08 43 13 ALUMINUM STOREFRONT, DOORS AND EXTERIOR FIXED UNITS.
- REFER TO SPECIFICATION SECTION 08 71 00 FINISH DOOR HARDWARE FOR ACCESS CONTROL HARDWARE TO BE PROVIDED AND INSTALLED.
- REFER TO SPECIFICATION SECTION 28 13 01 AND ELECTRICAL DRAWINGS FOR ACCESS CONTROL SYSTEM COMPONENTS, JUNCTION BOXES, AND CONDUIT AT DOUBLE DOORS, DOOR LEAF CLOSEST TO ACCESS CONTROL TO BE CONTROLLED BY ACCESS CONTROL SYSTEM.

Door Schedule

MARK	DETAILS			NOTES
	HEAD	JAMB	SILL	
A101VV	J14/A3.06 SIM	F10, F14/A3.06 SIM	F3/A3.07	
A101WW	D2/A3.08	L9/A3.08 (SIM.)	A1/A3.08	O.H. COILING DOOR
J161				
J168				
J169				
J171				
L121	F3/A3.07	F1/A3.07		
L122				
L124				
L126A	C12/A3.06	A12/A3.06		
L126B	C12/A3.06	A12/A3.06		

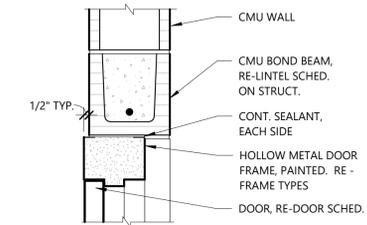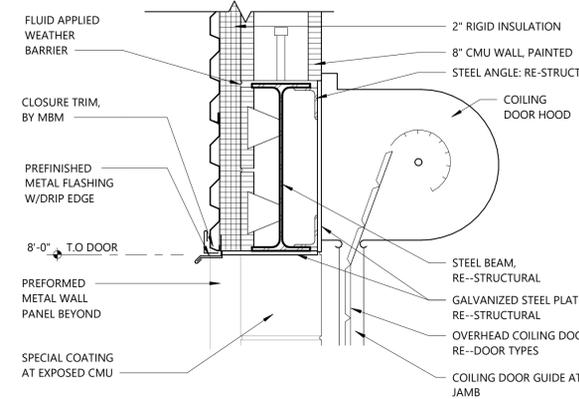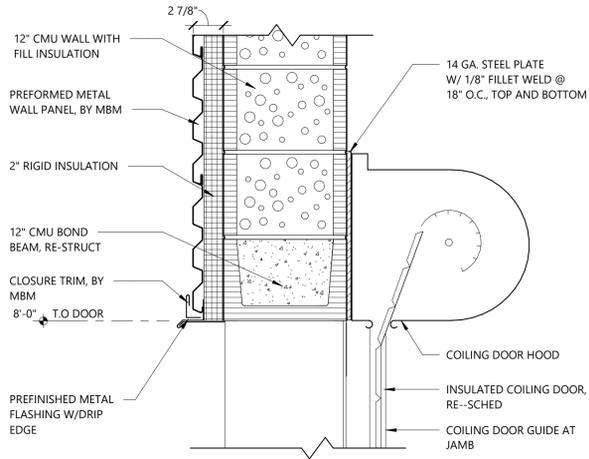


C1 Head Detail
1 1/2" = 1'-0"

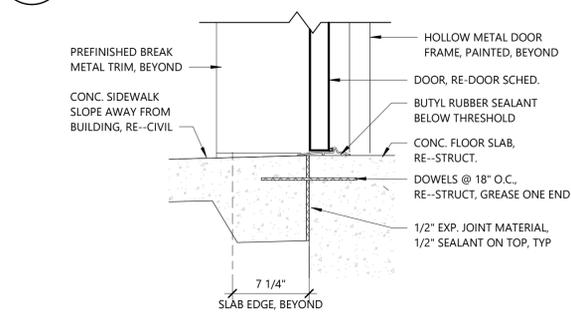


A1 Sill Detail
1 1/2" = 1'-0"

C4 Head Detail
1 1/2" = 1'-0"

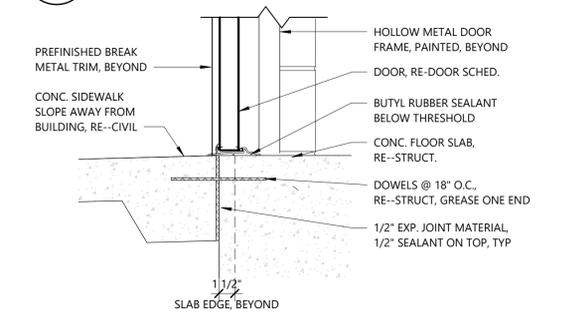

A4 Sill Detail
1 1/2" = 1'-0"

C8 A3.2 - Head Detail- HM Frame in CMU
1 1/2" = 1'-0"

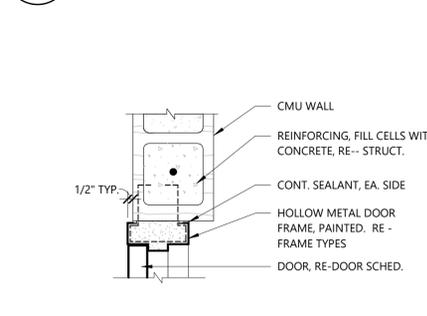

A8 A3.2 - Jamb Detail- HM Frame in CMU
1 1/2" = 1'-0"

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An Addition for BWHS
BWHS Band Addition
1351 GAMBLE RD CENTERTON, AR

DRAWN BY: MS
CHECK BY: Checker
ISSUE DATE: 02/02/2026

PROJECT NO: 2421

REVISION DATES

DOOR SCHEDULE / DOOR / WINDOW / FRAME ELEVATIONS / DETAILS SHEET

A3.0
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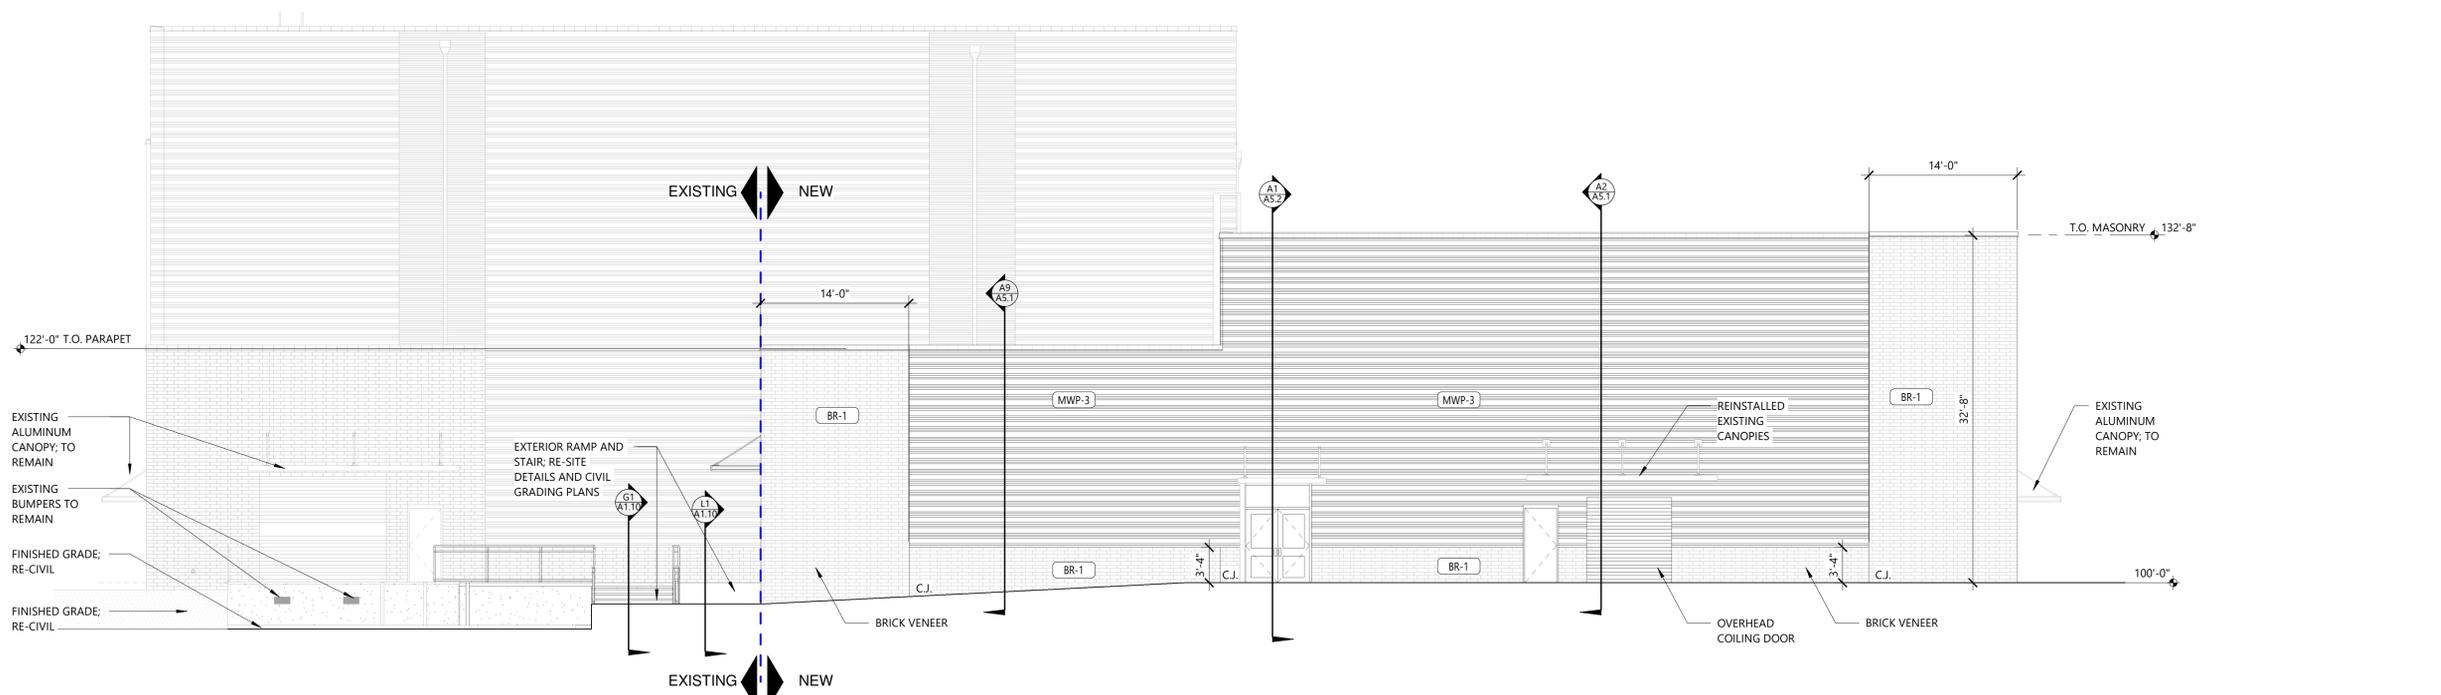
REVISION DATES

EXTERIOR ELEVATIONS

S H E E T


A4.1

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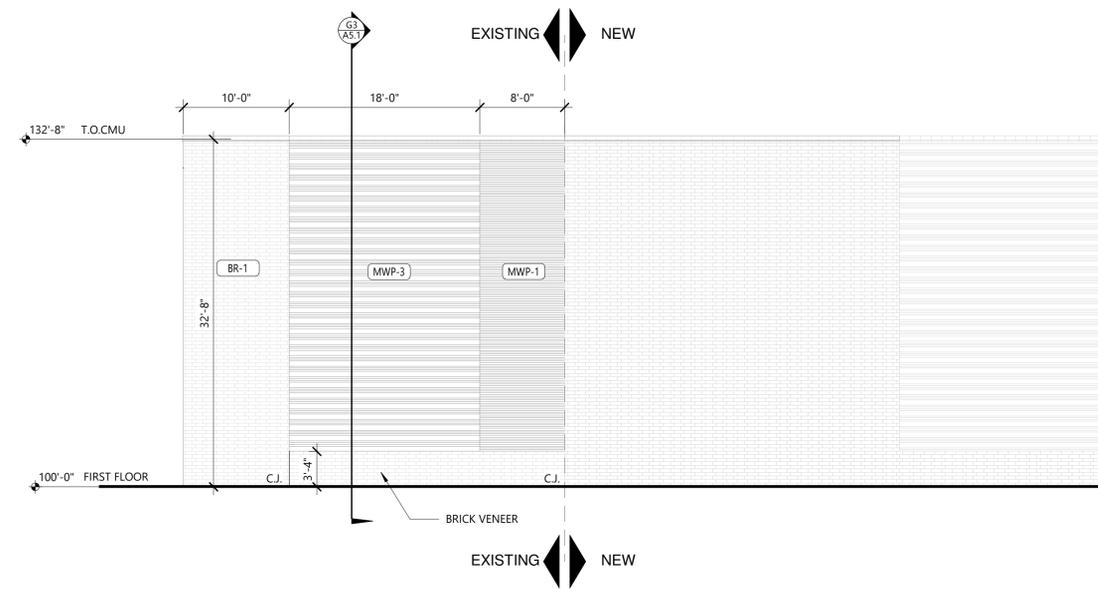


H2 South Elevation
1/8" = 1'-0"

EXTERIOR MATERIALS SCHEDULE/LEGEND		
	BR-1	"X COLOR" BRICK VENEER
	BR-EX	EXISTING BRICK VENEER
	MWP-1	METAL WALL PANELS
	MWP-3	METAL WALL PANELS

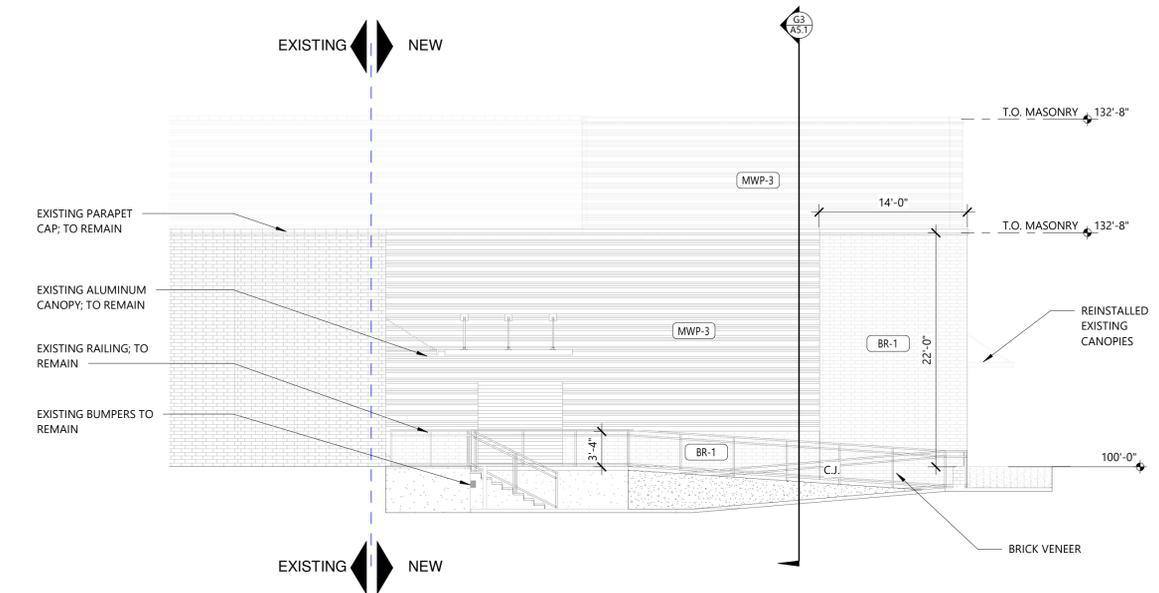

B2 West Elevation
1/8" = 1'-0"
Ref: A5/ A2.1



B10 East Elevation
1/8" = 1'-0"
Ref: A2/ A2.0

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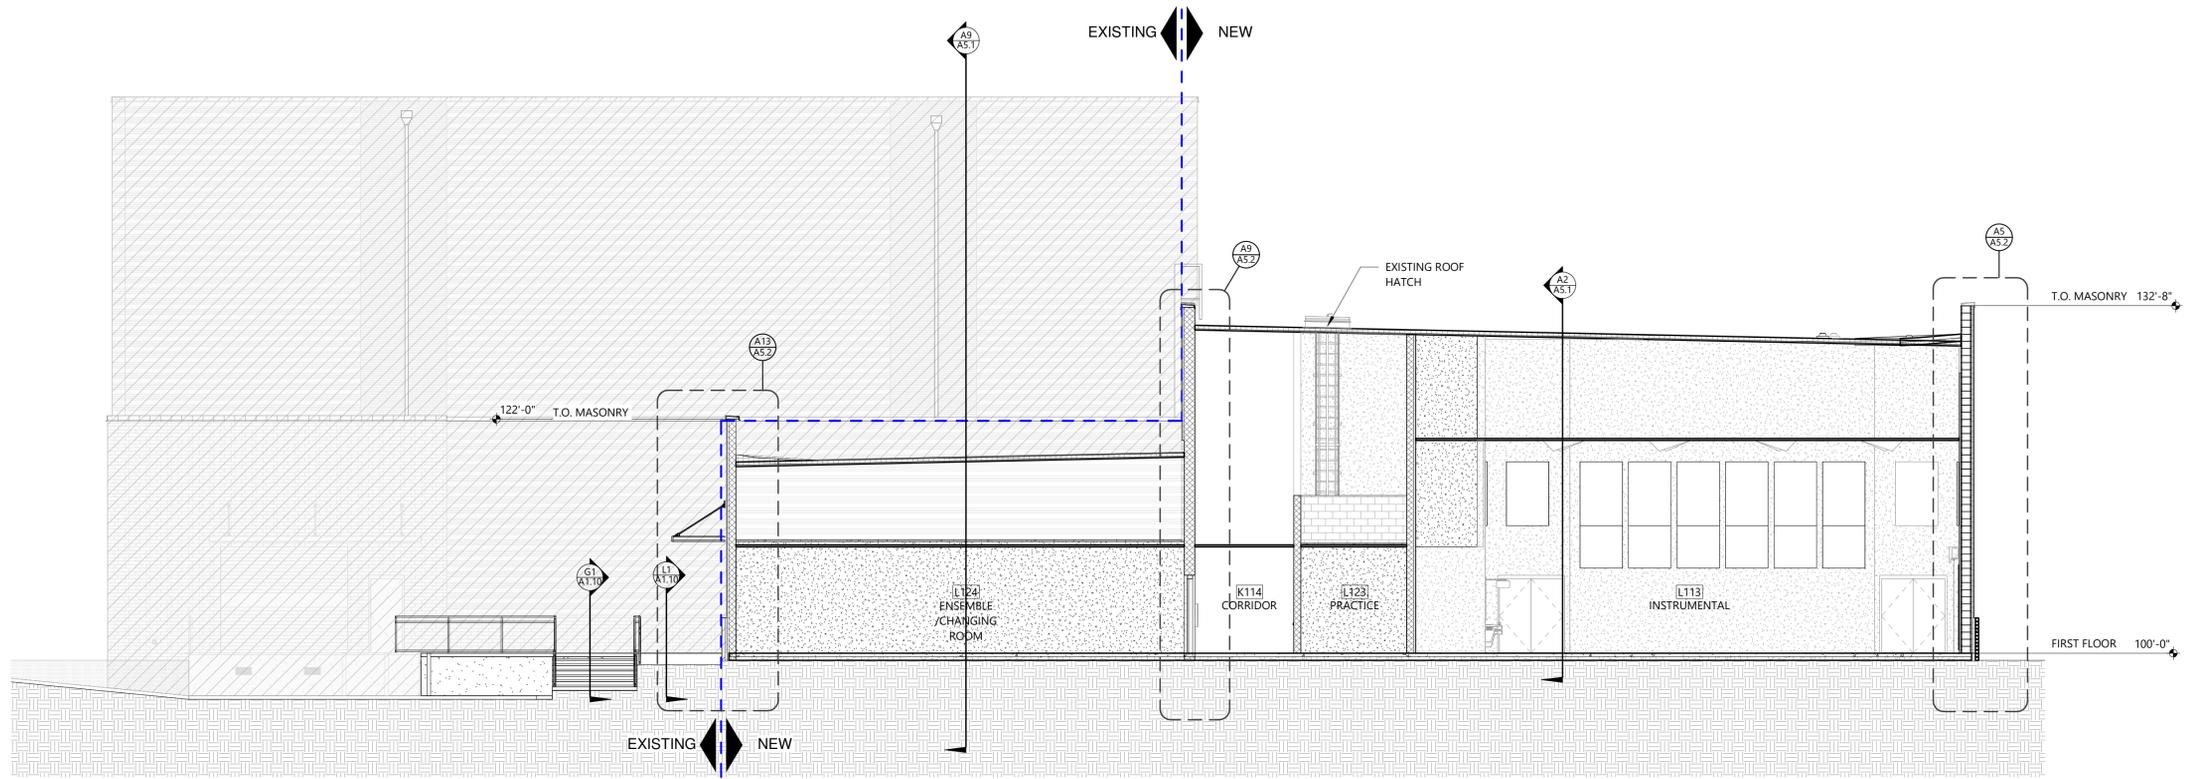
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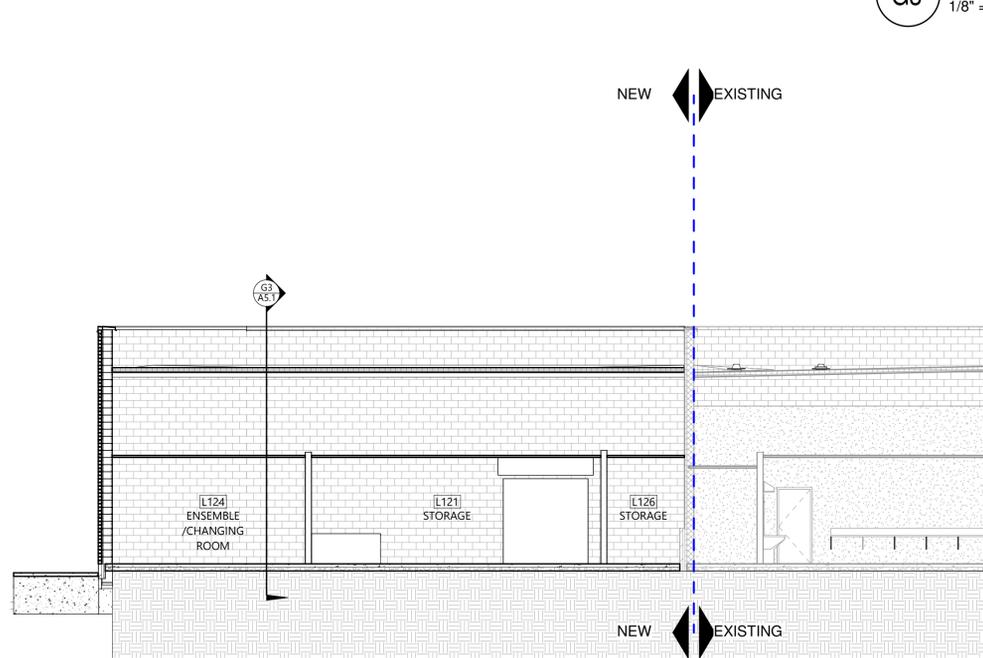
REVISION DATES

BUILDING SECTIONS
SHEET
A5.1


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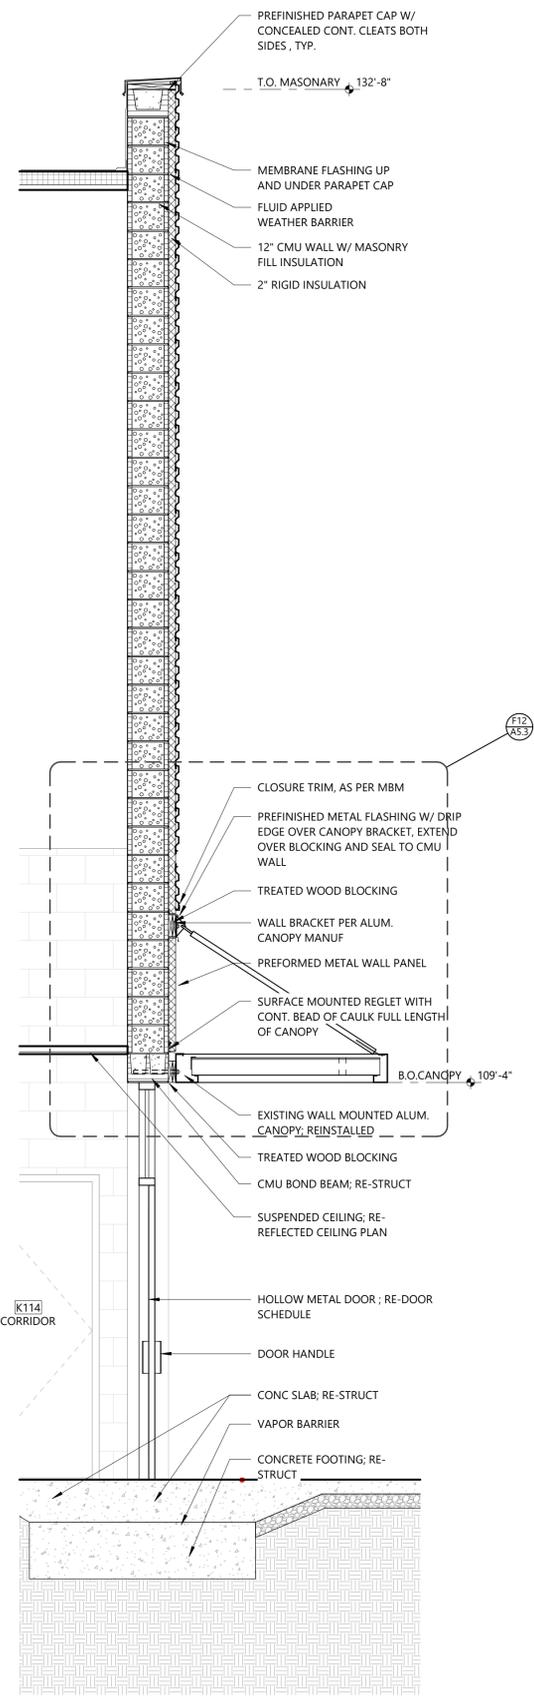
G3 Building Section
1/8" = 1'-0" Ref: A5/ A2.1




A9 Building Section
1/8" = 1'-0" Ref: A5/ A2.1




A2 Building Section
1/8" = 1'-0" Ref: A5/ A2.1

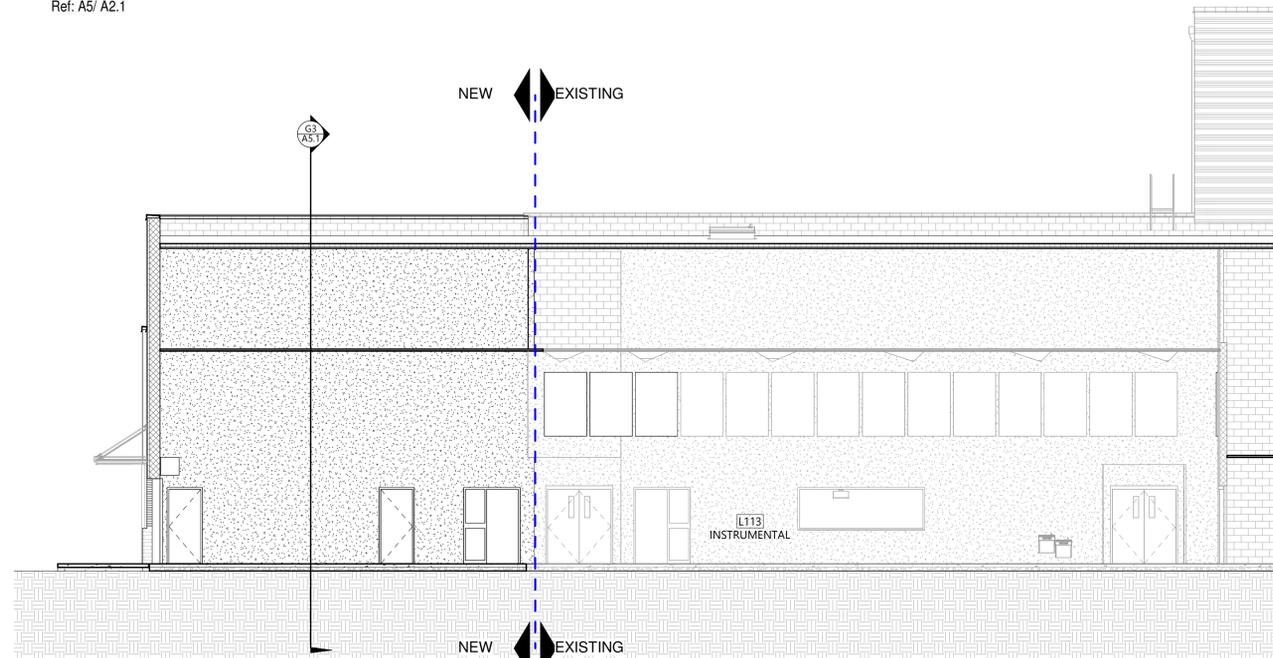


A1 Wall Section
1/2" = 1'-0"
Ref: A5/ A2.1

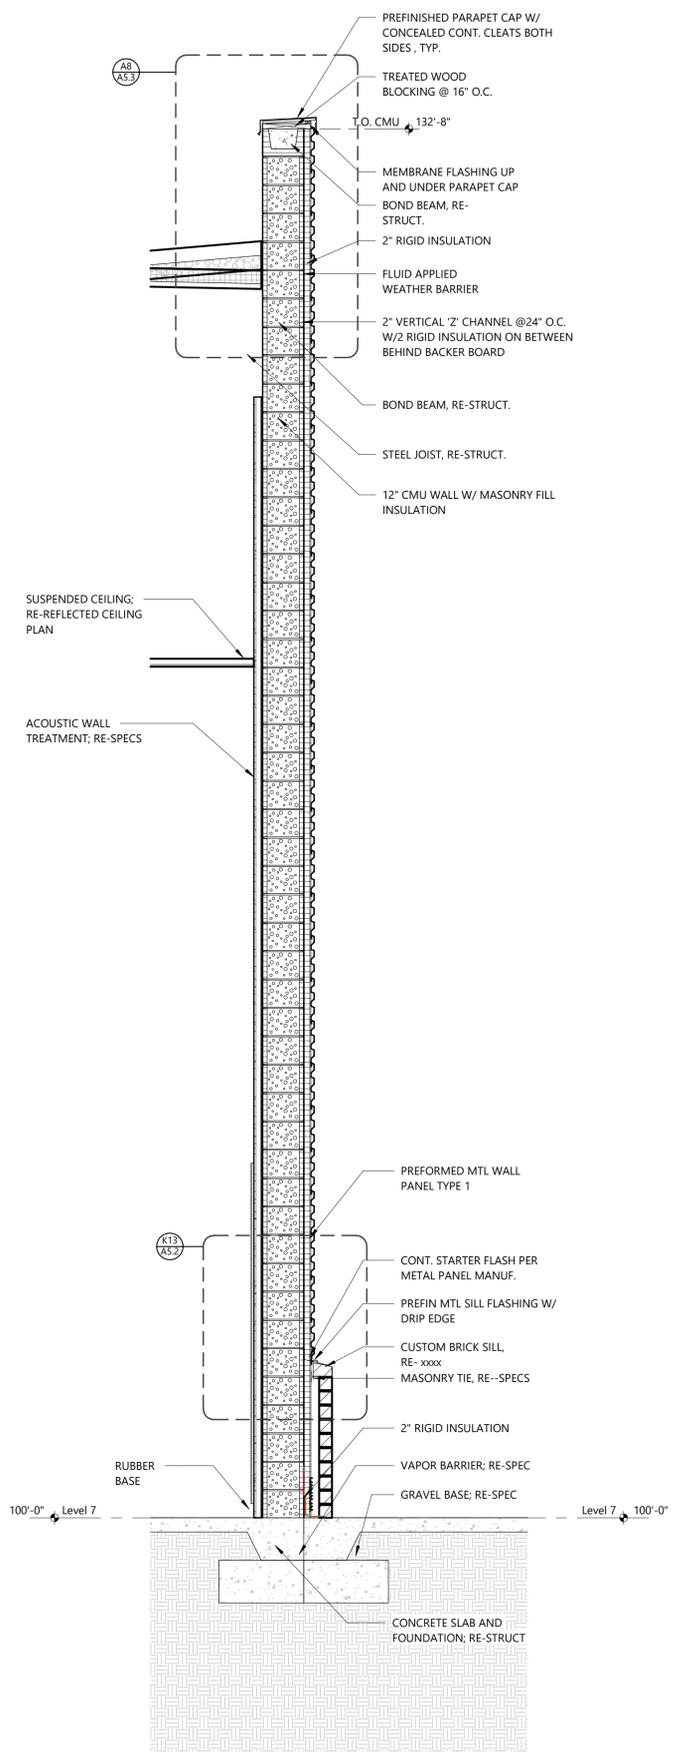

A5 Wall Section
1/2" = 1'-0"
Ref: G3/ A5.1

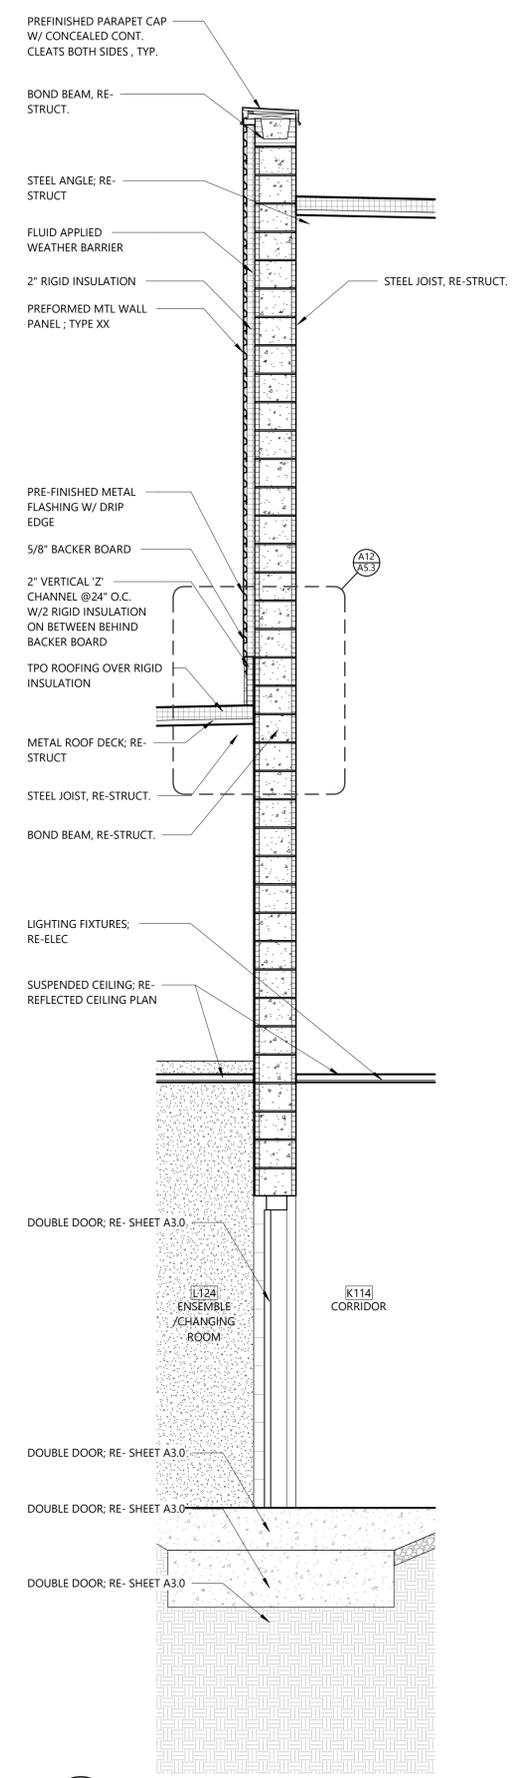

A9 Wall Section
1/2" = 1'-0"
Ref: G3/ A5.1

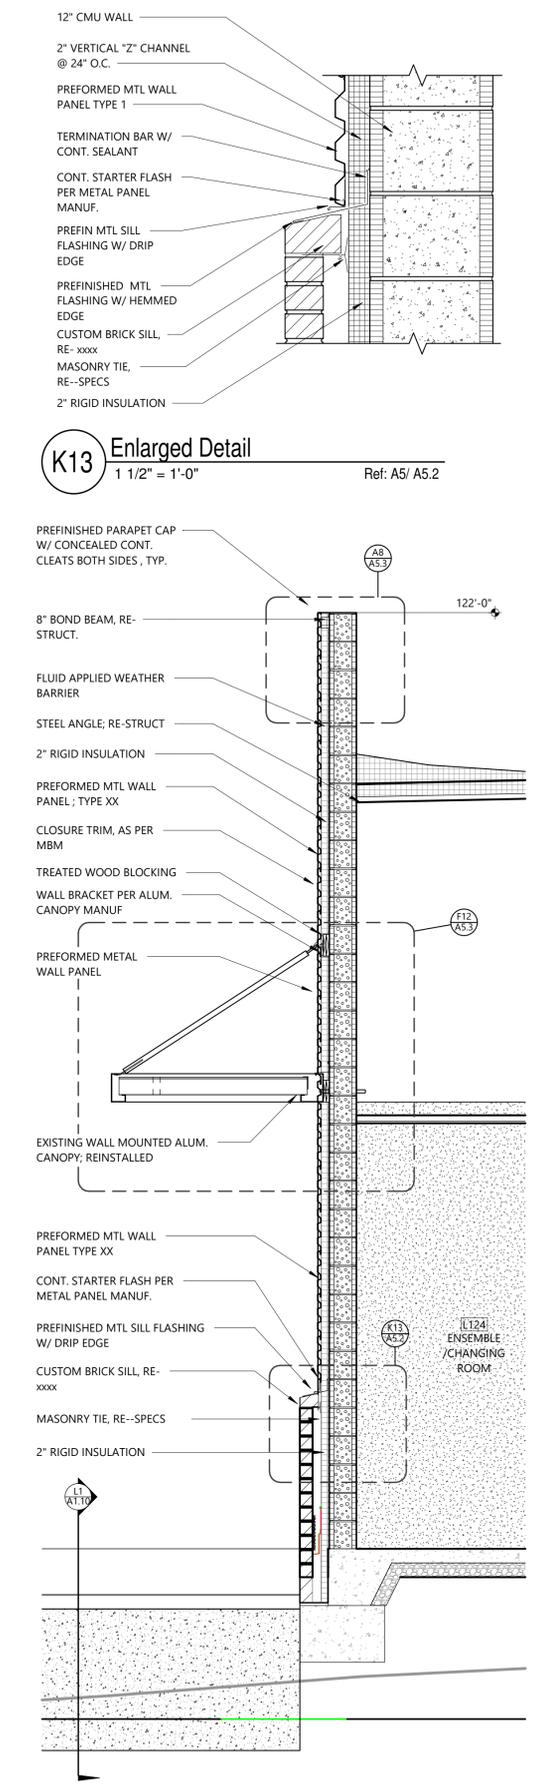

A13 Wall Section
1/2" = 1'-0"
Ref: G3/ A5.1

K13 Enlarged Detail
1 1/2" = 1'-0"
Ref: A5/ A5.2

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WALL SECTIONS
SHEET
A5.2
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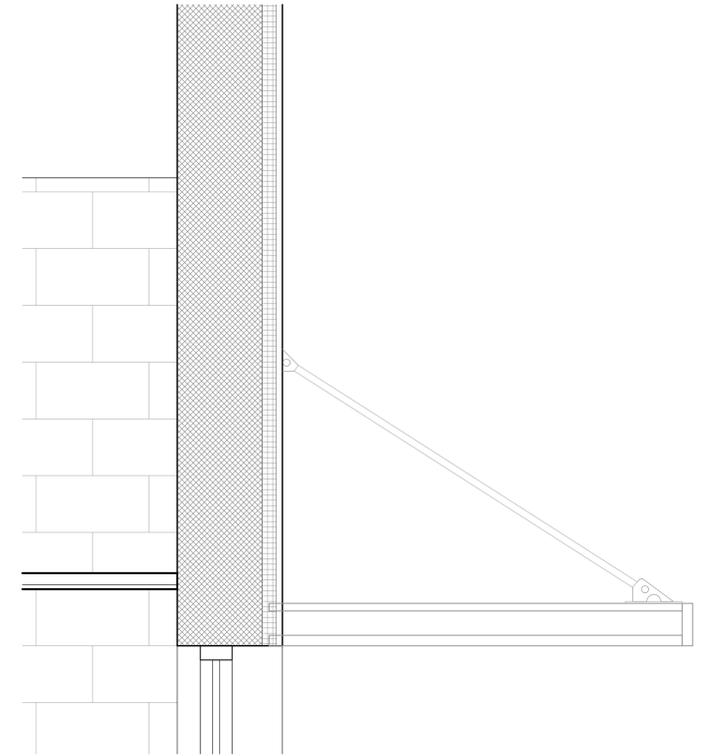
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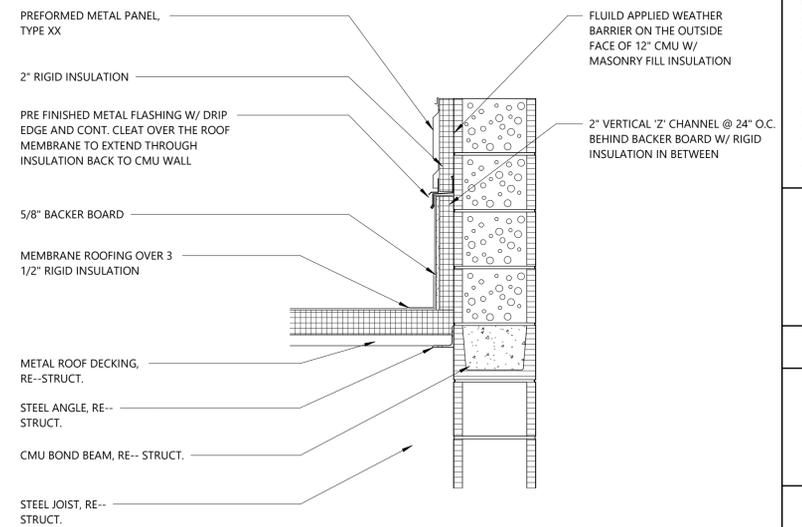
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WALL SECTIONS
S H E E T
A5.3


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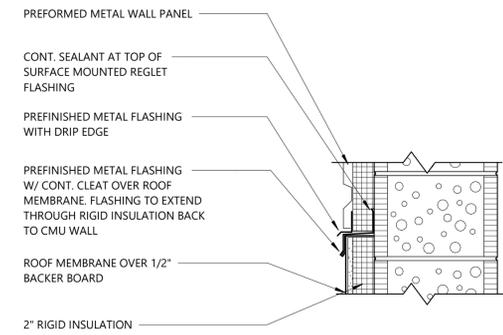
F12 Enlarged Detail
1" = 1'-0" Ref: A1/ A5.2



A12 Enlarged Detail
1" = 1'-0" Ref: A9/ A5.2



A8 Enlarged Detail
1" = 1'-0" Ref: A5/ A5.2

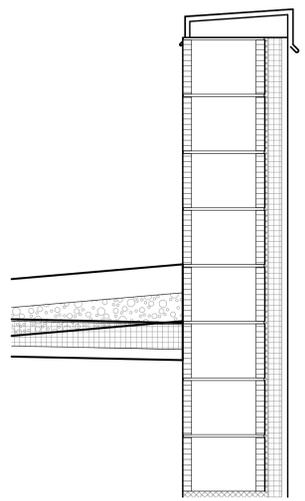

1 Enlarged Detail
1 1/2" = 1'-0"