

ARCHITECTURAL ABBREVIATIONS


AB	ANCHOR BOLT	KG	KILOGRAM
ACOUST.	ACOUSTICAL	LCB	LIQUID CHALK BOARD
AD	AUXILIARY DRAIN	LM	LINEAL METER
ADJ.	ADJUSTABLE	LG	LONG
ADMIN.	ADMINISTRATION	MAS	MASONRY
A.F.F.	ABOVE FINISH FLOOR	MATL.	MATERIAL
AGGRE.	AGGREGATE	MAX	MAXIMUM
ALUM.	ALUMINUM	MB	MINI-BLINDS
BD	BOARD	M.D.	METAL DECK
B.F.F.	BELOW FINISH FLOOR	MECH.	MECHANICAL
BLKG	BLOCKING	MEMB.	MEMBRANE
BM	BEAM	MEZZ.	MEZZANINE
B.O.	BOTTOM OF	MFR	MANUFACTURER
BPL	BASE PLATE	MISC.	MISCELLANEOUS
BS	BOTH SIDES	MO	MASONRY OPENING
BTWN.	BETWEEN	M.S.	METAL STUD
B.U.R.	BUILT-UP ROOF	MTL.	METAL
CAL.	CALIPER	N.I.C.	NOT IN CONTRACT
CL	CENTERLINE	NS	NON-SHRINK
CFC	COMBINED FACILITIES COMPLEX	N.T.S.	NOT TO SCALE
CSF	COMBINED SHARED FACILITIES	OC	ON CENTER
CG	CORNER GUARD	OD	OUTSIDE DIAMETER
CJ	CONTROL JOINT	OFW	OUTSIDE FACE OF WALL
CLG	CEILING	OPNG	OPENING
CMU	CONCRETE MASONRY UNIT	OPP.	OPPOSITE
COL.	COLUMN	P.LAM	PLASTIC LAMINATE
CONC.	CONCRETE	PL	PLATE
CONC. BLK	CONCRETE BLOCK	PLYWD.	PLYWOOD
CONST.	CONSTRUCTION	PNL	PANEL
CONT.	CONTINUOUS	PROD	PRODUCE
CT	CERAMIC TILE	KG/SQM	KILOGRAMS PER SQUARE METER
DB	DECK BEARING	KG/SQCM	KILOGRAMS PER SQUARE CENTIMETER
DIM.	DIMENSION	QTY	QUANTITY
DR	DOOR	R	RISER
DTL	DETAIL	R	RADIUS
DWG	DRAWING	RD	ROOF DRAIN
EA	EACH	REFRIG	REFRIGERATION
E.B.	EXPANSION BOLT	REINF	REINFORCING
EF	EXHAUST FAN	REQD	REQUIRED
E.I.F.S.	EXTERIOR INSULATION AND FINISH SYSTEM	RM	ROOM
EJ	EXPANSION JOINT	RPP	RACK POST PROTECTOR
ELEC.	ELECTRICAL	SC	SOLID CORE
ELEV.	ELEVATION	SCHED.	SCHEDULE
EQ	EQUAL	SECT.	SECTION
EQUIP.	EQUIPMENT	SHT.	SHEET
EW	EACH WAY	SIM.	SIMILAR
EWC	ELECTRIC WATER COOLER	SPECS	SPECIFICATIONS
EXIST.	EXISTING	SMFE	SURFACE MOUNTED FEC
EXP	EXPANSION	SRFE	SEMI-RECESSED FEC
EXT.	EXTERIOR	S	SEWER
F	FEMALE	SS	SANITARY SEWER
FD	FLOOR DRAIN	S.S.	STAINLESS STEEL
FE	FIRE EXTINGUISHER	SSC	STAINLESS STEEL CLOSURE
FEC	FIRE EXTINGUISHER CABINET	SST	STAINLESS STEEL THRESHOLD
F.F.E.	FINISH FLOOR ELEVATION	STB	STAFF TRAINING BUILDING
FIN.	FINISH	STL	STEEL
FLR	FLOOR	STO.	STORAGE
FND	FOUNDATION	STRUCT.	STRUCTURAL
F.O.C.	FACE OF CONCRETE	SYM.	SYMBOL
FRP	FIBERGLASS REINFORCED PANEL	T	TREAD
FTG	FOOTING	T & B	TOP AND BOTTOM
GA	GAGE	THK	THICK
GALV	GALVANIZED	THRESH.	THRESHOLD
GR	GUARD RAIL	TJ	TOOLED JOINT
GP	GUARD POST	TO	TOP OF
GYP	GYPSUM	T.O.S.	TOP OF STEEL
GYP.BD.	GYPSUM BOARD	T.O.P.	TOP OF PANEL
H	HIGH	TS	TUBE STEEL
HD	HANDICAP	TW	TRANSACTION WINDOW
HC	HOLLOW CORE	TYP	TYPICAL
HDW	HARDWARE	T.O.M.	TOP OF MASONRY
HM	HOLLOW METAL	U.N.O.	UNLESS NOTED OTHERWISE
HORIZ.	HORIZONTAL	VCT	VINYL COMPOSITION TILE
HP	HORSEPOWER	VERT.	VERTICAL
HT	HEIGHT	VEST.	VESTIBULE
INFO.	INFORMATION	V.I.F.	VERIFY IN FIELD
INSUL.	INSULATION	W	WIDE
INT	INTERIOR	W/	WITH
JAN	JANITOR.	WC	WATER CLOSET
JT	JOINT	WD	WOOD
JST	JOIST	WDW	WINDOW
KCJ	KEYED CONTROL JOINT	WG	WALL GUARD
LAV.	LAVATORY	W/O	WITHOUT
		WP	WATERPROOFING
		WT	WEIGHT
		WWF	WELDED WIRE FABRIC

INDEX OF DRAWINGS


SHEET NUMBER	SHEET NAME	Sheet Issue Date	REVISION DATE
GENERAL INFORMATION			
G-001	TITLE SHEET	07-17-2024	
G-002	INDEX, SYMBOLS & ABBREV.	07-17-2024	
G-003	GENERAL NOTES & DETAILS	07-17-2024	
LIFE SAFETY			
GI001	LIFE SAFETY CODE ANALYSIS	07-17-2024	
GI101	LIFE SAFETY FLOOR PLAN	07-17-2024	
CIVIL			
VF101	SITE SURVEY	06-20-2024	
C-001	CIVIL NOTES	06-20-2024	
CD101	SITE DEMOLITION PLAN	06-20-2024	
CS101	SITE LAYOUT PLAN	06-20-2024	
CG101	SITE GRADING AND DRAINAGE PLAN	06-20-2024	
CU101	SITE UTILITY PLAN	06-20-2024	
C-501	SITE DETAILS	06-20-2024	
C-502	SITE DETAILS	06-20-2024	
C-503	SITE DETAILS	06-20-2024	
STRUCTURAL			
S-001	STRUCTURAL DESIGN CRITERIA AND GENERAL NOTES	07-17-2024	
S-002	STRUCTURAL GENERAL NOTES CONT'D	07-17-2024	
S-003	COMPONENTS AND CLADDING WIND PRESSURE PLANS	07-17-2024	
S-101	FOUNDATION AND SLAB PLAN	07-17-2024	
S-102	ROOF FRAMING PLAN	07-17-2024	
S-301	TYP FOUNDATION AND SLAB DETAILS	07-17-2024	
S-302	FOUNDATION DETAILS	07-17-2024	
S-303	FOUNDATION DETAILS	07-17-2024	
S-501	TYPICAL ROOF FRAMING DETAILS	07-17-2024	
S-502	TYPICAL ROOF FRAMING DETAILS	07-17-2024	
S-503	TYPICAL CANOPY FRAMING DETAILS	07-17-2024	
S-601	TYPICAL HARDENED ROOM DETAILS	07-17-2024	
ARCHITECTURAL			
A-101	FLOOR PLAN	07-17-2024	
A-102	CANOPY	07-17-2024	
A-201	EXTERIOR ELEVATIONS	07-17-2024	
A-301	SECTIONS	07-17-2024	
A-401	LARGE SCALE PLANS & DETAILS	07-17-2024	
A-402	DETAILS	07-17-2024	
A-403	DETAILS	07-17-2024	
A-404	WINDOW DETAILS	07-17-2024	
A-601	SCHEDULES & DEMOLITION PLAN	07-17-2024	
A-602	ROOM FINISH NOTES AND LEGENDS	07-17-2024	
A-701	MILLWORK DETAILS	07-17-2024	
A-801	PARTITION TYPES AND WALL SECTIONS	07-17-2024	
PLUMBING			
P-001	PLUMBING LEGEND AND NOTES	07-17-2024	
P-101	OVERALL PLUMBING PLAN	07-17-2024	
P-501	PLUMBING DETAILS	07-17-2024	
P-502	PLUMBING DETAILS & RISER	07-17-2024	
P-601	PLUMBING SCHEDULES	07-17-2024	
MECHANICAL			
M-001	MECHANICAL LEGEND, SYMBOLS, GENERAL NOTES, AND SCHEDULES	07-17-2024	
M-101	FIRST FLOOR MECHANICAL PLAN	07-17-2024	
M-501	MECHANICAL DETAILS	07-17-2024	
ELECTRICAL			
E-001	ELECTRICAL LEGEND	07-17-2024	
ES101	ELECTRICAL SITE PLAN	07-17-2024	
EG101	LIGHTNING PROTECTION PLAN	07-17-2024	
EL101	LIGHTING PLAN	07-17-2024	
EP101	POWER PLAN & SINGLE LINE DIAGRAM	07-17-2024	
ET101	SYSTEMS PLAN	07-17-2024	
E-601	ELECTRICAL SCHEDULES	07-17-2024	

SYMBOLS LEGEND

ROOM LABEL

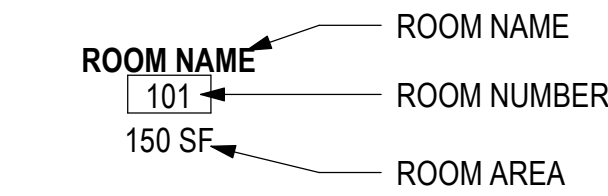


DOOR LABEL

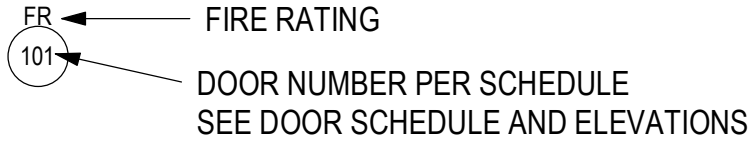


WINDOW LABEL




REVISION IDENTIFICATION

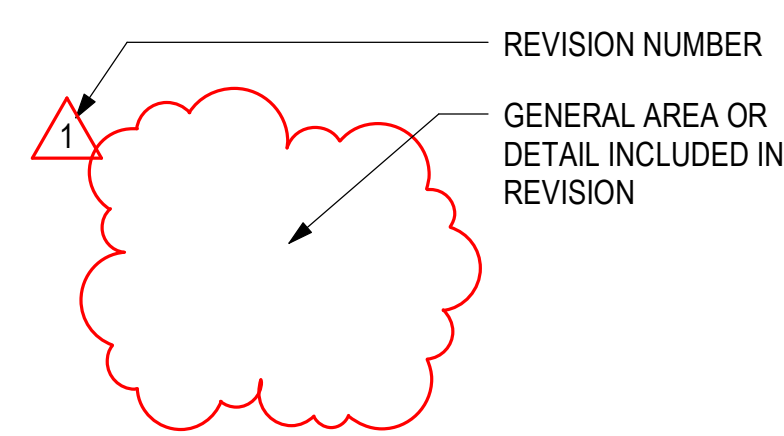


ELEVATION SYMBOL

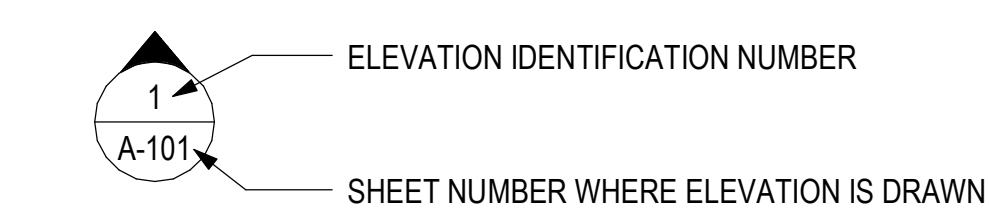


SECTION SYMBOL

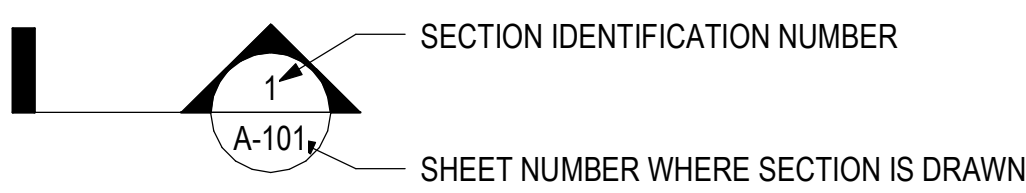


DETAIL SYMBOL

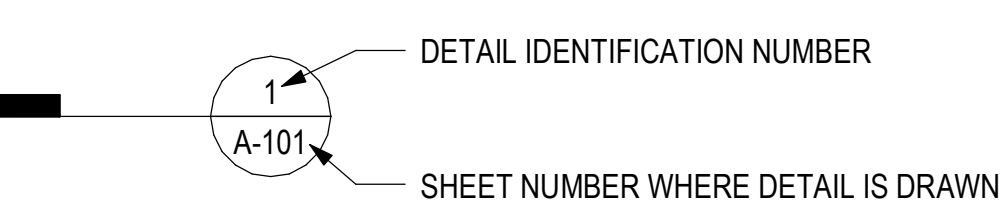

KEY NOTE

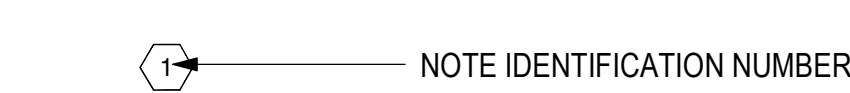

PARTITION TAG

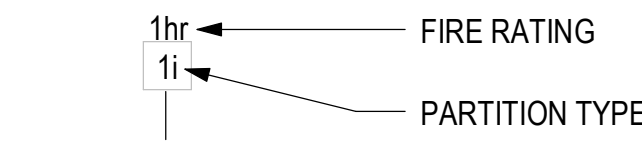

SECTION INDICATIONS

	EARTH		WOOD, FINISH CARPENTRY
	CONCRETE		WOOD, BLOCKING
	GRAVEL		PLYWOOD
	BRICK		METAL
	CONCRETE MASONRY UNIT (CMU)		GLASS
	CERAMIC TILE		GYP SUM BOARD (GWB)
	ACOUSTICAL TILE		BATT INSULATION
	WOOD, ROUGH CARPENTRY		RIGID INSULATION
	COOLER/FREEZER WALL PANEL		

Project

AEROJET
New Guard
Post - 2


Design Phase

CONSTRUCTION
DOCUMENTS

Revisions

No.	Date	Description

Stamp

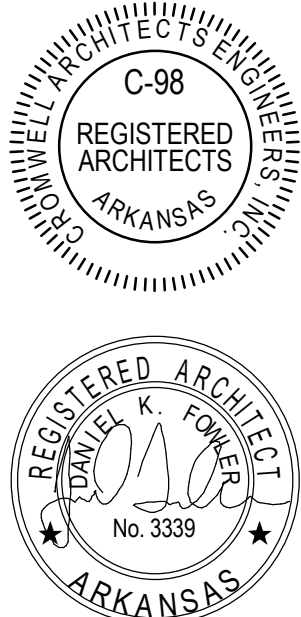

07-17-2024

Notes

1. CROMWELL ARCHITECTS ENGINEERS, INC. ALL RIGHTS RESERVED
2. THIS SHEET DESIGNED FOR COLOR PRINTING. CRITICAL INFORMATION MAY BE LOST WITH BLACK AND WHITE PRINTING.

Project Number

2024-052

Issue Date

07-17-2024

Sheet Title

INDEX, SYMBOLS &
ABBREV.

Sheet Number

G-002

NOTES

GENERAL CONSTRUCTION REQUIREMENTS:

1. ALL WORK SHALL BE DONE IN A SAFE AND WORKMANLIKE MANNER AND IN STRICT ACCORDANCE WITH THE UFC, GOVERNING BUILDING CODES, NATIONAL ELECTRIC CODE, AND ALL APPLICABLE REGULATIONS AND ORDINANCES HAVING JURISDICTION.
2. THE CONTRACTOR IS TO UNDERSTAND ALL DRAWINGS AND SPECIFICATIONS COMPLETELY. EACH ASPECT OF THE WORK MAY BE INDICATED IN ONE DISCIPLINE OR INDICATED IN MULTIPLE DISCIPLINES. REVIEW ALL INFORMATION FROM ALL DISCIPLINES AND COMPLETELY FIELD VERIFY ALL CONDITIONS BEFORE IMPACTING EXISTING CONDITIONS OR PROVIDING NEW WORK.
3. EACH SUBCONTRACTOR IS RESPONSIBLE FOR HAVING A THOROUGH KNOWLEDGE OF ALL DRAWINGS AND SPECIFICATIONS IN THEIR RELATED FIELD. THE FAILURE TO DO SO DOES NOT RELIEVE ANY RESPONSIBILITY FOR PERFORMING THIS WORK PROPERLY. NO ADDITIONAL COMPENSATION SHALL BE ALLOWED BECAUSE OF CONDITIONS THAT OCCUR DUE TO FAILURE TO FAMILIARIZE WORKERS WITH THIS KNOWLEDGE.
4. PRIOR TO COMMENCING WITH THE WORK, THE CONTRACTOR SHALL VERIFY ALL DIMENSIONS IN THE FIELD PRIOR TO FABRICATION OF ALL ITEMS, AND IF ANY DISCREPANCIES ARE FOUND BETWEEN WHAT IS SHOWN ON THE PLANS AND WHAT EXISTS IN THE FIELD, CONTACT THE ARCHITECT TO DETERMINE THE PROPER COURSE OF ACTION. THE CONTRACTOR'S APPROVAL FOR FABRICATION INDICATES THE ACCEPTANCE OF EXISTING CONDITIONS.
5. THE OWNER SHALL OCCUPY PORTIONS OF THE FACILITY DURING CONSTRUCTION. THE CONTRACTOR SHALL COORDINATE WITH THE OWNER ALL CONSTRUCTION PROCEDURES WHICH WILL INTERFERE WITH THE NORMAL DAILY OPERATIONS OF THE FACILITY. THE CONTRACTOR SHALL OBTAIN PERMISSION FROM THE OWNER FOR ALL INTERRUPTIONS OF UTILITY SERVICES PRIOR TO THE INTERRUPTION. ACCIDENTAL INTERRUPTIONS SHALL BE REMEDIED IMMEDIATELY WITH APPROPRIATE FORCES.
6. THE FACILITY SHALL BE PROTECTED AT ALL TIMES FROM MOISTURE, DUST AND DEBRIS. INSTALL DUST PARTITIONS AS REQUIRED AND/OR AS SHOWN TO KEEP THE EXISTING PREMISES FREE FROM DUST AND DEBRIS. PROVIDE BARRICADES SEPARATING THE PUBLIC FROM CONSTRUCTION ACTIVITY.
7. ANY DAMAGE TO THE OWNER'S PROPERTY OR OWNER'S EMPLOYEES CAUSED BY THE CONSTRUCTION PROCESS SHALL BE REPAIRED/REPLACED AT NO COST TO THE OWNER OR OWNER'S EMPLOYEES.
8. THE CONTRACTOR SHALL MAINTAIN THE INTEGRITY OF THE SECURITY SYSTEM OF THE EXISTING FACILITY AT ALL TIMES. THIS INCLUDES KEEPING THE FACILITY SECURE FROM PERSONS, ENVIRONMENTAL ELEMENTS, OR HAZARDS. THE CONTRACTOR SHALL OBTAIN PERMISSION FROM THE OWNER PRIOR TO THE MODIFICATION OF ANY SECURITY SYSTEM OR THE DISABLING OF SUCH.
9. THE CONTRACTOR SHALL KEEP THE CONSTRUCTION AREA FREE AND CLEAR OF DEBRIS. REMOVE TRASH AND DEBRIS FROM CONSTRUCTION AREA AND DO NOT ALLOW TO ACCUMULATE. NO FLAMMABLE MATERIALS/LIQUIDS MAY BE STORED IN THE BUILDING DURING CONSTRUCTION. PROVIDE EXTINGUISHERS AS REQUIRED BY LOCAL AND STATE AUTHORITIES, UL LISTED 2A:20BC DRY CHEMICAL FIRE EXTINGUISHERS, ACCESSIBLE AT ALL TIMES WITHIN ALL CONSTRUCTION AREAS.
10. THE CONTRACTOR SHALL MAINTAIN THE REQUIRED NUMBER OF EXITS FROM THE FACILITY. MAINTAIN EXITS, EXIT SIGNS AND EMERGENCY LIGHTING AT ALL TIMES AS REQUIRED BY THE GOVERNING AUTHORITIES.
11. REMOVE ANY EXISTING ITEMS, SERVICES, FINISHES/OR SURFACES AS REQUIRED FOR THE INSTALLATION OF NEW CONSTRUCTION.
12. REPAIR, RE-ROUTE AND EXTEND ALL SERVICES, PIPING, CONDUIT OF EXISTING ITEMS AND EQUIPMENT AS REQUIRED DURING THE CONSTRUCTION PROCESS FOR THE COMPLETE INSTALLATION AND OPERATIONS OF NEW EQUIPMENT. THIS INCLUDES ALL ITEMS SHOWN OR NOT SHOWN ON THE DRAWINGS. RESET EXISTING EQUIPMENT OR RELATED ITEMS AS REQUIRED FOR PROPER OPERATION.
13. ALL QUESTIONS RELATING TO THE CONSTRUCTION OF THIS PROJECT SHALL BE DONE IN WRITTEN FORM USING THE "REQUEST FOR INFORMATION" FORM, INCLUDED IN THE SPECIFICATIONS, THROUGH THE GENERAL CONTRACTOR ONLY. FOLLOW INSTRUCTIONS WHEN COMPLETING AND SENDING THIS FORM.

GENERAL SITE VERIFICATION REQUIREMENTS:

15. EXISTING CONDITIONS SHOWN IN THESE PLANS ARE BASED ON LIMITED FIELD OBSERVATIONS BY THE ARCHITECT. ALL EXISTING, DIMENSIONS, AND GENERAL CONDITIONS SHALL BE VERIFIED BEFORE PURCHASE OF MATERIAL AND CONSTRUCTION. NOTIFY THE ARCHITECT OF ANY DISCREPANCIES BETWEEN PLANS AND FIELD CONDITIONS IMMEDIATELY.
16. ALL UTILITY LOCATIONS SHOWN ARE APPROXIMATE. THE CONTRACTOR SHALL FIELD VERIFY THE EXACT LOCATION OF ALL EXISTING UTILITIES (WHETHER SHOWN OR NOT) PRIOR TO THE SUBMISSION OF HIS BID OR THE COMMENCEMENT OF CONSTRUCTION. THE CONTRACTOR SHALL NOTIFY THE ARCHITECT OF THE DISCOVERY OF EXISTING UTILITIES NOT SHOWN OR NOTED ON DRAWINGS. THE CONTRACTOR SHALL VERIFY EXACT LOCATIONS AND DEPTHS OF UNDERGROUND UTILITY SERVICES PRIOR TO ANY EXCAVATION.

GENERAL DEMOLITION REQUIREMENTS:

- REFER TO EXISTING GUARD POST - DEMOLITION NOTES ON A601
17. ALL DEMOLITION SHALL BE CARRIED OUT IN A SAFE MANNER AND IN STRICT ACCORDANCE WITH OSHA REGULATIONS.
18. THE CONTRACTOR SHALL FIELD VERIFY THE EXTENT OF DEMOLITION. THE WORK INCLUDES, BUT IS NOT LIMITED TO, THE DEMOLITION AND REMOVAL OF WALLS, CEILINGS, ROOFING, DOORS, FIXTURES, PLUMBING, MECHANICAL AND ELECTRICAL ITEMS INCLUDING CONDUITS AND DUCTWORK AS SHOWN ON DRAWING OR AS REQUIRED FOR THE INSTALLATION OF THE NEW WORK FOR A COMPLETE JOB. CONTRACTOR SHALL REPAIR SITE, REFER TO CIVIL DRAWINGS.
19. WHEN UTILITIES ARE REMOVED, CAP AND SEAL A MINIMUM OF 8" BELOW FINISH FLOOR.
20. THE CONTRACTOR SHALL RETAIN A REGISTERED PROFESSIONAL ENGINEER TO SPECIFY DEMOLITION PROCEDURES. IT IS THE CONTRACTOR'S RESPONSIBILITY FOR MEANS AND METHODS OF DEMOLITION AND NEW CONSTRUCTION.
21. DURING DEMOLITION AND CONSTRUCTION, THE CONTRACTOR SHALL COORDINATE WITH THE OWNER ANY REQUIRED SAFETY BARRIERS OR BARRICADES. PROVIDE BARRICADES SO AS TO PRECLUDE INTRUSION OF PUBLIC INTO CONSTRUCTION AREAS.
22. REFER TO THE OWNER APPROVED CONSTRUCTION PHASING SCHEDULE FOR PHASING OF DEMOLITION AND NEW CONSTRUCTION. COORDINATE DEMOLITION WITH NEW CONSTRUCTION IN ORDER THAT THE FACILITY WILL HAVE UNINTERRUPTED WATER, SEWER, ELECTRICAL, GAS AND FIRE PROTECTION SERVICE. THE CONTRACTOR IS RESPONSIBLE FOR MAKING ALL NECESSARY TEMPORARY UTILITY PROVISIONS REQUIRED.
23. ALL DEMOLITION MATERIALS NOT SALVAGED BY THE OWNER SHALL BE REMOVED BY THE CONTRACTOR. COORDINATE WITH THE OWNER REGARDING MATERIALS TO BE SALVAGED BY THE OWNER. REFER ALSO TO DRAWINGS AND SPECIFICATIONS FOR SALVAGED ITEMS.
24. THE CONTRACTOR SHALL USE A WET SAW FOR SLAB SAWING. NO JACK HAMMERS WILL BE ALLOWED WITHOUT PRIOR APPROVAL FROM THE OWNER.
25. PROTECT ALL WATER PIPING AT AREAS OF DEMOLITION AND EXPANSION, WHERE EXISTING PIPING IS SUBJECT TO FREEZING. PROTECT PIPING SO AS NOT TO FREEZE.

GENERAL FLOOR PLAN NOTES:

26. ALL DIMENSIONS ARE TO FACE OF CMU OR STUD UNLESS NOTED OTHERWISE.
27. ALL NEW FLOORING SHALL BE PROTECTED FROM SCRATCHING, MARKING, STAINING, ETC. DURING CONSTRUCTION. ANY FLOORING THAT IS DAMAGED BY CONSTRUCTION AND DOES NOT APPEAR IN NEW CONDITION AT THE TIME OF POSSESSION WILL BE REPLACED BY THE GENERAL CONTRACTOR AT HIS EXPENSE. INSTALL TRANSITION STRIP WHERE FLOORING ABUTS EXPOSED CONCRETE FLOOR.
28. CLEAN ALL EXISTING HVAC GRILLES WHICH REMAIN, PRIOR TO CONTRACT COMPLETION.

Project

AEROJET
New Guard
Post - 2

Design Phase

CONSTRUCTION
DOCUMENTS

Revisions

No.	Date	Description

Stamp

CROMWELL ARCHITECTS ENGINEERS, INC.
C-98
REGISTERED ARCHITECTS
ARKANSAS

REGISTERED ARCHITECT
DANIEL K. FOWLER
No. 3339
ARKANSAS

07-17-2024

Notes

1. CROMWELL ARCHITECTS ENGINEERS, INC.
ALL RIGHTS RESERVED

2. THIS SHEET DESIGNED FOR COLOR PRINTING.
CRITICAL INFORMATION MAY BE LOST WITH
BLACK AND WHITE PRINTING.

Project Number

2024-052

Issue Date

07-17-2024

Sheet Title

GENERAL NOTES &
DETAILS

Sheet Number

G-003

AEROJET

New Guard

Post - 2


LIFE SAFETY - PATH OF TRAVEL			
TRAVEL PATH		EXIT TRAVEL TYPE	LENGTH
FROM ROOM	TO ROOM		
RESTROOM / HARDENED ROOM 101	GUARD OFFICE 100	COMMON PATH	16' - 5"
			16' - 5"

LIFE SAFETY SCHEDULE				
NAME	NUMBER	SPACE AREA	AREA PER PERSON	OCCUPANT LOAD
GUARD OFFICE	100	137 SF	150 SF	1
RESTROOM / HARDENED ROOM	101	57 SF	150 SF	0
VISITOR BADGE-UP	102	84 SF	150 SF	1
UTILITY ROOM	103	54 SF	300 SF	0
		333 SF		2

CONSTRUCTION DOCUMENTS

[illegible]

Stamp _____

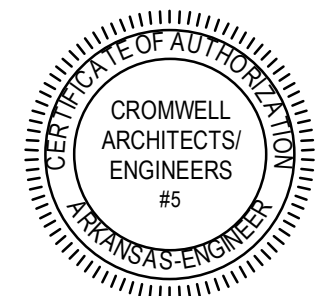

07-17-2024

Notes _____

1. CROMWELL ARCHITECTS ENGINEERS, INC.
ALL RIGHTS RESERVED

2. THIS SHEET DESIGNED FOR COLOR PRINTING.
CRITICAL INFORMATION MAY BE LOST WITH
BLACK AND WHITE PRINTING.

Project Number _____

2024-052



07-17-2024

Sheet Title _____

LIFE SAFETY FLOOR PLAN

Sheet Number _____

GI101

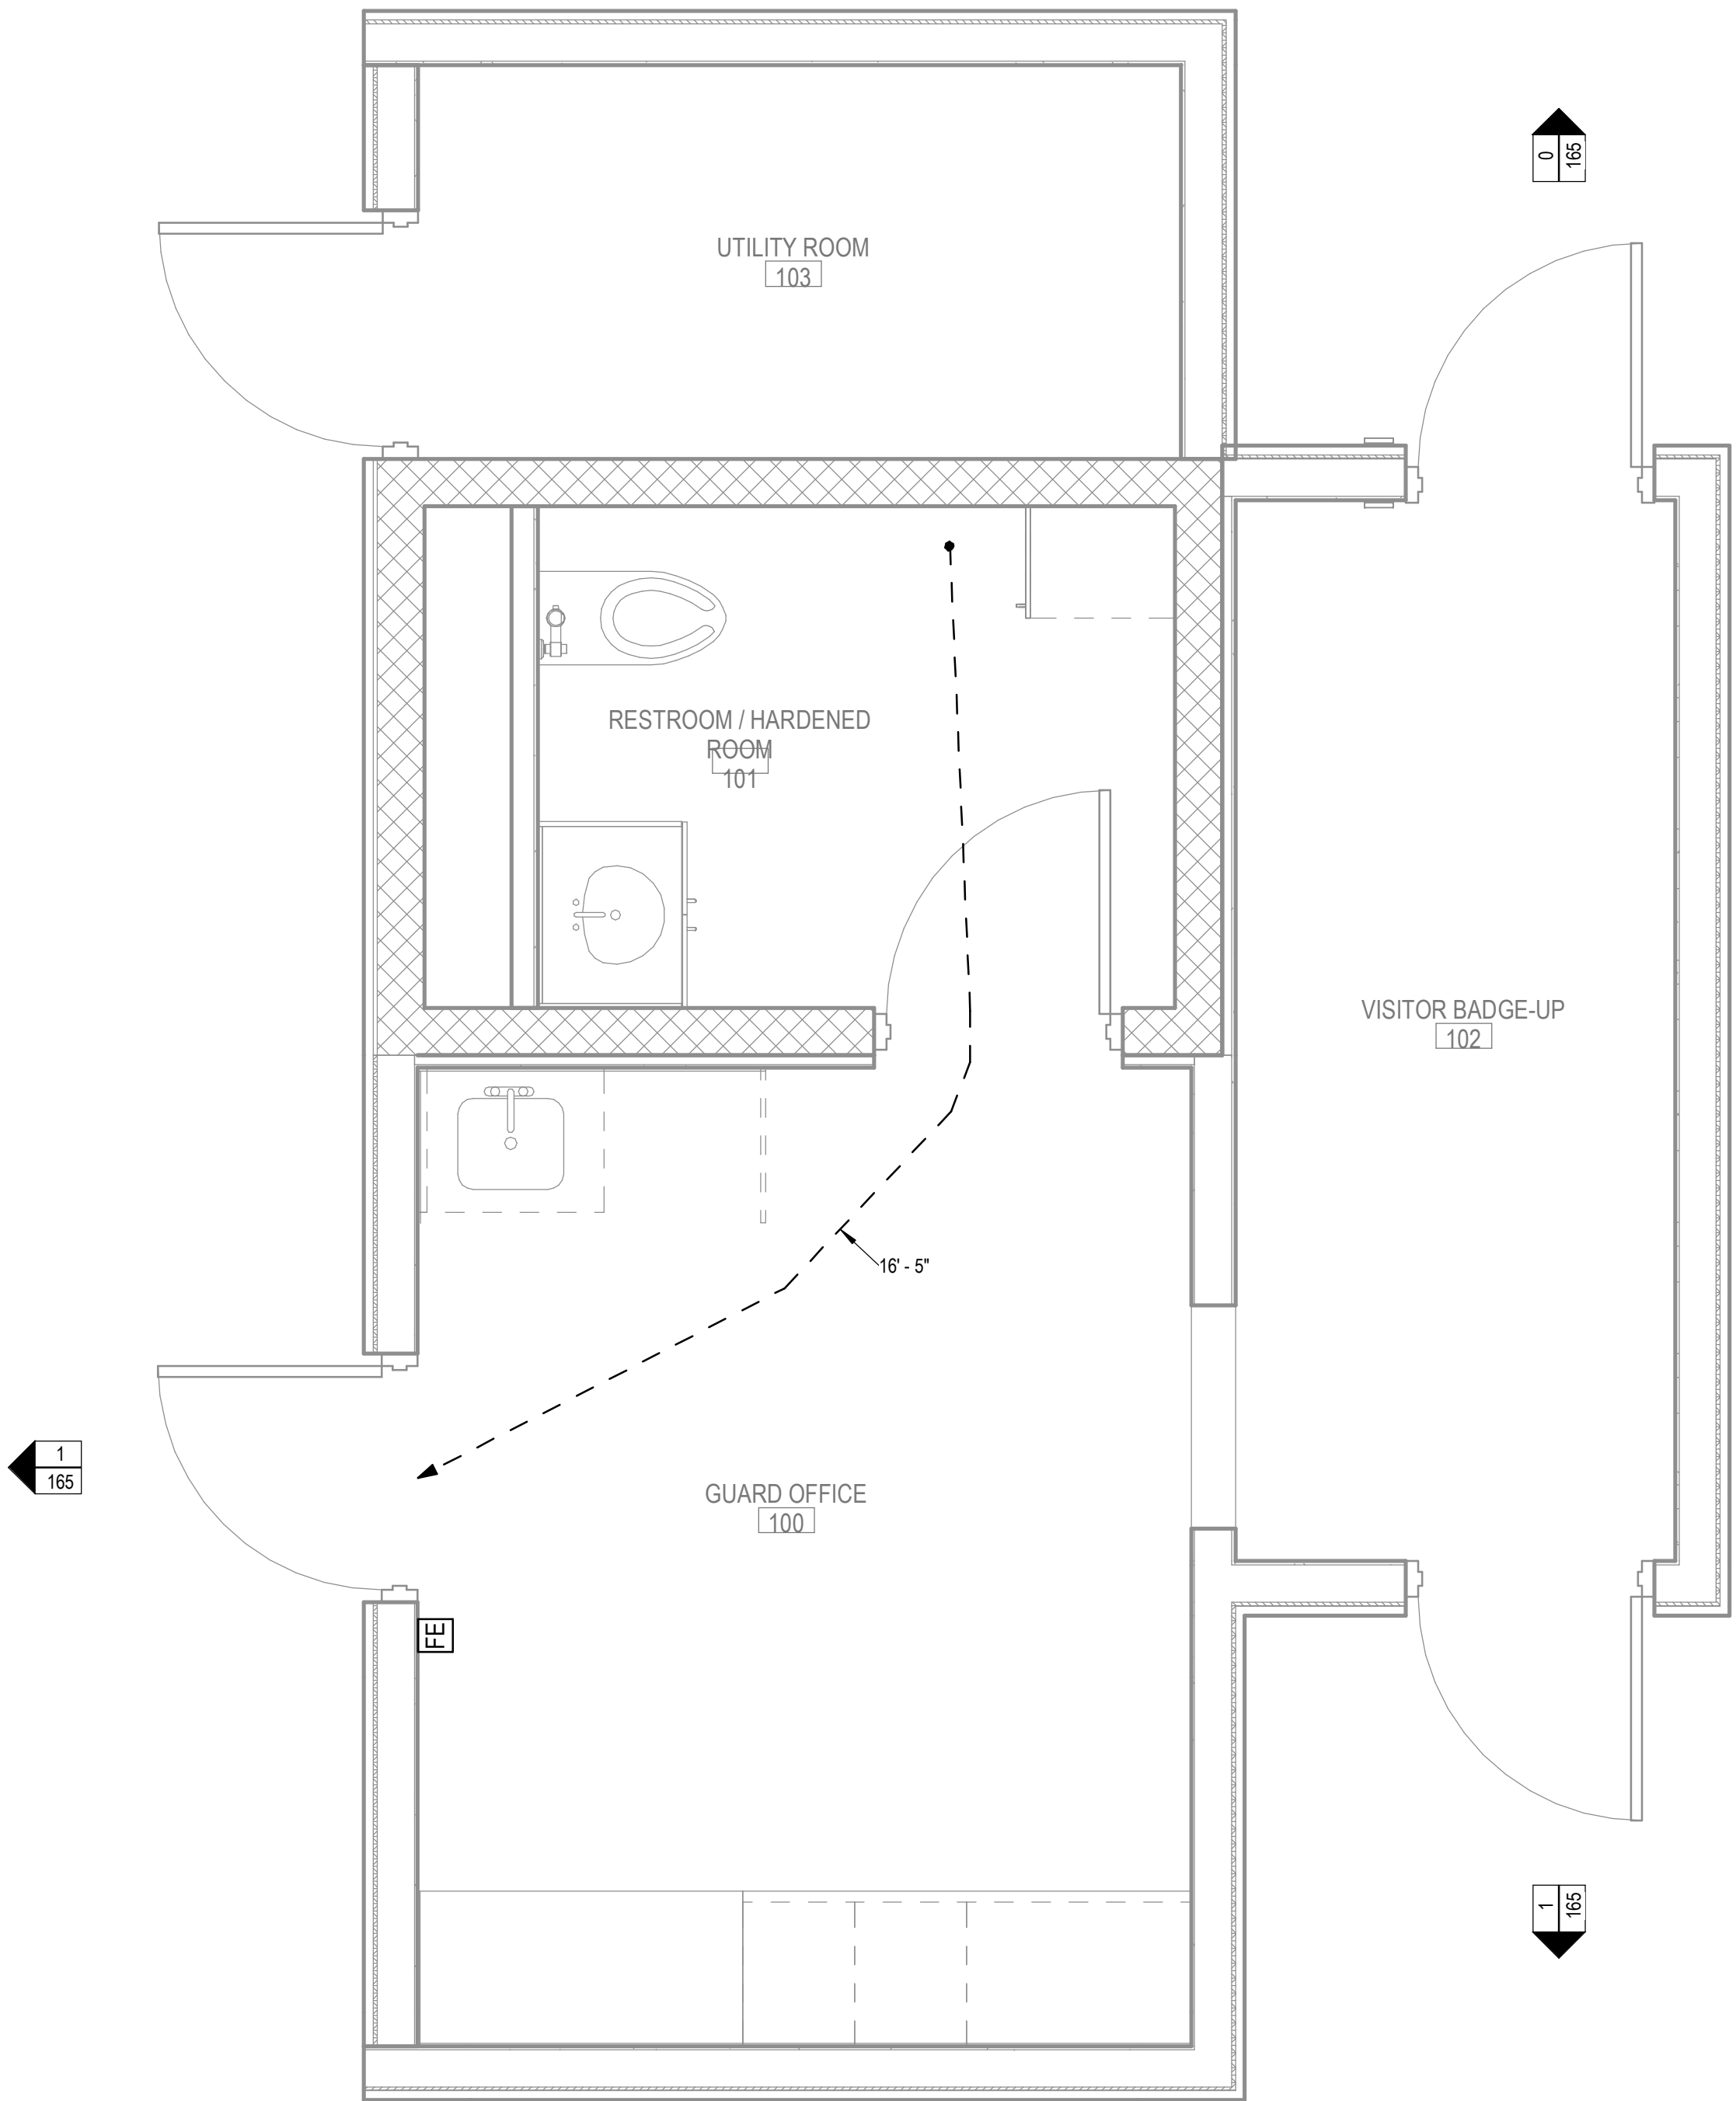
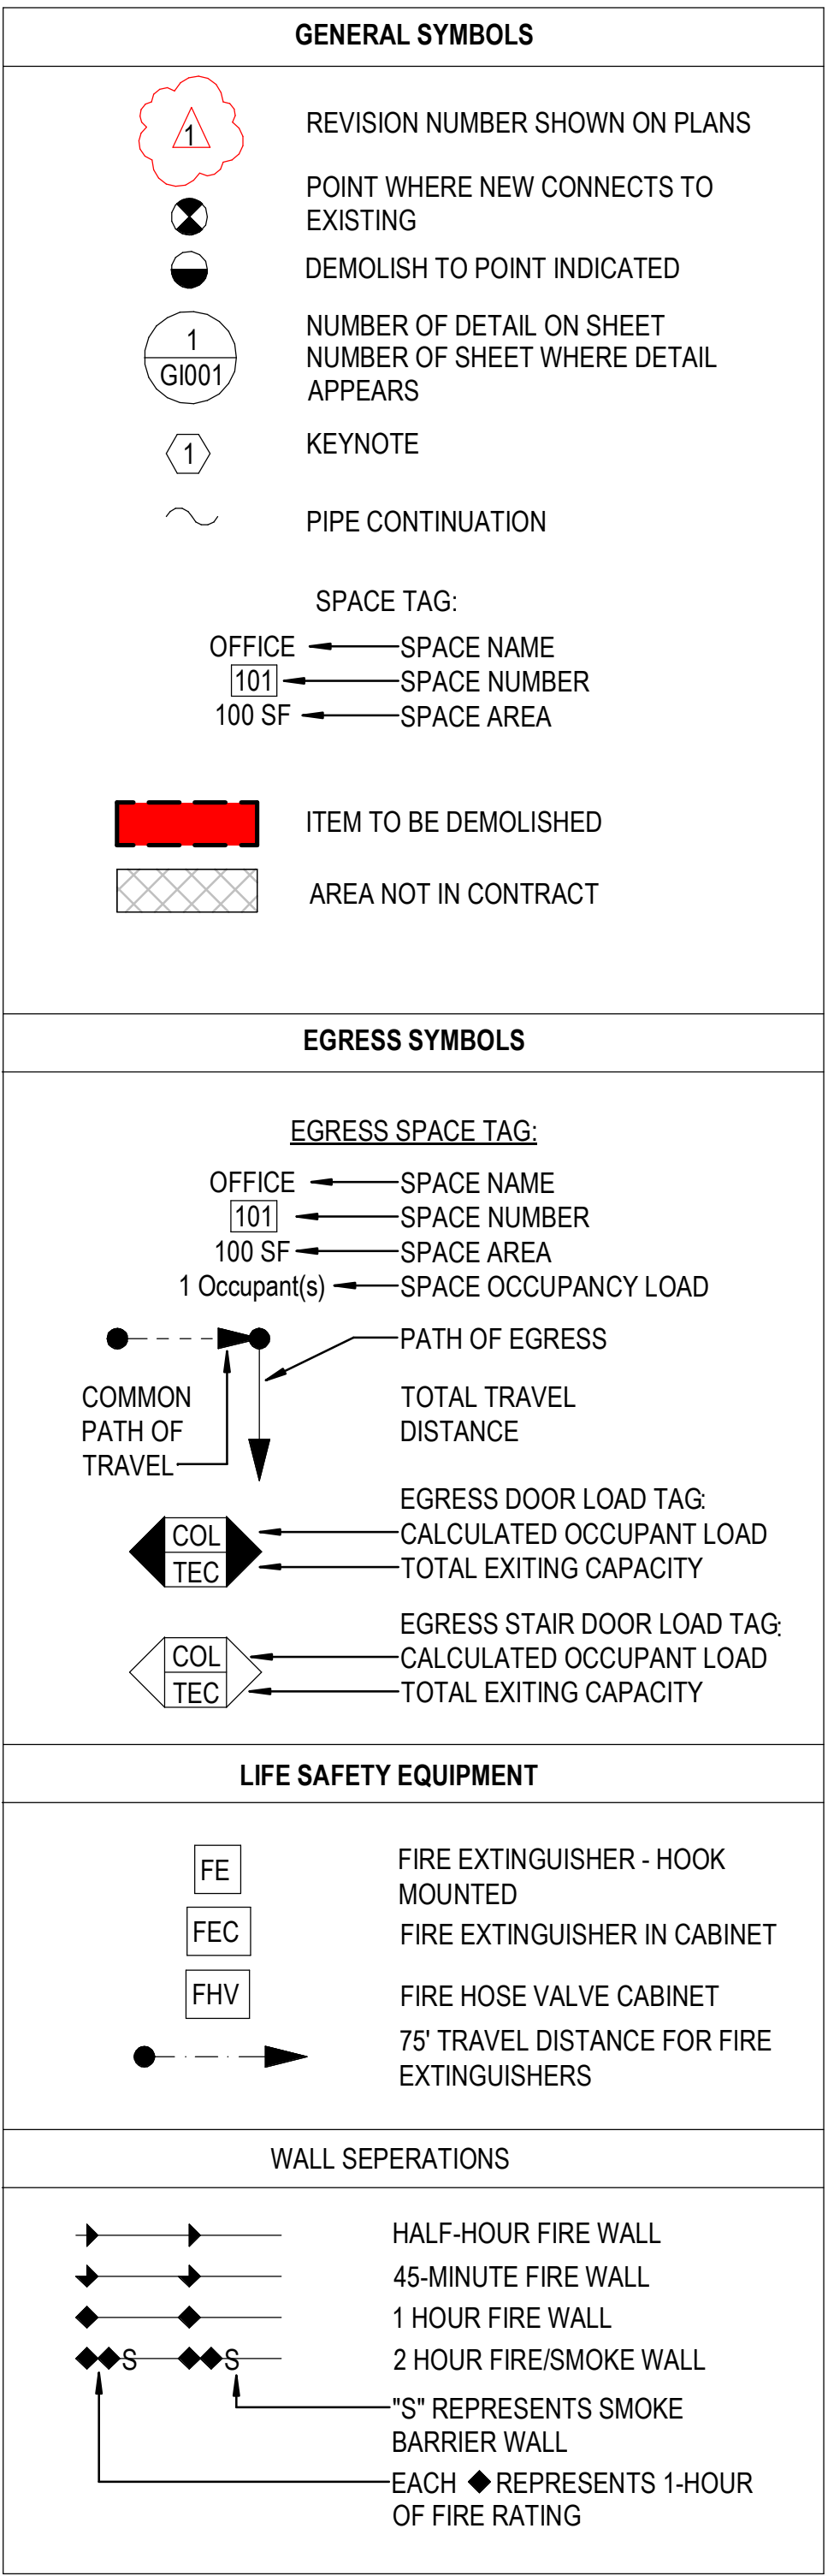


1 **LIFE SAFETY FLOOR PLAN**

1/2" = 1'-0"

0 1 2 4

NORTH

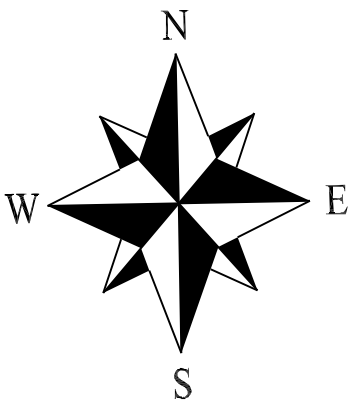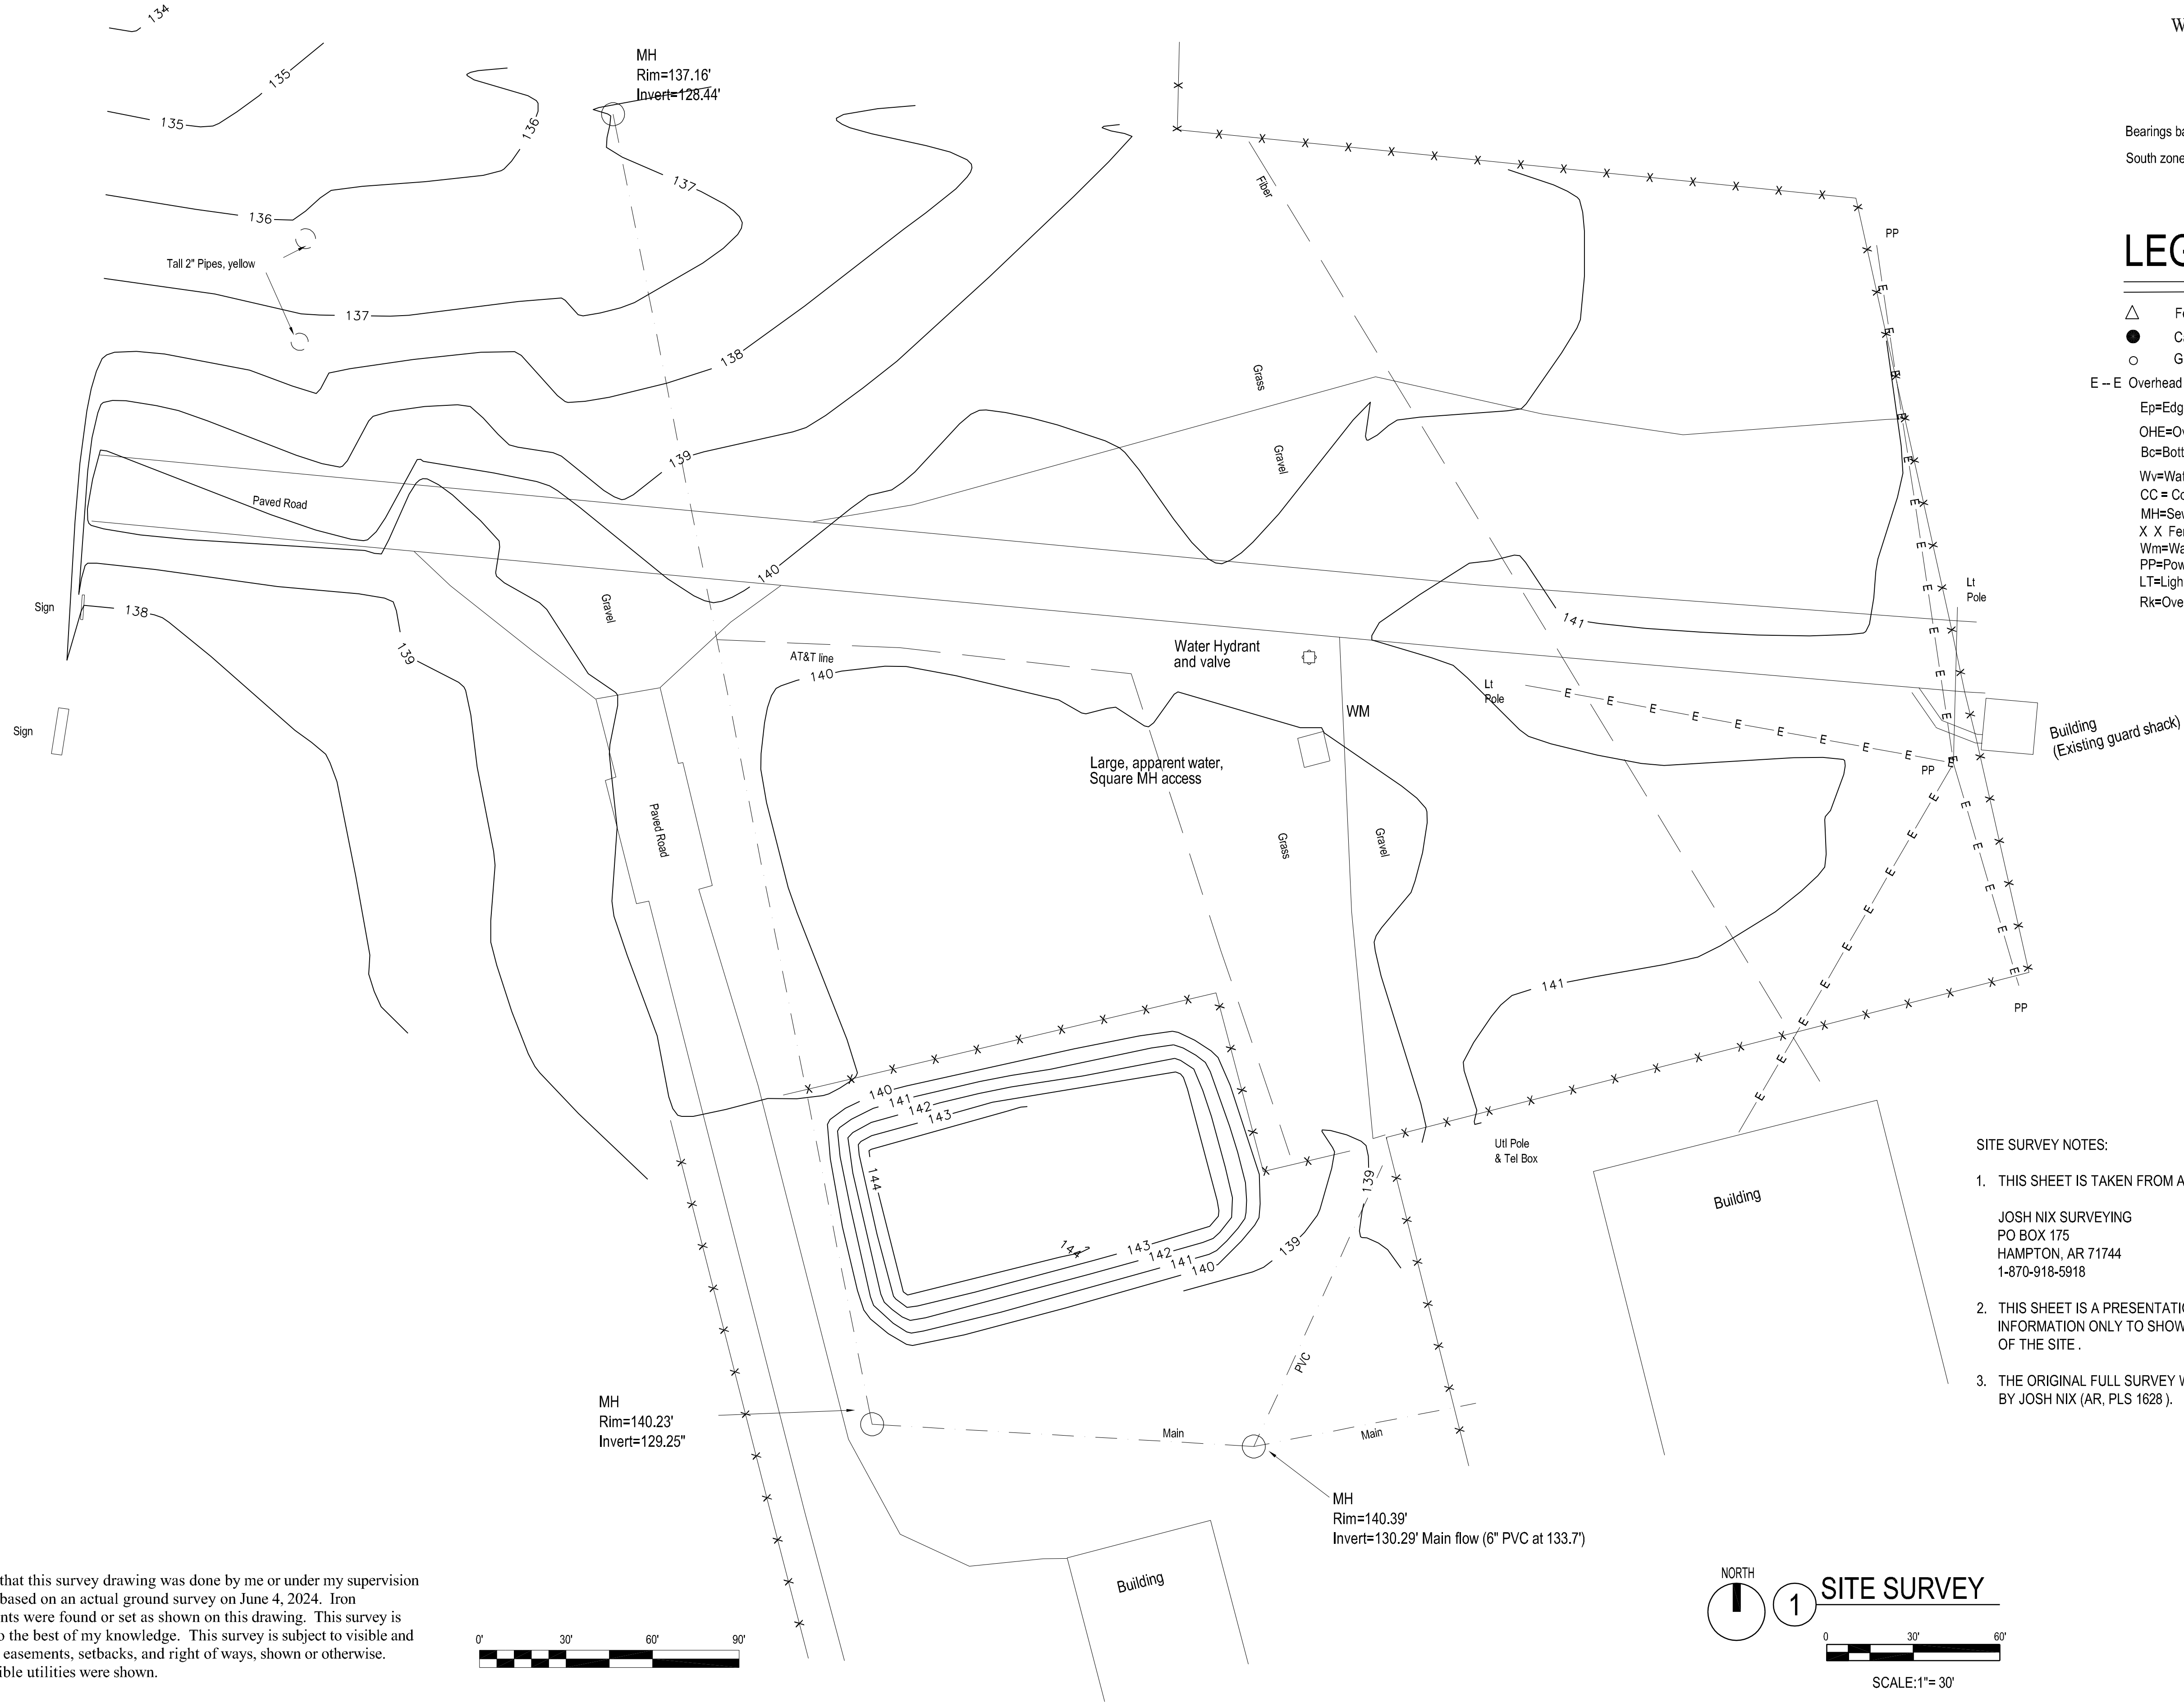

Bearings based on NAD 83, AR
South zone state pln, GPS obs.

LEGEND


- △ Found Monument
- Calculated Point
- Ground Shots (G)
- E -- E Overhead Electric
- Ep=Edge of pavement
- OHE=Overhead Electric
- Bc=Bottom of culvert
- WV=Water Valve
- CC = Concrete
- MH=Sewer Manhole
- X X Fence
- WM=Water Meter
- PP=Power Pole
- LT=Light Pole
- Rk=Overhead pipe rack

SITE SURVEY NOTES:

- THIS SHEET IS TAKEN FROM A SURVEY PROVIDED BY:

JOSH NIX SURVEYING
PO BOX 175
HAMPTON, AR 71744
1-870-918-5918
- THIS SHEET IS A PRESENTATION DRAWING FOR
INFORMATION ONLY TO SHOW THE EXISTING CONDITIONS
OF THE SITE .
- THE ORIGINAL FULL SURVEY WAS STAMPED AND SEALED
BY JOSH NIX (AR, PLS 1628).

I certify that this survey drawing was done by me or under my supervision
and was based on an actual ground survey on June 4, 2024. Iron
monuments were found or set as shown on this drawing. This survey is
correct to the best of my knowledge. This survey is subject to visible and
invisible easements, setbacks, and right of ways, shown or otherwise.
Only visible utilities were shown.

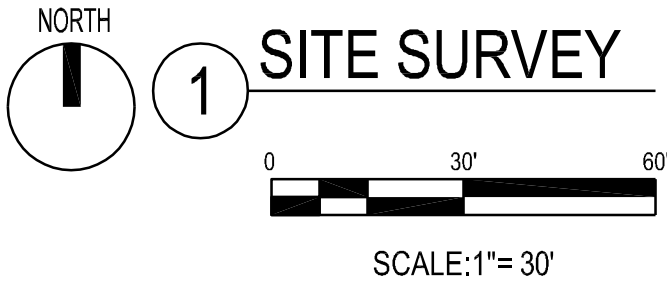

Project

AEROJET New Guard Post - 2

Design Phose

CONSTRUCTION DOCUMENTS

Revisions

No.	Date	Description

Stamp

Notes

- CROMWELL ARCHITECTS ENGINEERS, INC.
ALL RIGHTS RESERVED
- THIS SHEET DESIGNED FOR COLOR PRINTING.
CRITICAL INFORMATION MAY BE LOST WITH
BLACK AND WHITE PRINTING.

Project Number

2024-052

Issue Date

07-17-2024

Sheet Title

SITE SURVEY

Sheet Number

VF101