


AREA 1 SEE CU101

AREA 2 SEE CU102

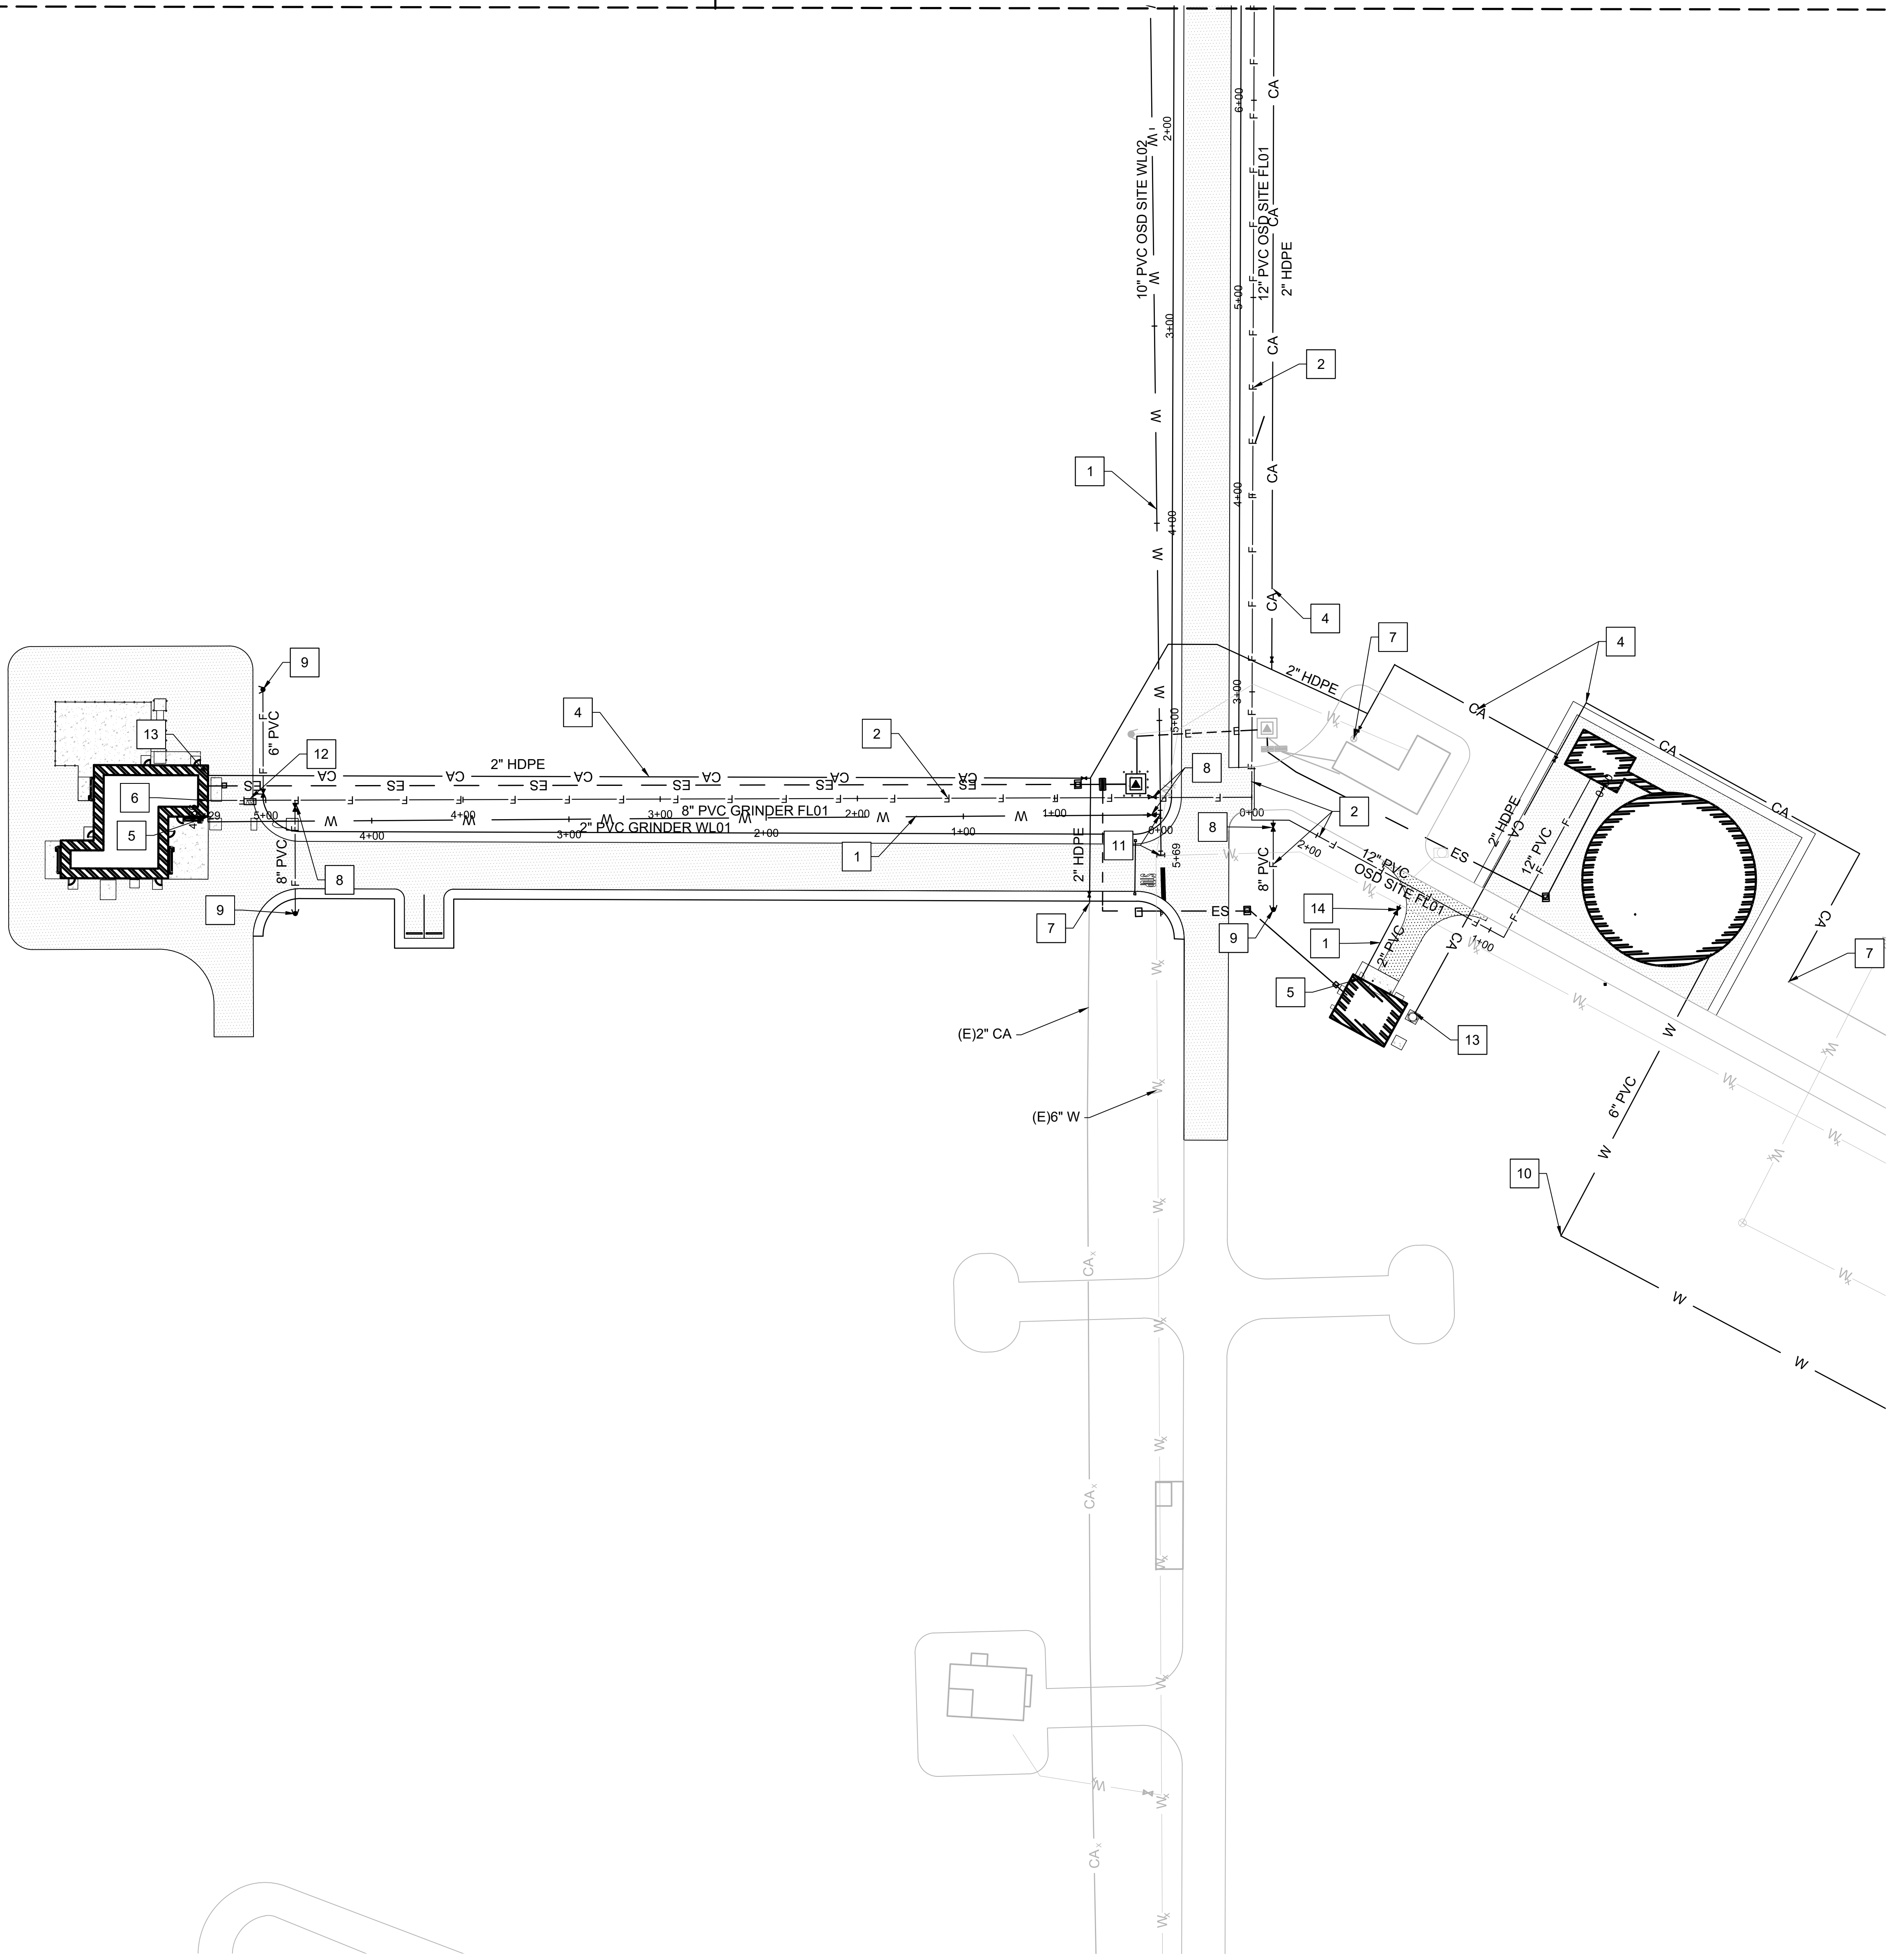

GENERAL NOTES

- BOLLARDS MUST BE INSTALLED SUCH THAT THE USE OF HYDRANT OUTLETS AND FDC INLETS ARE UNOBSTRUCTED.
- SEE ELECTRICAL DRAWINGS FOR INFORMATION ON SITE LIGHTING.
- PROVIDE THRUST BLOCKS PER DETAIL B3/CU501 AT ALL WATER LINE BENDS.
- UTILITY LINE SIZING BASED ON BUILDING LOADS FROM 60% DESIGN ON CAMDEN SITE EXPANSION.
- CONNECTION POINTS TO THE LSARM SITE. UTILITIES ARE BASED ON 30% UTILITY PLANS. UTILITY SIZING AND POCs BETWEEN PROJECTS MUST BE COORDINATED BETWEEN CONSTRUCTION CONTRACTOR AND EOR OF LSARM EXPANSION.
- SEE FIRE PROTECTION DRAWINGS FOR INFORMATION ON FIREWATER TANK/PUMPHOUSE.
- PRESSURIZED SYSTEMS MUST HAVE VALVES INSTALLED NORMALLY CLOSED AT STUB LOCATIONS.



KEYNOTES

- CONSTRUCT WATER MAIN/LATERAL. PIPE BEDDING PER DETAIL A2/CU501
- CONSTRUCT FIRE WATER MAIN/LATERAL. PIPE BEDDING PER DETAIL A2/CU501
- CONSTRUCT ELECTRICAL LINE (SEE ELECTRICAL DRAWINGS)
- CONSTRUCT 2" COMPRESSED AIR LINE. PIPE BEDDING PER DETAIL A2/CU501
- CONSTRUCT WATER STUB FOR BUILDING CONNECTION PER DETAIL B4/CU502
- CONSTRUCT FIRE WATER STUB FOR BUILDING CONNECTION PER DETAIL B4/CU502
- CONSTRUCT TIE INTO EXISTING COMPRESSED AIR SYSTEM PER DETAIL D4/CU502
- CONSTRUCT WATER VALVE PER DETAIL A1 AND A3/CU501
- CONSTRUCT FIRE HYDRANT PER DETAIL A5/CU501
- CONSTRUCT FIRE WATER FILL LINE. BEDDING PER DETAIL A2/CU501
- CONSTRUCT TAPPING SLEEVE AND VALVE CONNECTION PER DETAIL A3/CS503
- CONSTRUCT POST INDICATOR VALVE PER DETAIL B6/CU502
- CONSTRUCT COMPRESSED AIR STUB FOR BUILDING CONNECTION PER DETAIL B4/CU502
- CONSTRUCT CORP STOP CONNECTION INTO EXISTING 6" WATER MAIN PER DETAIL A1/CU503


LEGEND

CA	COMPRESSED AIR
W	DOMESTIC WATER
G	NATURAL GAS
F	FIRE WATER
ES	ELECTRICAL
[Symbol]	SITE LIGHTING
[Symbol]	WATER VALVE
[Symbol]	WATER VALVE NC
[Symbol]	FIRE HYDRANT
[Symbol]	AIR RELIEF VALVE
[PIV]	POST INDICATOR VALVE
[X]	ELECTRICAL EASEMENT
ES	ELECTRICAL SECONDARY
WK	EXISTING WATER
G <sub>x</sub>	EXISTING NATURAL GAS
SS <sub>x</sub>	EXISTING SANITARY SEWER
E <sub>x</sub>	EXISTING ELECTRICAL
C <sub>x</sub>	EXISTING COMPRESSED AIR

KEY PLAN

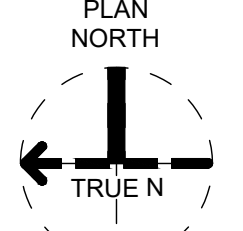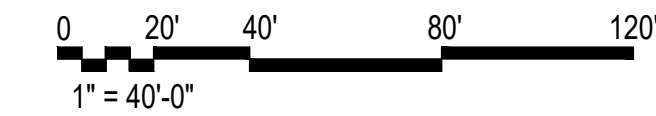

A1 SITE UTILITY PLAN - AREA 3  
SCALE 1" = 40'

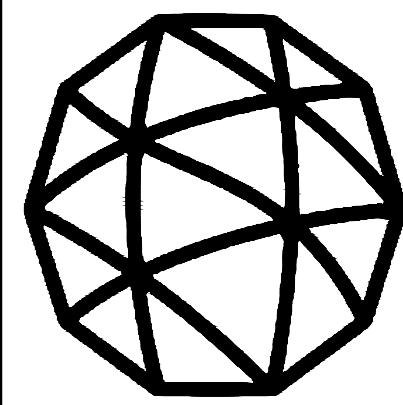

Site Development  
Camden OSD  
Camden, Arkansas  
Aerjet Rocketdyne

NO.	DATE	REVISION	BY	APPROVED	DR	DGN
B	2024-07-19	100% ISSUED FOR CONSTRUCTION - DEVELOPMENT	DS	TM		
A	2024-07-01	100% ISSUED FOR REVIEW - DEVELOPMENT	DS	TM		

SHEET NO	CU103
SCALE	AS SHOWN
DATE	07/01/2024
PROJ	D3547405
DWG	CU103.dwg
SHEET	50 of 99