


GENERAL NOTES:



- A. ELECTRICAL GEAR IS CRITICAL TO PRODUCTION. SHUTDOWNS DURING SWITCHBOARD MODIFICATION SHALL BE KEPT TO MINIMUM POSSIBLE. NO MORE THAN 24 HOURS. SHUTDOWNS SHALL BE COORDINATED WITH OWNER IN LINE WITH PRODUCTION HOURS.
- B. INFORMATION REGARDING EXISTING CONDITIONS WAS TAKEN FROM CASUAL SITE OBSERVATIONS. INFORMATION MAY BE INCOMPLETE. VERIFY AND DOCUMENT EXISTING CONDITIONS PRIOR TO DEMOLITION.
- C. REMOVE CONDUIT AND CONDUCTORS OF DEMOLISHED CIRCUITS TO THE POINT OF ORIGIN (SWITCHBOARD FOR CIRCUITS TO BE COMPLETELY REMOVED AND J-BOX FOR CIRCUITS TO BE MODIFIED. RENAME DEMOLISHED CIRCUIT BREAKER / FUSE IN SWITCHBOARD TO SPARE.
- D. REMOVE AIR TERMINALS ON FLUES BEING DEMOLISHED.
- E. REMOVE LIGHTNING CONDUCTOR WHERE AIR TERMINAL HAS BEEN REMOVED BACK TO SPLICE POINT.
- F. ALL MODIFICATIONS DONE TO THE LIGHTNING PROTECTION SYSTEM SHOULD MAINTAIN EXISTING UL LISTING.

KEYED NOTES:


- ① DEMOLISH RECEPTACLE BACK TO EXISTING RECEPTACLE SERVING BOILER 1. PRESERVE CIRCUIT FOR NEW RECEPTACLE.
- ② DEMOLISH ELECTRICAL EQUIPMENT AND CIRCUIT BACK TO SOURCE. RE TO 1E-501.
- ③ DEMOLISH LOW VOLTAGE CONDUCTOR TO BOILER 1. DEMOLISH ALL CONNECTIONS ASSOCIATED TO BOILER 2 IN THE GUARD SHACK ALARM PANEL. RE 1 / E-501 FOR APPROXIMATE CONDUCTOR LOCATION.
- ④ REFER TO SINGLE LINE DIAGRAM FOR CIRCUIT INFORMATION.
- ⑤ CONNECT RECEPTACLE TO EXISTING CIRCUIT SERVING BOILER 1.
- ⑥ JUNCTION BOX POWERS STEAM FLOW METER. COORDINATE EXACT LOCATION WITH INSTALLER.

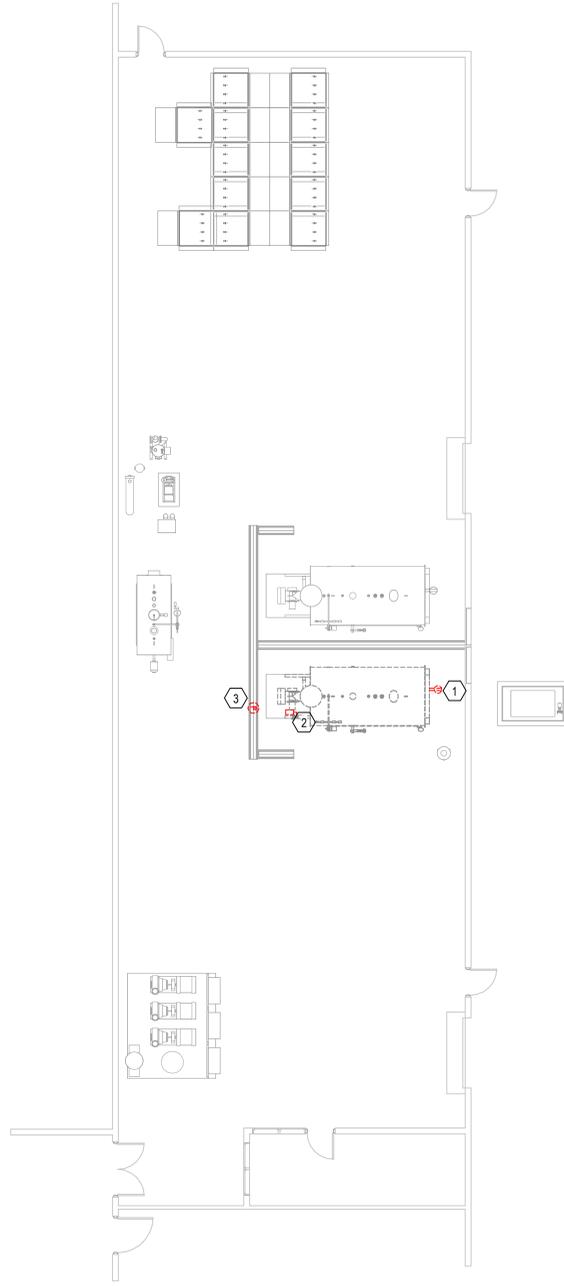

2 DEMOLITION PLAN
 1/8" = 1'-0"

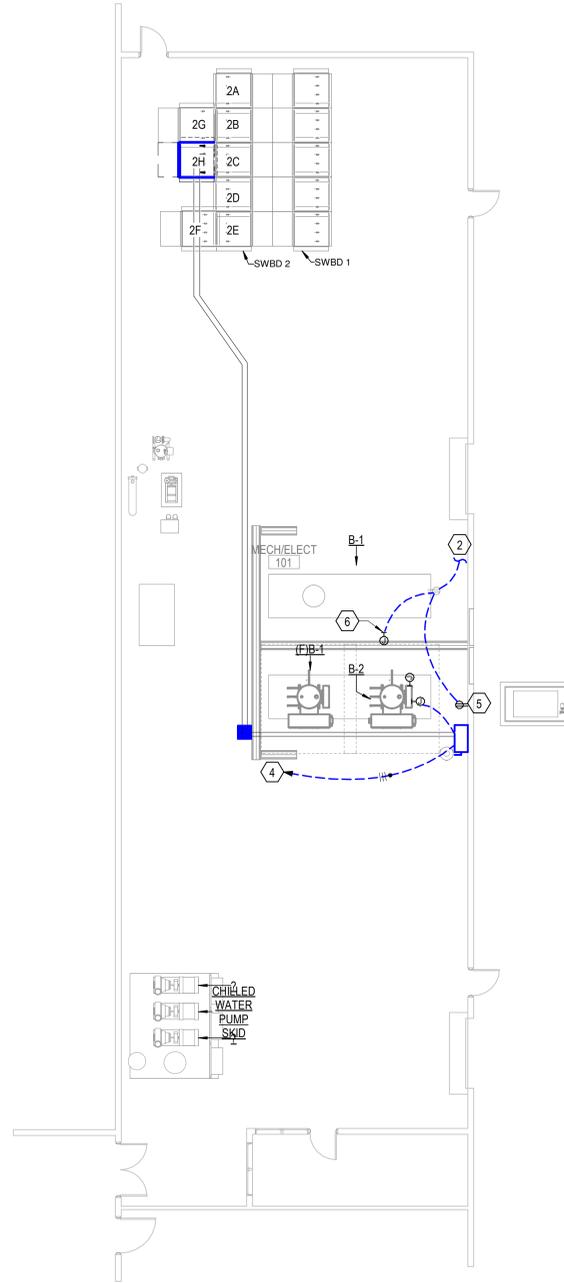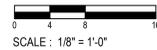

1 ELECTRICAL POWER PLAN
 1/8" = 1'-0"

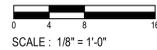

L'Oreal USA Products
NLR - BOILER REPLACEMENT
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Design Phase
CONSTRUCTION DOCUMENTS

Revisions	No.	Date	Description

Stamp

Notes

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ELECTRICAL POWER PLAN

Sheet Number
E-101